AGENDA

SPECIAL CALL MEETING

Meeting of the Town of Biltmore Forest Board of Commissioners

To be held Tuesday, March 12, 2024 at 3:30 p.m.

 Review and receive information regarding the Facility Needs Master Planning Process DP3 Architects McGill Engineering

Statement of Purpose for Special Call Meeting

Pursuant to NCGS 160A-71, the Town of Biltmore Forest Board of Commissioner will hold a special call meeting. The purpose of this special call meeting is to receive information from the Town's contracted architect, DP3, regarding the ongoing facility needs master planning process.

BOARD OF COMMISSIONERS SPECIAL CALL MEETING STAFF MEMORANDUM MARCH 12, 2024





Background

The Town selected DP3 Architects to conduct a facility master planning process in fall 2023. DP3 and their civil engineer consultant, McGill and Associates, began this work with a space needs analysis and site surveys in December 2023. Staff met with the architect and engineers in late February to review their initial site options and provide initial feedback.

Progress Meeting

As part of their agreement with the Town, a progress meeting with the Board of Commissioners was planned to review their initial findings and site options. We are now at that part of the process. The purpose of this special call meeting is for the Board to review initial findings and options, and then for the Board to provide feedback and direction to move the project forward.



POLICE DEPARTMENT

PRELIMINARY SPACE LIST REPORT

	S	PACE REQUIREMENTS	ROOMS	NSF	TOTAL
	1.	Provide 100% generator backup.			
	DII	BLIC AREAS			
I.	PU	blic areas			
	A.	Public Lobby 1. Secure Lobby from remainder of building	1	180	180
		Provide secure transaction window to Dispatch with transaction tray			
		Provide seating for 4 people			
	В.	Public Restroom	1	60	60
		1. Single-use, unisex, accessible			
		Locate with direct access from Lobby			
	PU	BLIC AREAS Subtotal			240
II.	OF	FICE AREAS			
	A.	Dispatch Area	1	120	120
		Bullet-resistant construction at all exterior walls			
		 Provide space for one dispatch station Provide a small kitchenette break area counter within the Dispatch Area (microwave, 			
		coffee maker, sink, toaster oven, refrigerator)			
		6. Provide indirect lighting in room			
		Provide additional HVAC to handle heat loads from computer equipment			
	B.	Dispatch Restroom	1	60	60
		Locate within the Dispatch Area			
	C.	Dispatch IT Server Room	1	60	60
		Independent Climate Control.			
	D.	Interview/Conference Room	1	80	80
		 Concrete block walls; sound dampening Provide acoustic control for excellent audio recording; video equipment needed 			
		2. I Tovide acoustic control of excellent addio recording, video equipment needed			
		Locate with direct access from Lobby			
	E.	Chief's Office	1	216	216
		1. Provide space for desk, credenza, and 6 person conference table.			
	F.	Captain's Office	1	150	150
		Provide space for desk, credenza, and side chairs			
	F.	Lieutenant's Office	1	150	150
		Provide space for desk, credenza, and side chairs			
	G.	Communications Manager Office	1	120	120
		Provide space for desk, credenza, and side chairs			
	H.	Sergeant's Office	1	240	240
		Provide space for 2 desks, credenza, and side chairs			
	I.	Visiting Law Enforcement Office	1	120	120
		Provide space for desk, credenza, and side chairs			
	J.	Command Staff Restroom	1	80	80
		 Single-use, unisex, accessible Locate with direct access from Lobby 			
		2. Locato with direct access from Lobby			





POLICE DEPARTMENT

PRELIMINARY SPACE LIST REPORT

	S	PACE REQUIREMENTS	ROOMS	NSF	TOTAL
	1.	Provide 100% generator backup.			
	K.	Supplies/Workroom 1. Copier 2. Base Cabinet with work counter and overhead cabinets for supplies	1	160	160
	OF				4 550
	UFI	FICES AREAS Subtotal			1,556
III.	OPI	ERATIONS AREAS			
	A.	Staff Entrance Lobby 1. Security card access	1	60	60
	B.	Interview Room 1. Concrete block walls; sound dampening 2. Provide acoustic control for excellent audio recording; video equipment needed	1	80	80
		Locate with direct access from Lobby			
	C.	 Roll Call/Training Room Provide seating for 24 people at lecture tables; provide lectern Provide countertop in room for radio chargers, banks of radios, and bodycams, etc. 	1	576	576
		 Provide built-in mail slots (8 1/2" x 11" flat slots) for Police Staff Provide TVs and White Board Locate near Staff Entry Lobby 			
	D.	Roll Call/Training Room Storage 1. Provide storage space for training equipment	1	150	150
	E.	 Breakroom Provide with full-size refrigerator/freezer, microwave, residential oven/stove, coffee maker with water line, dishwasher, and vending Dining seating for 6-8 people 	1	320	320
	F.	 Men's Locker Room Provide space for 20 full height, enclosed lockers (16"w x 24"d) Provide with one full size accessible shower (36x60), and dressing area with bench, robe hooks, towel bars, and toiletry shelf. 	1	500	500
	G.	 Women's Locker Room Provide space for 10 full height, enclosed lockers (16"w x 24"d) Provide with one full size accessible shower (36x60), and dressing area with bench, robe hooks, towel bars, and toiletry shelf. 	1	250	250
	H.	Garage 1. Locate in close proximity to Roll Call/Duty Room 2. Drive-in/back-out type for 1 car with solid roll-up door 3. Provide with floor drain and hose bibb 4. Parking space for UTV and Patrol Bike	1	600	600
	I.	Fitness Room 1. Functional Fitness - Crossfit, Free Weights, Rubber Weights, Bench press, Squat rack, Rowing machine, Elliptical, Stationary Bike (Assault), Cable machine	1	300	300
		2 Drinking fountain with bottle filler			





POLICE DEPARTMENT

PRELIMINARY SPACE LIST REPORT

	SI	PACE REQUIREMENTS	ROOMS	NSF	TOTAL
	1.	Provide 100% generator backup.			
	J.	Armory Storage 1. Provide discharge cabinet, long gun storage racks. 2. Provide shelving for storage of ammunition. 3. Provide countertop for cleaning/maintenance of weapons	1	150	150
	K.	Patrol Equipment Storage 1. Adjacent to Roll Call Room 2. Shelving and cabinets for shields, specialized equipment, flashlights, belts, vests, tactical shields, etc.	1	150	150
	L.	Uniform Storage Room 1. Storage for uniforms.	1	150	150
	M.	Evidence Custodian/Processing Adjacent and connected to Evidence Storage Adjacent to Officer Evidence Pass-Through Drop Lockers Stainless Steel countertops for evidence preparing Dutch door for transfer of evidence to officers; security card access; dead bolt	1	210	210
	N.	Evidence Storage 1. General property area with high density shelving 2. Locate adjacent to Staff Entry/Evidence Drop 3. Provide security access control. 4. Extend walls to deck above for security 5. Provide double access (front/rear) evidence lockers - deposited off of Staff Entry/Evidence Drop, received on Evidence Storage side. 6. Provide a pass through drug deposit for officers to deposit drug evidence. 7. Provide exhaust fan. 8. Provide stainless steel work counters and a work table for destruction process. 9. Storage types within room:	1	200	200
		a. Large Evidence Storage - separate large room, bikes, etc. b. Refrigerator (rape kits) - 1 full size c. Drugs - separate, lockable storage off of main storage. d. Firearms - separate, lockable storage off of main storage (2 gun safes).	1 1 1	100 50 80	100 50 80
	Ο.	General Storage 1. Storage racks for storage of misc. equipment/records	1	370	370
	P.	De-Escalation/Calming/Maternity Room 1. Provide with two comfortable chairs. 2. Provide with 3' base cabinet, small sink, and undercounter refrigerator 3. Provide with dimmable lighting	1	80	80
	OPE	ERATIONS AREAS Subtotal			4,376
IV.	BUI	LDING SUPPORT AREAS			
	A.	Mechanical/Electrical Equipment Room	1	150	150
	B.	Server Room 1. Closet for IT Server, Camera system, and access control system.	1	80	80





POLICE DEPARTMENT

PRELIMINARY SPACE LIST REPORT

SPACE REQUIREMENTS	ROOMS	NSF	TOTAL
1. Provide 100% generator backup.			
Janitor's Closet Mop sink, cleaning supply storage/shelving Provide floor drain	1	50	50
 D. Animal Control - Stray Dog Kennels 1. Provide covered, caged, animal runs. 2. Provide Countertop and deep sink for food prep. 3. Provide storage area for food bin storage. 4. Soundproof room 	2	40	80
BUILDING SUPPORT AREAS Subtotal			360
TOTAL NET AREA This area represents the actual usable programmed space for the functional areas identified above. TOTAL GROSS AREA	1.20	6,532	6,532 7,838
This total area represents the entire projected building footprint of all enclosed areas. This includes programmed net area plus a 1.20 net to gross (80/20) multiplier used to estimate space for walls and circulation areas.			
V. OUTDOOR AREAS			
A. Covered Dining Patio1. Provide space for 8 people at picnic tables and chairs and gas grill.	1	250	250
OUTDOOR AREAS Subtotal			250





PUBLIC WORKS

PRELIMINARY SPACE LIST REPORT

S	PACE REQUIREMENTS	ROOMS	NSF	TOTAL
1.	Provide 100% generator backup.			
2	Provide secure fencing at perimeter of site with rolling security gate.			
_	The first occurs for the first of the first occurs, gate.			
OPI	ERATION AREAS			
A.	Muster/Briefing Room	1	420	42
	 Provide seating for 8-12 people at training tables (20 SF/person). 			
	Provide with TV's/recessed floor power& data.			
	3. Provide space for microwave, refrigerator, single bowl sink with disposal, and bulk ice			
	machine.4. Provide work counter for touchdown computer workstations (4).			
	4. Provide work counter for touchdown computer workstations (4).			
B.	Laundry Room	1	120	12
	Provide with laundry tub, washer, and dryer.			
C.	Covered Vehicle Storage Bays (Non-Enclosed/Non-Heated)	8	525	4,20
О.	Provide drive-thru heavy-duty vehicle parking bays (15'W x 35' L x 15' H).	0	323	4,20
	Tronds drive that heavy daty verilose parking says (10 11 x 00 2 x 10 11).			
D.	Covered Vehicle Storage Bays (Enclosed/Heated)	7	800	5,60
	1. Provide drive-thru heavy-duty vehicle parking bays (16'W x 50' L x 25' H).			
	2. Provide each bay with a solid 14' x 14' roll-up door with single vision strip.			
	3. Provide with single trench located at inside face of all exterior overhead doors.			
	4. Ventilation only with gas heat and HVLS fans.			
E.	Covered Vehicle Maintenance Bay (Enclosed/Heated)	1	800	80
	1. Provide drive-thru heavy-duty vehicle maintenance bay (16'W x 50' L x 25' H).	•		-
	2. Provide bay with a solid 14' x 14' roll-up door with single vision strip.			
	3. Provide with single trench located at inside face of all exterior overhead doors.			
	Ventilation only with gas heat and HVLS fans.			
	5. Provide with 4 portable lifts.			
	6 Provide with table lift for small equipment repairs.			
	7. Provide bay with overhead drops for compressed air.			
	8. Provide 4' workbench area.			
	9. Provide with semicircular foot-operated wash fountain.			
	10. Provide space for flammable storage cabinet.			
F.	Vehicle Wash Bay	1	800	80
	1. Provide one covered/enclosed drive thru wash lane at end of building (16'W x 50' L x			
	25' H).			
	Provide with single wide mouth trench down center of bay tied to oil/eater separator.			
	3. Provide bay with a solid 14' x 14' roll-up door with single vision strip.			
	4. Provide raised walk platform at one side of drive lane.			
	5. Provide with pressure washers at the ground and platform.			
G.	Trash Bin Storage Room	1	300	30
	Provide one covered/enclosed room for storage of rolling trash carts.			
	2. Provide room with pair of 3'-0" x 7'-0" doors.			
OP	ERATION AREAS Subtotal			12,240
011	LICATION AILEAU GUDIOIGI			14,24





PUBLIC WORKS

PRELIMINARY SPACE LIST REPORT

	SPACE REQUIREMENTS	ROOMS	NSF	TOTAL
1. 2	Provide 100% generator backup. Provide secure fencing at perimeter of site with rolling security gate.			
II. B	UILDING SUPPORT AREAS			
A.	Staff Restroom 1. Provide single-use, unisex, accessible restroom with sink, toilet, and urinal.	1	80	80
В.	Staff Sower 1. Provide single-use, unisex, accessible shower room with 36" x 60" shower, and bench.	1	80	80
C.	Mechanical/Electrical Equipment Room	1	100	100
D.	Janitor's Closet Closet to contain a mop sink and storage shelving.	1	80	80
E.	Server Closet	1	40	40
В	UILDING SUPPORT AREAS Subtotal			380
TO	This area represents the actual usable programmed space for the functional areas identified above.			12,620
	This area represents the actual usable programmed space for the functional areas	1.20	12,620	12,620 15,144
	This area represents the actual usable programmed space for the functional areas identified above.	1.20	12,620	ŕ
т	This area represents the actual usable programmed space for the functional areas identified above. DTAL GROSS AREA This total area represents the entire projected building footprint of all enclosed areas. This includes programmed net area plus a 1.20 net to gross (80/20) multiplier used to	1.20	12,620	ŕ
т	This area represents the actual usable programmed space for the functional areas identified above. DTAL GROSS AREA This total area represents the entire projected building footprint of all enclosed areas. This includes programmed net area plus a 1.20 net to gross (80/20) multiplier used to estimate space for walls and circulation areas. JEL ISLAND Fuel Pumping Station 1. Provide 2 pumps plus DEF at 1 fueling island (2 vehicles serviced at a time). Canopy is desired but optional. 2. Fuel includes diesel only and DEF.	1.20	12,620 2,000	15,144
III. FU	This area represents the actual usable programmed space for the functional areas identified above. DTAL GROSS AREA This total area represents the entire projected building footprint of all enclosed areas. This includes programmed net area plus a 1.20 net to gross (80/20) multiplier used to estimate space for walls and circulation areas. JEL ISLAND Fuel Pumping Station Provide 2 pumps plus DEF at 1 fueling island (2 vehicles serviced at a time). Canopy is desired but optional. Fuel includes diesel only and DEF.			ŕ





PUBLIC WORKS

PRELIMINARY SPACE LIST REPORT

1. Provide 100% generator backup. 2 Provide secure fencing at perimeter of site with rolling security gate. IV. OUTDOOR COVERED STORAGE AREAS A. Equipment Storage 1. Provide bay for two (2) TomCats. (10x20) 2. Provide bay for three (3) 6' mowers. (10x20) 3. Provide bay for material storage (20' long area for 10 "sticks" on a rack). (10x20) 4. Provide bay for storage of plows. (10x20) 5. Provide bay for storage of spreaders. (10x20) OUTDOOR UNCOVERED STORAGE AREAS Subtotal 1. OUTDOOR UNCOVERED STORAGE AREAS A. Material Bins 1. Provide (5) 20'x20' concrete pads with 8' high perimeter walls for ABC stone/rock, Topsoil, Mulch, Sand, and Riprap. 2. Provide (1) 20'x20' covered concrete pads with 8' high perimeter walls for salt. OUTDOOR UNCOVERED STORAGE AREAS Subtotal OUTDOOR UNCOVERED STORAGE AREAS Subtotal 2.400		SP	ACE REQUIREMENTS	ROOMS	NSF	TOTAL
A. Equipment Storage 1. Provide bay for two (2) TomCats. (10x20) 2. Provide bay for three (3) 6' mowers. (10x20) 3. Provide bay for material storage (20' long area for 10 "sticks" on a rack). (10x20) 4. Provide bay for storage of plows. (10x20) 5. Provide bay for storage of spreaders. (10x20) OUTDOOR UNCOVERED STORAGE AREAS Subtotal 1,000 V. OUTDOOR UNCOVERED STORAGE AREAS A. Material Bins 1. Provide (5) 20'x20' concrete pads with 8' high perimeter walls for ABC stone/rock, Topsoil, Mulch, Sand, and Riprap. 2. Provide (1) 20'x20' covered concrete pads with 8' high perimeter walls for salt. 3. Provide (1) 20'x20' covered concrete pads with 8' high perimeter walls for salt.			· · · · · · · · · · · · · · · · · · ·			
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 V. OUTDOOR UNCOVERED STORAGE AREAS A. Material Bins 1. Provide (5) 20'x20' concrete pads with 8' high perimeter walls for ABC stone/rock, Topsoil, Mulch, Sand, and Riprap. 2. Provide (1) 20'x20' covered concrete pads with 8' high perimeter walls for salt. 3. Provide (1) 20'x20' covered concrete pads with 8' high perimeter walls for salt. 			 Provide bay for two (2) TomCats. (10x20) Provide bay for three (3) 6' mowers. (10x20) Provide bay for material storage (20' long area for 10 "sticks" on a rack). (10x20) Provide bay for storage of plows. (10x20) 	5	200	1,000
 V. OUTDOOR UNCOVERED STORAGE AREAS A. Material Bins 1. Provide (5) 20'x20' concrete pads with 8' high perimeter walls for ABC stone/rock, Topsoil, Mulch, Sand, and Riprap. 2. Provide (1) 20'x20' covered concrete pads with 8' high perimeter walls for salt. 3. Provide (1) 20'x20' covered concrete pads with 8' high perimeter walls for salt. 		OUT	DOOR UNCOVERED STORAGE AREAS Subtotal			1 000
	V.	A.	Material Bins 1. Provide (5) 20'x20' concrete pads with 8' high perimeter walls for ABC stone/rock, Topsoil, Mulch, Sand, and Riprap.	6	400	2,400
OUTDOOR UNCOVERED STORAGE AREAS Subtotal 2,400			3. Provide (1) 20'x20' covered concrete pads with 8' high perimeter walls for salt.			
		OUT	DOOR UNCOVERED STORAGE AREAS Subtotal			2,400





PARKING REQUIREMENTS

PARKING REQUIREMENTS	TOTAL # OF VEHICLES REQ.	# UNCOVERED SURFACE	# UNCOVERED SURFACE - EV STATIONS	# COVERED OPEN SHED	# ENCLOSED HEATED	PARKING SPACE
TOWN HALL						
Dave and Makiela Davkins						
Personal Vehicle Parking			l			40)/00
Staff	5	5	0			10X20
Visitors	27	25	2			10X20
Subtotal	32	30	2	0	0	J
Fleet Vehicle Parking						
Sedans	0					10X20
SUV's	0					10X20
Subtotal	0	0	0	0	0	
Personal Vehicle Parking		T	Γ	, · · · · ·		T
Personal Vehicle Parking						
Staff	0					10X20
Visitors	2	2				10X20
Subtotal	2	2	0	0	0	J
Fleet Vehicle Parking						
Police Cars	14	12	2			10X20
SUV's	0					10X20
Subtotal	14	12	2	0	0	
						-
PUBLIC WORKS						
Personal Vehicle Parking						
Staff	10	10				10X20
Visitors	4	2	2			10X20
Subtotal	14	12	2	0	0	
		dar aquar in the	Space Progra	nm		
Fleet Vehicle Parking *All Fleet Vehi	cles are accounted for un					
-	cles are accounted for und			1	7	10x40
Fleet Vehicle Parking *All Fleet Vehi Misc. Equipment Additional Spaces	cles are accounted for und	0	0	8	7	10x40 10x40





PARKING REQUIREMENTS

PARKING REQUIREMENTS	TOTAL # OF VEHICLES REQ.	#UNCOVERED SURFACE	# UNCOVERED SURFACE - EV STATIONS	# COVERED OPEN SHED	# ENCLOSED HEATED	PARKING SPACE SIZE
TOTAL PERSONAL VEHICLES (SURFACE)	44		30	00 SF/Space =	13,200	SF
TOTAL PERSONAL VEHICLES (SURFACE/EV)	4		30	00 SF/Space =	1,200	SF
TOTAL FLEET VEHICLES (SURFACE)	12		1,00	00 SF/Space =	12,000	SF
TOTAL FLEET VEHICLES (SURFACE/EV)	2		1,00	00 SF/Space =	2,000	SF
TOTAL FLEET VEHICLES (COVERED/OPEN SHED)	8		40	00 SF/Space =	3,200	SF
TOTAL FLEET VEHICLES (ENCLOSED HEATED)	7		40	00 SF/Space =	2,800	SF





PRELIMINARY ORDER OF MAGNITUDE PROJECT BUDGET

DECEMBER 21, 2023

	CONSTRUCTION AND DEVELOPMENT COSTS (TOTAL PROJECT)							
			UNIT	соѕт		TOTAL PROJECT	POLICE DEPARTMENT ONLY	PUBLIC WORKS ONLY
A.	Building & Site Construction Costs	26,232 SF						
	Police Department	8,088 SF						
	Public Areas	288 SF	\$/SF	\$0	\$	-	\$ -	
	Office Areas	1,867 SF	\$/SF	\$0	\$	-	\$ -	
	Operations Areas	5,251 SF	\$/SF	\$0	\$	-	\$ -	
	Building Support Areas	432 SF	\$/SF	\$0	\$	-	\$ -	
	Outdoor Covered Areas	250 SF	\$/SF	\$0	\$	-	\$ -	
	Public Works	18,144 SF						
	Operation Areas	14,688 SF	\$/SF	\$0	\$	-		\$ -
	Building Support Areas	456 SF	\$/SF	\$0	\$	-		\$ -
	Fuel Island	2,000 SF	\$/SF	\$0	\$	-		\$ -
	Outdoor Covered Areas	1,000 SF	\$/SF	\$0	\$	-		\$ -
В.	Sitework	4 Acres						
	Police Department	2 SF	\$/Acre	\$0	\$	_	\$ -	
	Public Works	2 SF	\$/Acre	\$0	\$	-		\$ -
C.	Design Contingency		% of A	10.00%	\$	-	\$ -	\$ -
D.	Construction Cost Escalation (0.5% per month)		Estimated per year	6.00%	\$	-	\$ -	\$ -
E.	Construction Cost Subtotal		(A thru D)		\$	-	\$ -	\$ -
				Bldg. Cost/SF	\$	-	-	\$ -
F.	Design & Engineering Professional Fees Architectural/Engineering Implementation Fee		Estimated	0.00%	\$	-	\$ -	\$ -
G.	Geotechnical Survey & Soil Borings Report		Estimated		\$	21,500	\$ 7,500	\$ 14,000
H.	Site Survey		Estimated		\$	21,500	\$ 7,500	\$ 14,000
I.	Special Inspections, Construction Materials Testing, & SWPPP Inspections		% of E	0.50%	\$	-	\$ -	\$ -
J.	Utility Tap & Impact Fees		Estimated		\$	90,000		
K.	Fees Subtotal		(F thru J)		\$	133,000	\$ 60,000	\$ 73,000
L.	Owner's Project Reserve/Contingency		% of E	2.00%	\$	-	\$ -	\$ -
M.	Furniture & Equipment		4.0=					
	Office Furniture Fitness Equipment		\$/SF Estimated	\$7.50	\$ \$	165,708 50,000	\$ 55,548 \$ 50,000	\$ 110,160
	• •					,	,	
N.	Telecommunications/Data/Security Data wiring, Access Control, Cameras, & Speakers Telecom/Data Systems A/V Systems		\$/SF	\$20	\$	26,232	\$ 161,768	\$ 302,880
Ο.	Site Lighting (Leased from Power Company)		Estimated		\$	-	\$ -	\$ -
P.	Additional Owner Items Subtotal		(L thru O)		\$	241,940	\$ 267,316	\$ 413,040
			•	•				

NOTES:

- a. Estimate is based on preliminary site layout and floor plans prepared by DP3 Architects & McGill..
- b. Estimate does not include land acquisition costs, moving costs, or tap fees.

TOTAL PROJECT BUDGET

- $\mbox{c.} \hspace{0.5cm} \mbox{Site costs have not accounted for unsuitable soils including rock, contaminated or wet soils.}$
- d. No offsite improvements or relocation of existing utilities are included, except as noted herein.
- e. Estimate does not include gas, phone, etc., except as specifically noted herein.
- f. Estimate assumes construction is completed in the next 12 months. For each year beyond 12 months add 6% Construction Cost Escalation for Item C above.
- g. This "Estimated Order of Magnitude Project Budget" should not be considered a guaranteed maximum cost, but instead is a professional opinion of probable construction costs at the time of preparation. The estimated cost/sf can vary greatly depending on quality of materials selected and value engineering might be needed from the current design to match this budget.

(E+K+P)

374,940

327,316

486,040

- h. The "Design Contingency" is a percentage of calculated costs which is added to the subtotal. This contingency helps compensate for unknown elements or conditions, variations in quantities used, and other unforeseen circumstances at the time of the study.
- i. The "Construction Contingency" will allow for changes to the design, other program alterations, and unforeseen site conditions encountered after construction initiation.
- j. DP3 Architects and its consultants have no control over the cost of labor, equipment, materials, or a contractor's method of pricing. It should be anticipated that bids and actual costs will vary from this budget.





TOWN HALL - REAR



PUBLIC WORKS





PUBLIC WORKS SHED

SITE DATA:

EXISTING BUILDING SQUARE FOOTAGE:

• TOWN HALL 5,050 SF

• PUBLIC WORKS 4,451 SF

• POLICE STATION 3,183 SF

• VEHICLE SHED 2,058 SF





Seal



DP3 Architects, Ltd.
15 South Main Street, Suite 400
Greenville, SC 29601
864.232.8200
www.DP3architects.com



MASTER PLAN


Project Number Drawn By Checked By Date 23219 MTP MTP 06 MAR 2024

Revisions

Drawing

TOWN HALL SITE -EXISTING



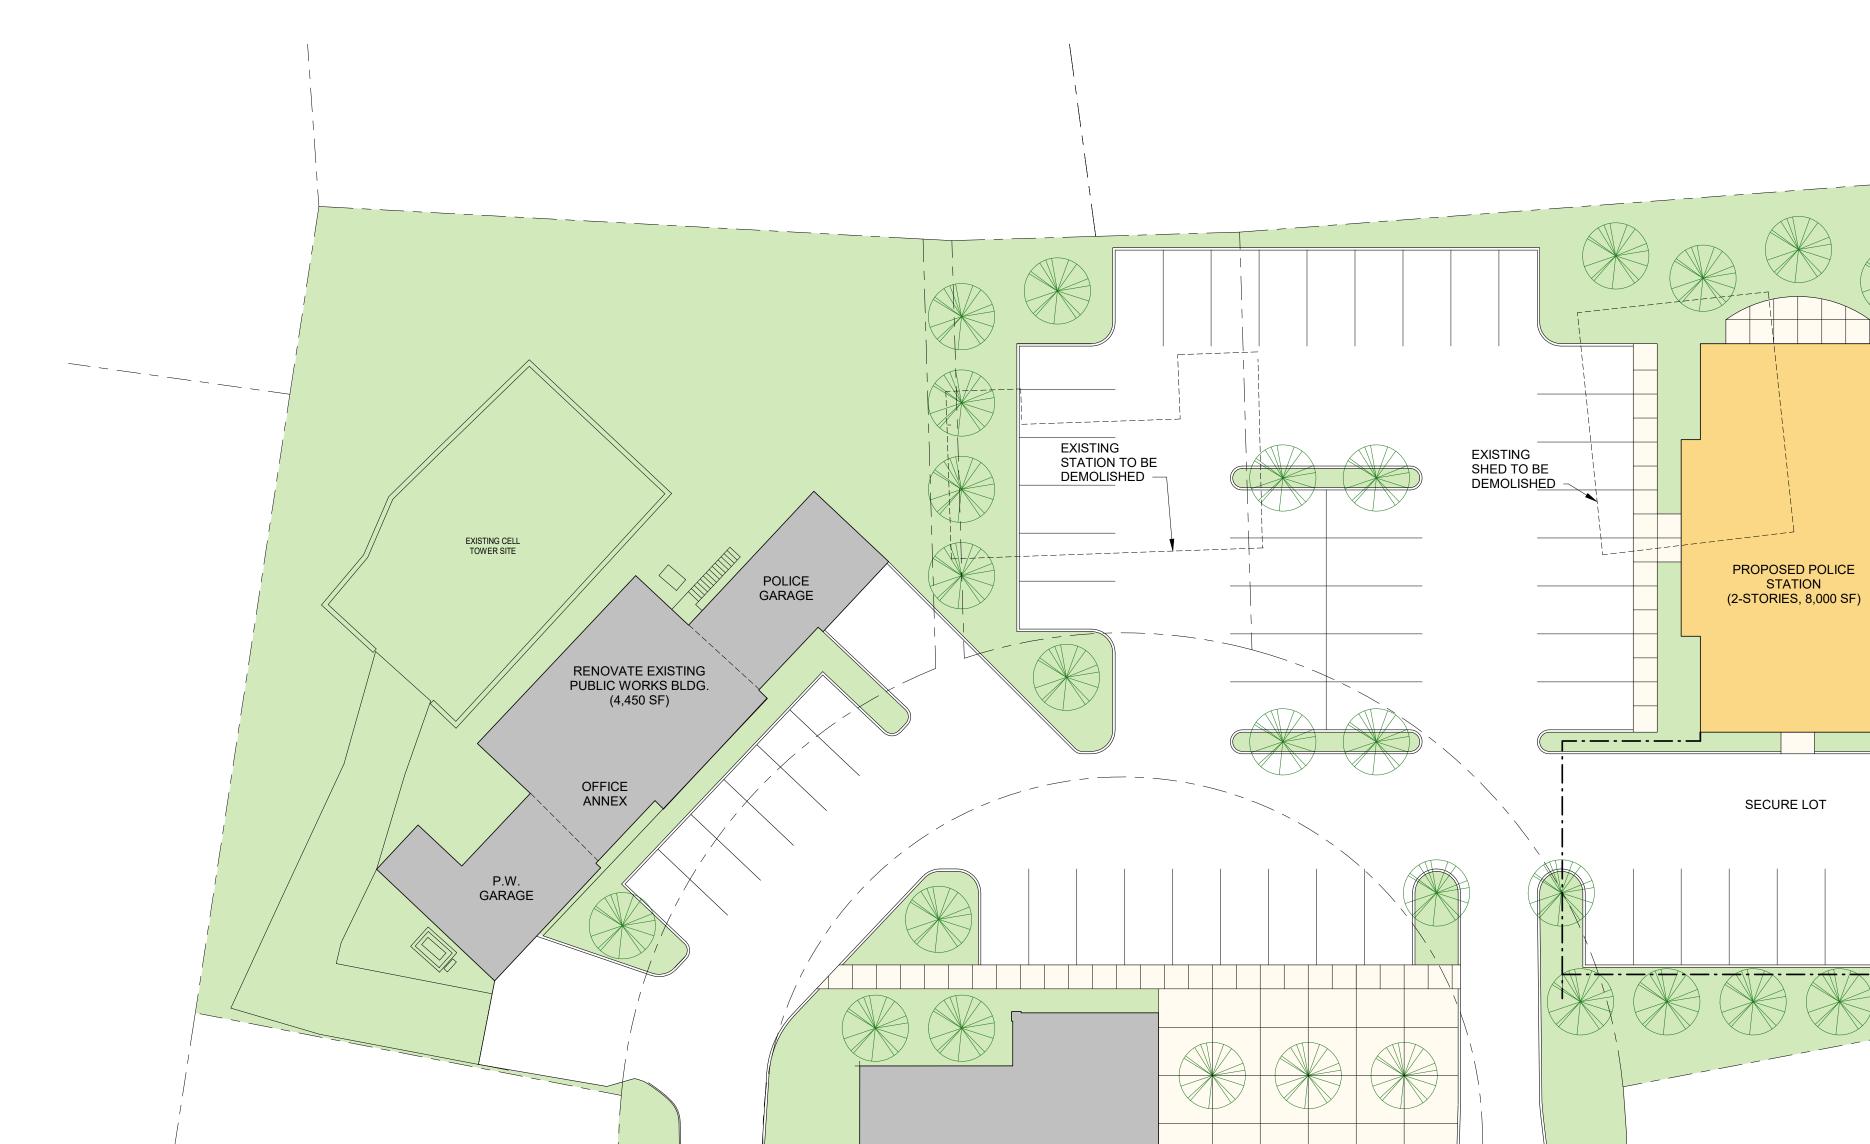

EXISTING TOWN HALL

SITE DATA:

BUILDING SQUARE FOOTAGE:

• EXISTING TOWN HALL

• EXISTING PUBLIC WORKS RENO

• PROPOSED POLICE STATION

5,050 SF 4,451 SF 8,000 SF

PARKING:
• TOTAL PARKING SPACES

60 SPACES

PROS:

INCREASES PARKING ON SITE.
POLICE STATION CAN REMAIN IN OPERATION DURING CONSTRUCTION.

CREATES ARCHITECTURAL BALANCE TO THE SITE.
CREATES DEFINED SECURE LOT FOR POLICE DEPARTMENT. PROVIDES OPPORTUNITY TO REUSE THE EXISTING PUBLIC WORKS
BUILDING FOR REUSE AS POLICE GARAGE AND PUBLIC WORKS
GARAGE TO KEEP LANDSCAPE EQUIPMENT ON SITE. BUILDING CAN ALASO BE UTILIZED FOR FUTURE TOWN HALL ADMINISTRATIVE

CONS:

POSSIBLE TEMPORARY POWER DISRUPTION DUE TO GENERATOR RELOCATION.



ARCHITECTS

DP3 Architects, Ltd.
15 South Main Street, Suite 400
Greenville, SC 29601 864.232.8200 www.DP3architects.com



MASTER PLAN

Project Number Drawn By Checked By Date 23219 MTP MTP 06 MAR 2024

Revisions


Drawing

TOWN HALL SITE -PREFERRED OPTION

C0.2C


1 TOWN HALL SITE - PREFERRED OPTION

C0.2C 1" = 20'-0"

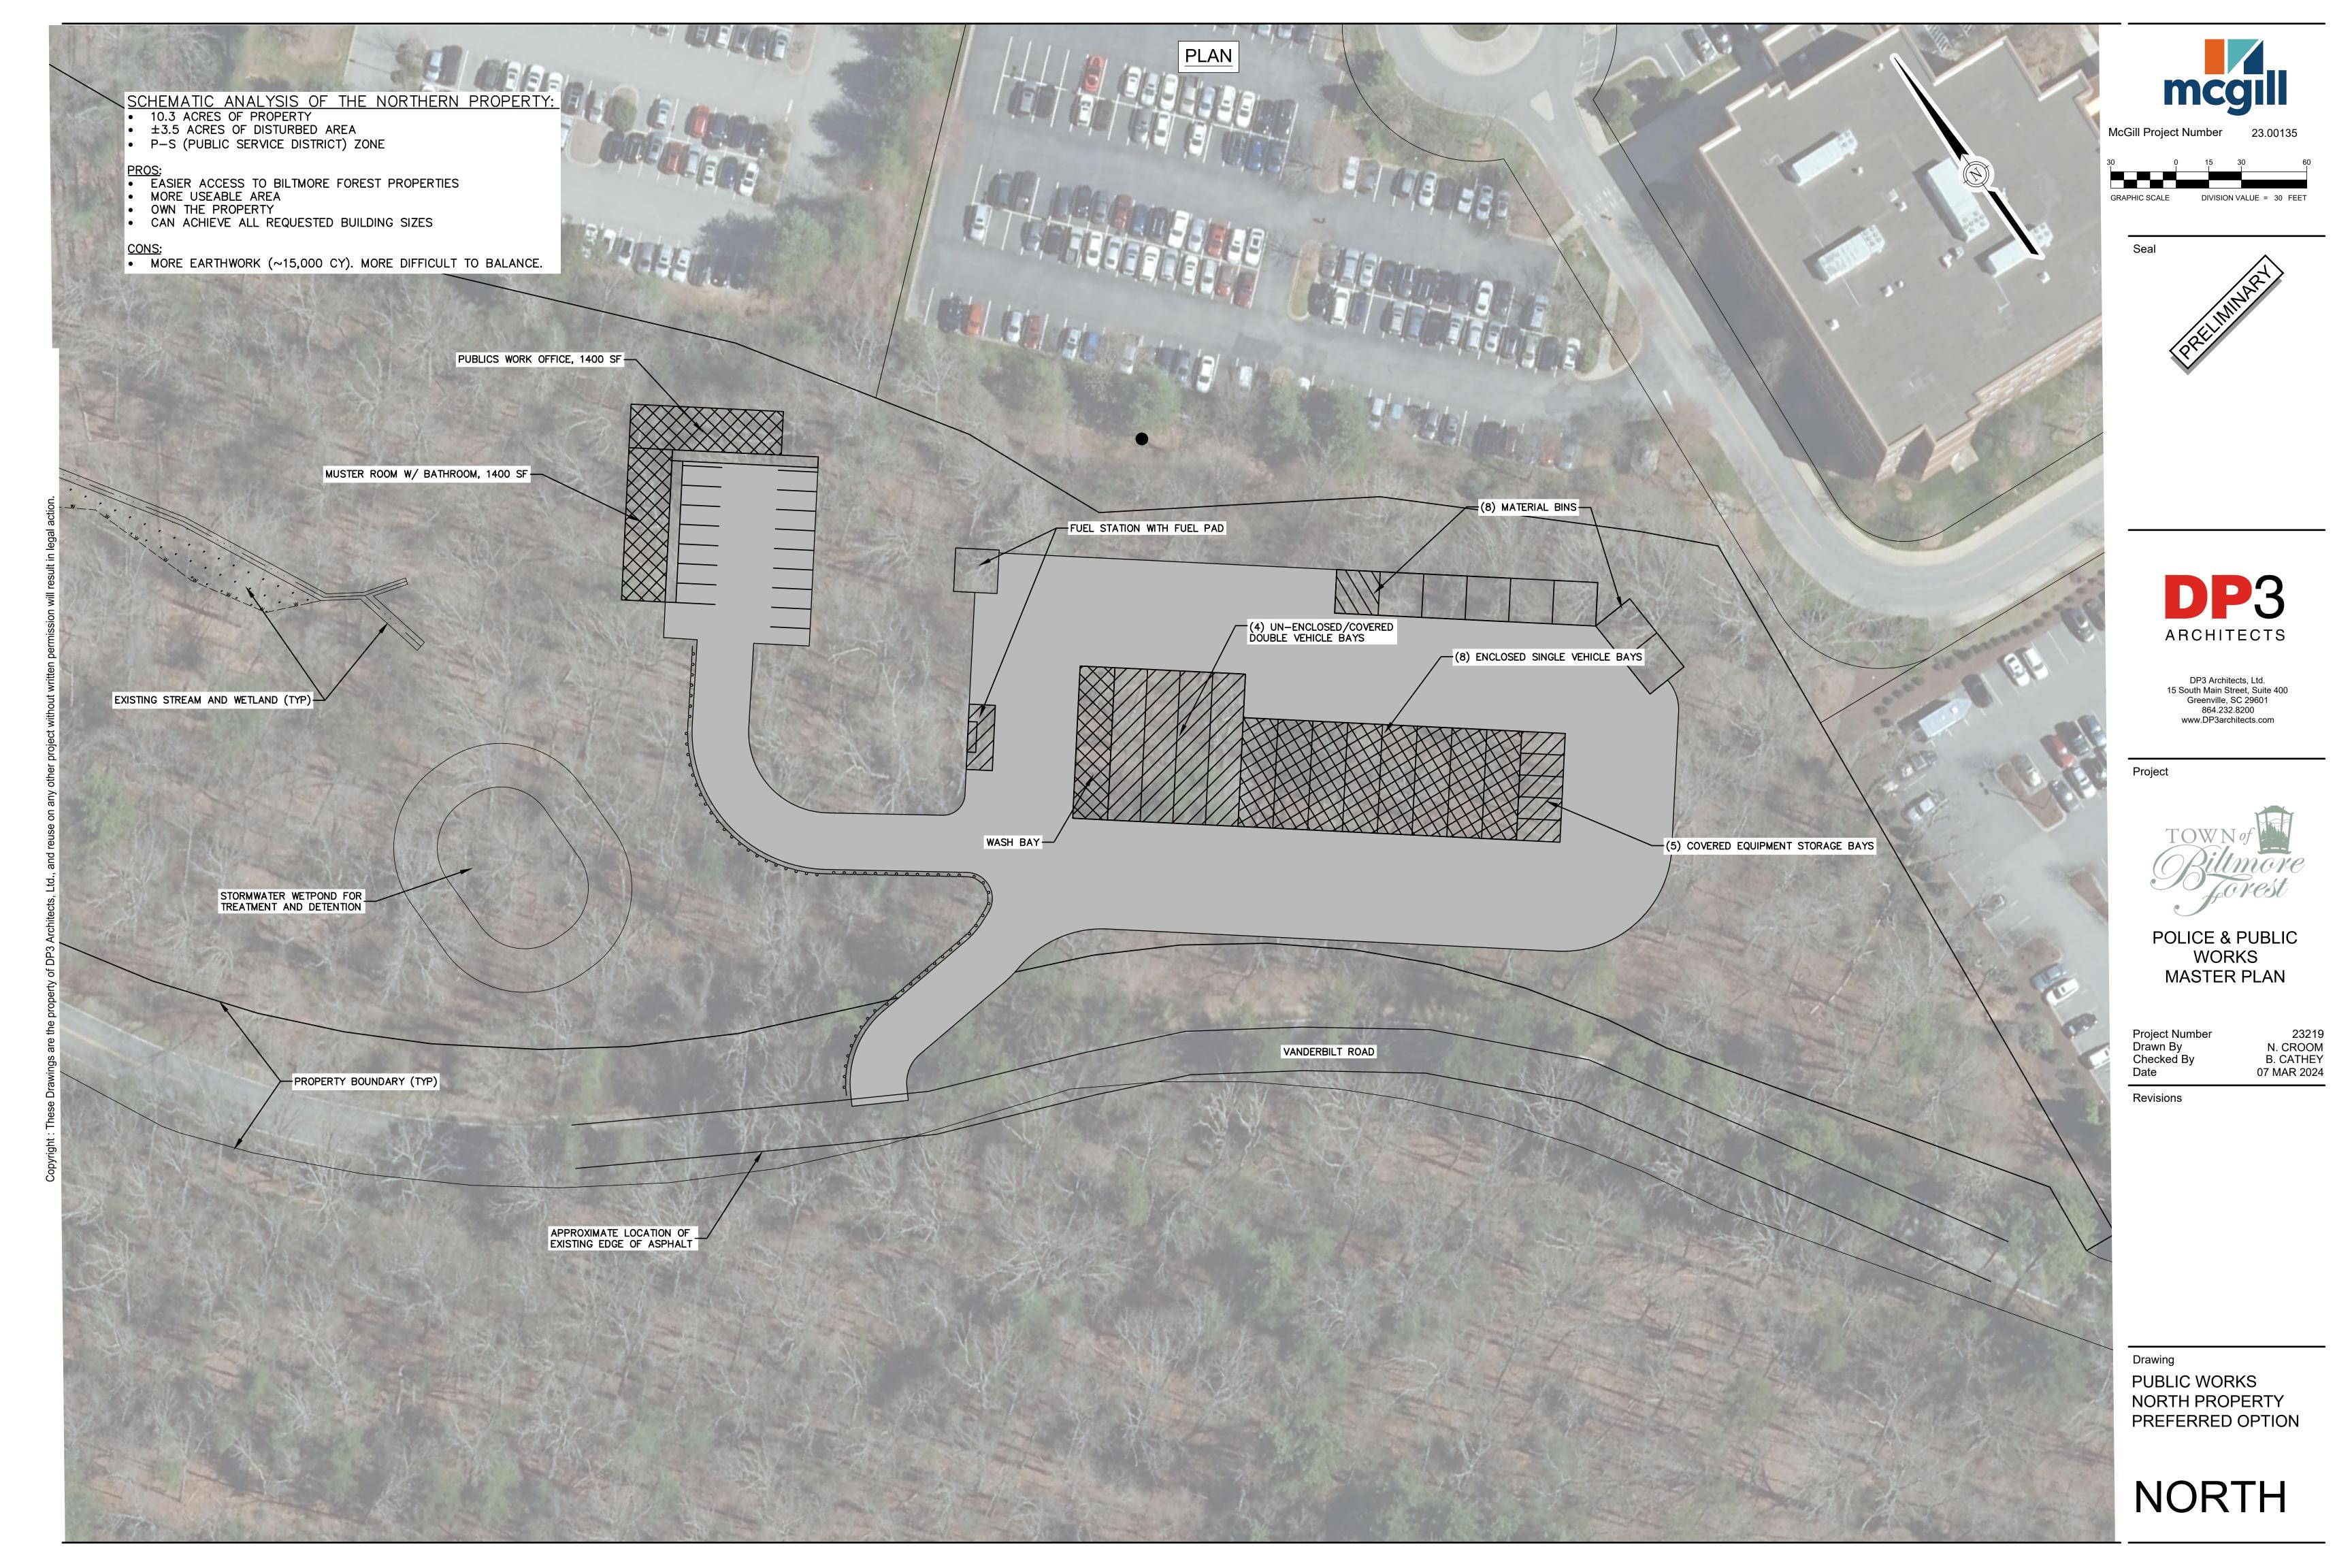





NORTH

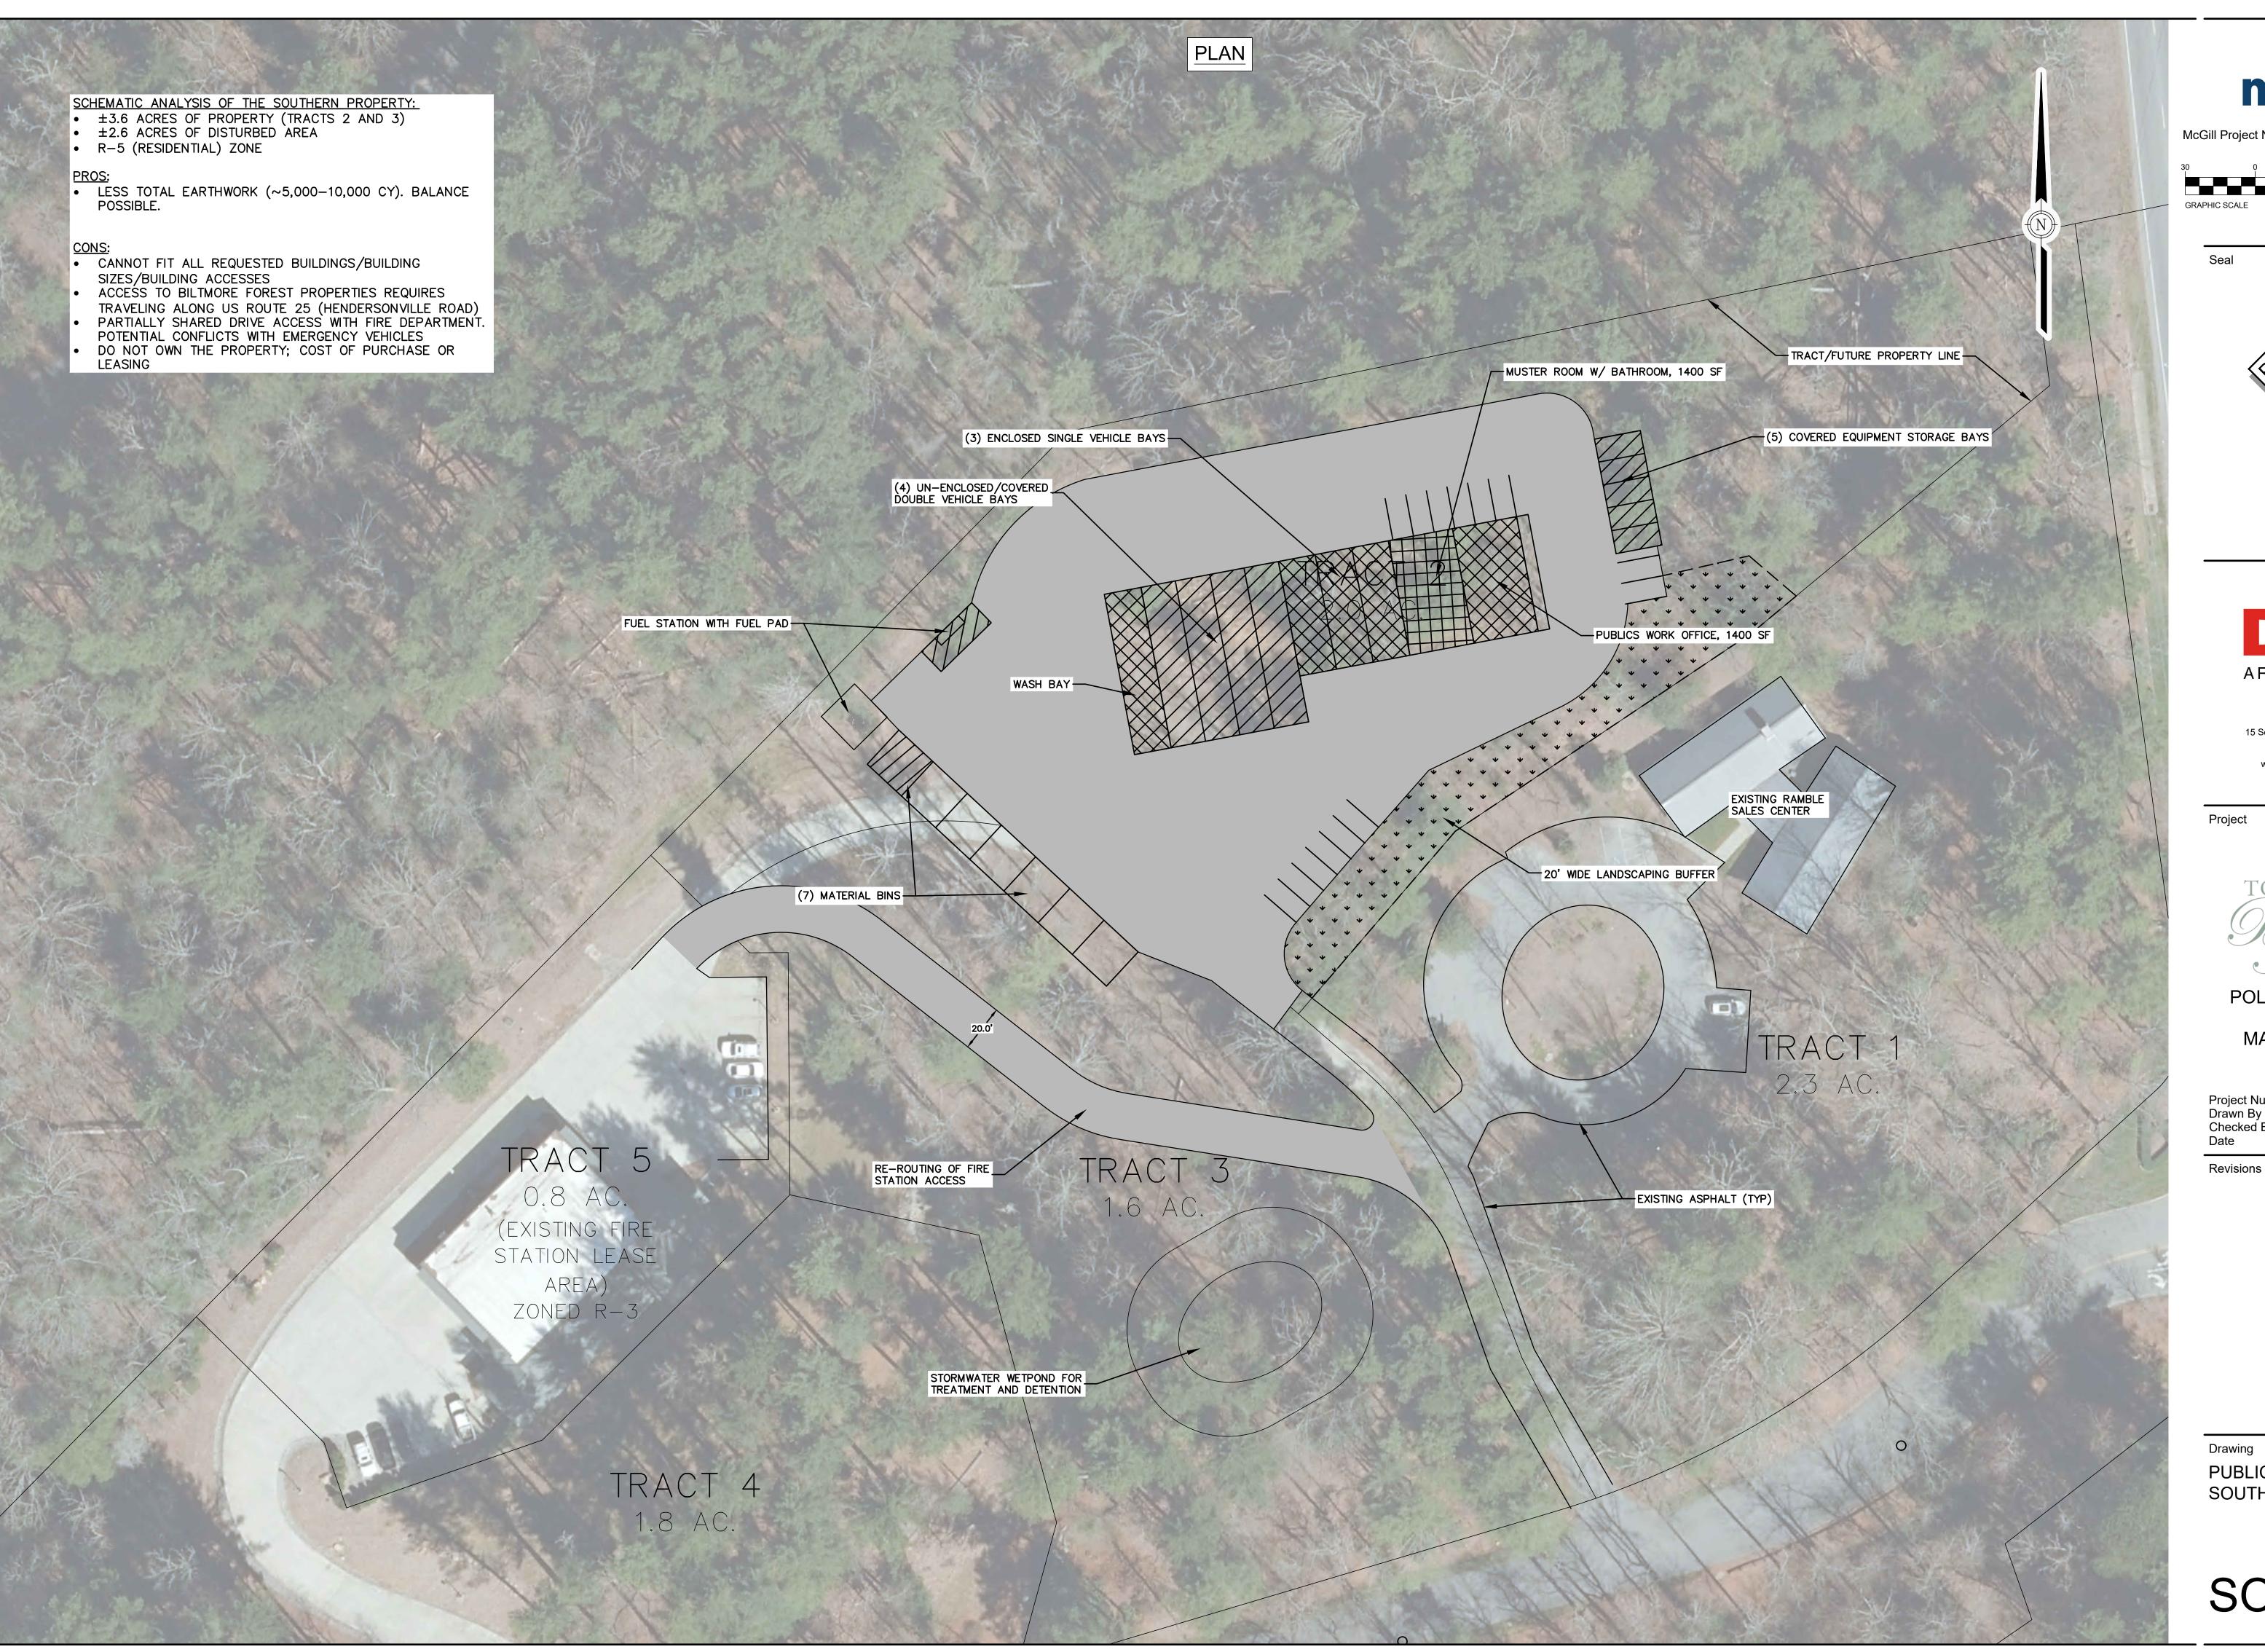



McGill Project Number

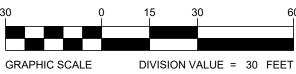

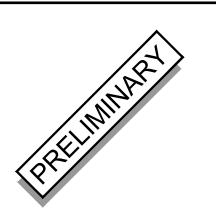



DP3 Architects, Ltd. 15 South Main Street, Suite 400 Greenville, SC 29601 864.232.8200 www.DP3architects.com

Project



POLICE & PUBLIC WORKS MASTER PLAN


23219 N. CROOM B. CATHEY 07 MAR 2024

Project Number Drawn By Checked By

Drawing

PUBLIC WORKS SOUTH PROPERTY

SOUTH

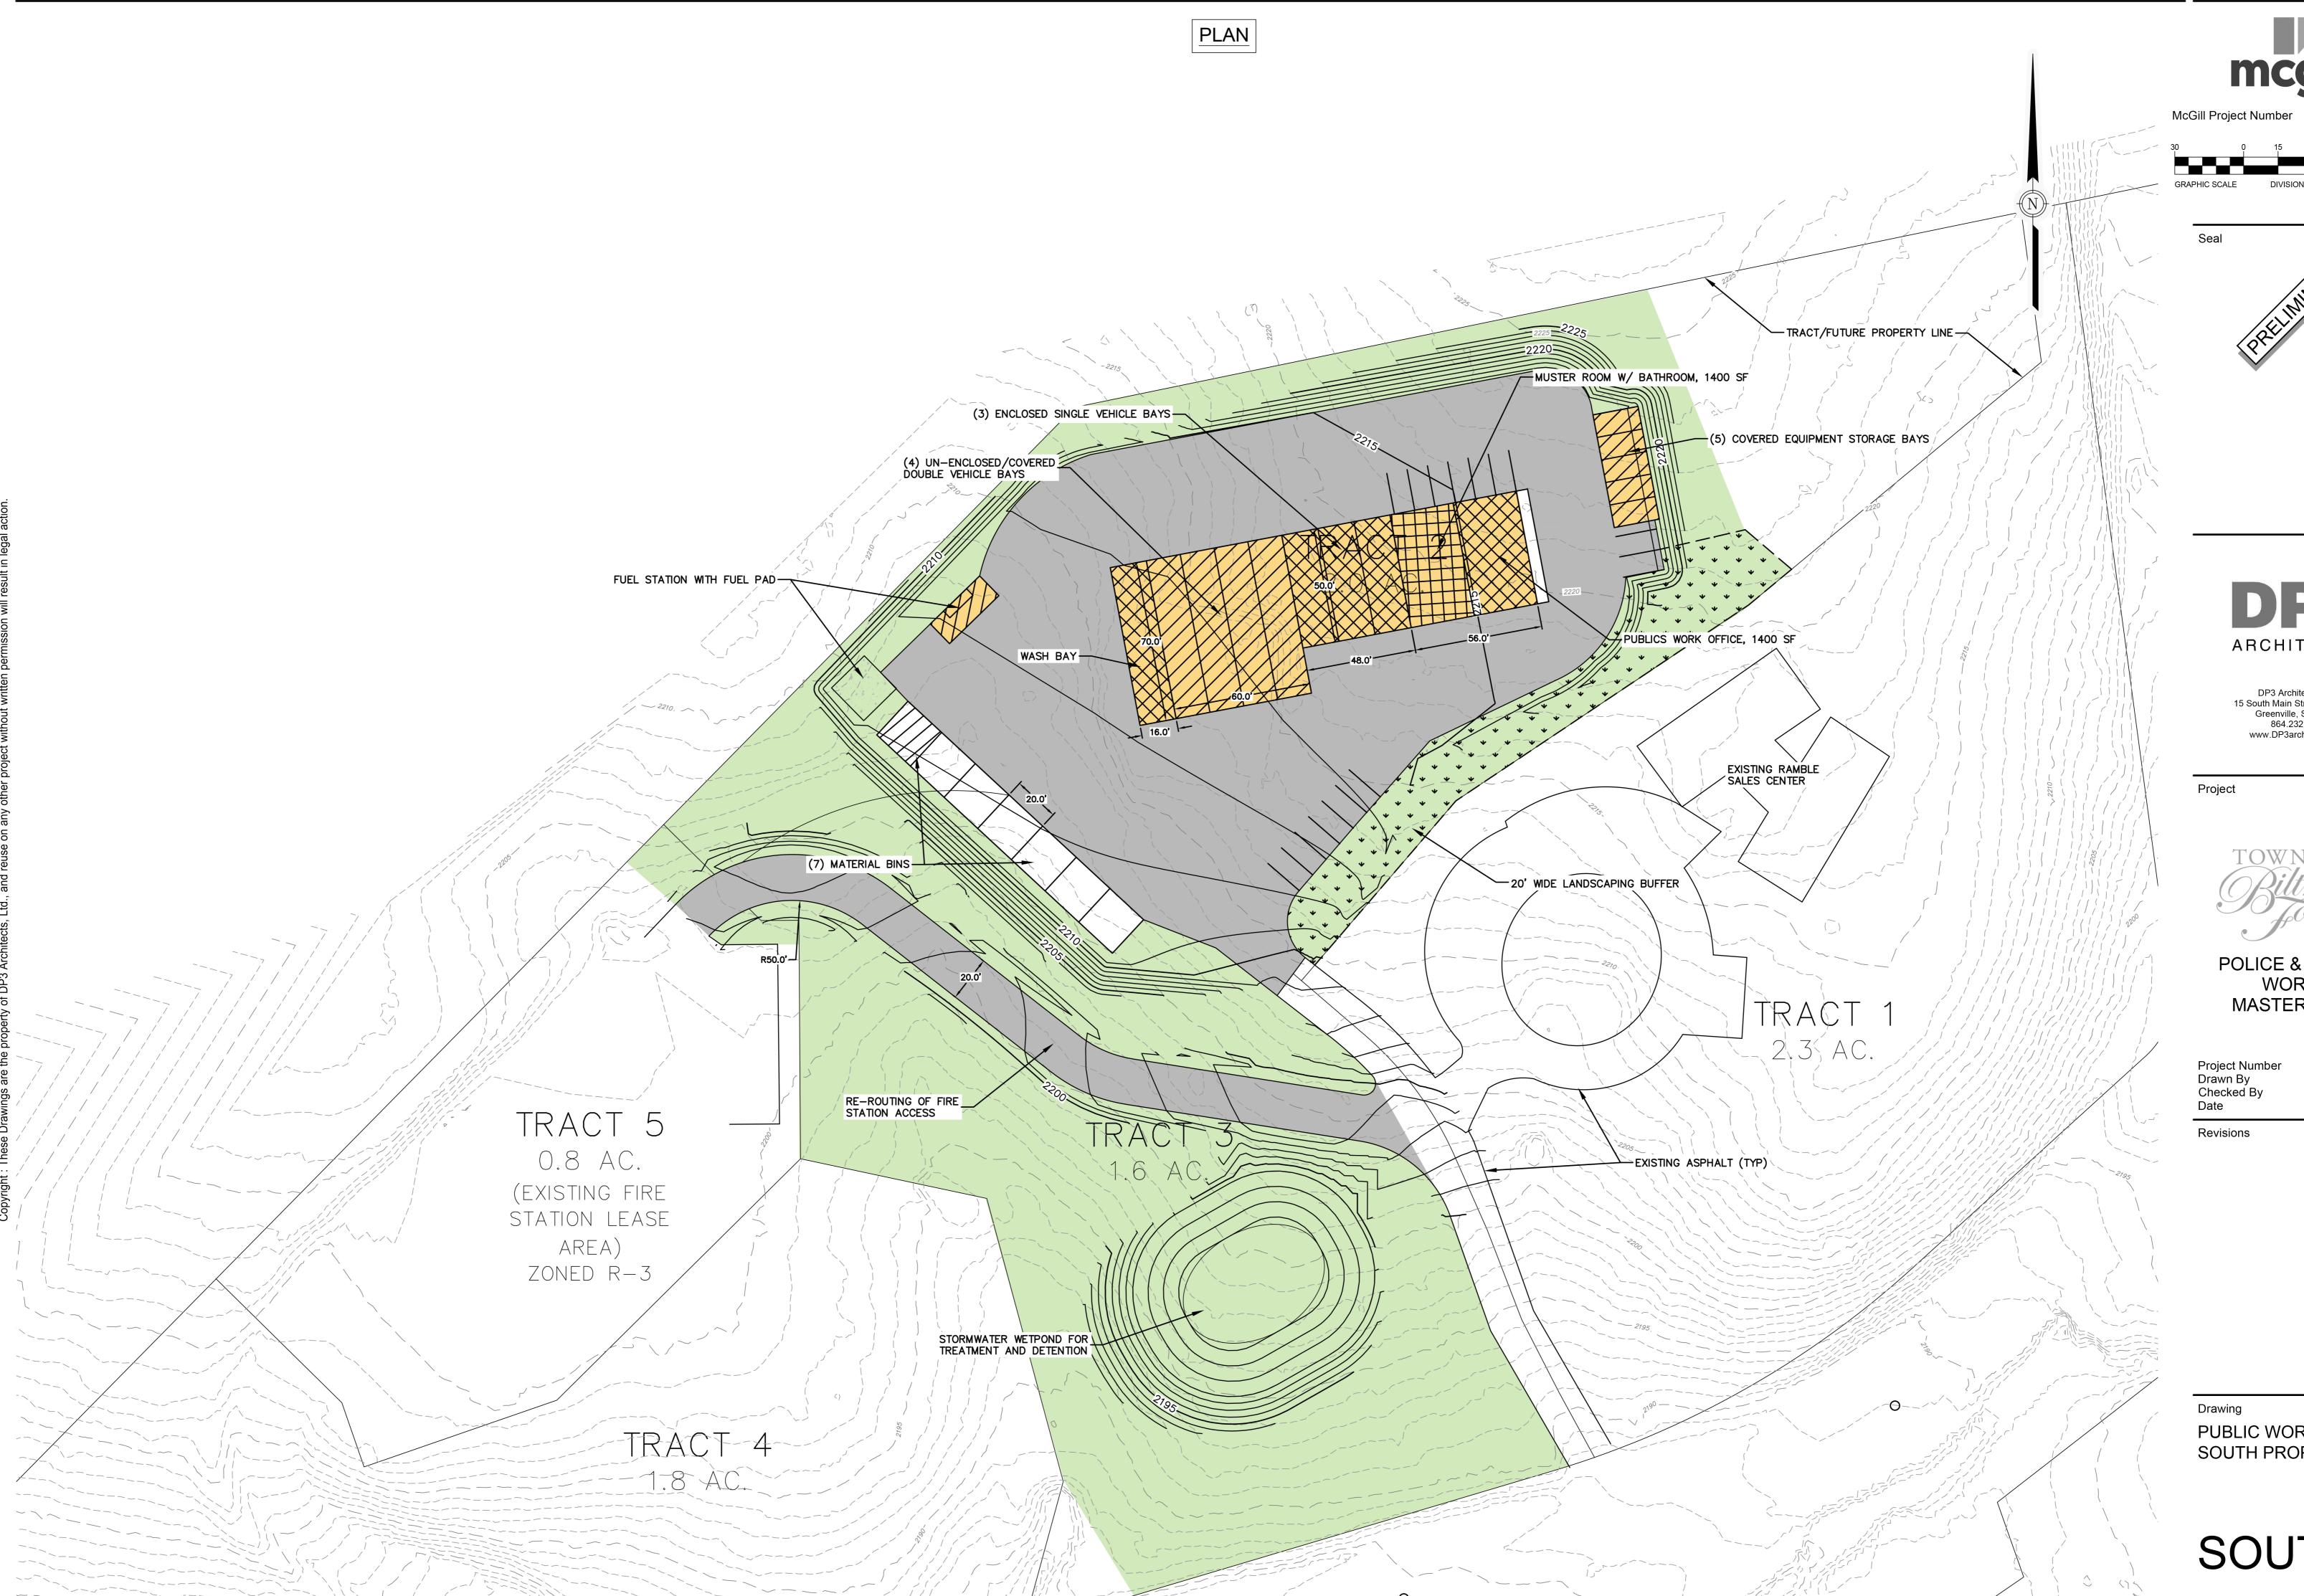





ARCHITECTS

DP3 Architects, Ltd.
15 South Main Street, Suite 400
Greenville, SC 29601
864.232.8200 www.DP3architects.com



POLICE & PUBLIC WORKS MASTER PLAN

Project Number Drawn By Checked By

23219 N. CROOM B. CATHEY 07 MAR 2024

Revisions

PUBLIC WORKS SOUTH PROPERTY

SOUTH



Town of Biltmore Forest Police Public Works Master Plan Bllitmore Forest, North Carolina

ESTIMATED ORDER OF MAGNITUDE PROJECT BUDGET March 6, 2024

CONSTRUCTION AND DEVELOPMENT COSTS (TOTAL PROJECT)

NOTE: Preferred Options for the Town Hall site and Public Works NORTH property are included in the Total Project Budget. Alternative SOUTH property is shown for comparison purposes.

			Unit		Cost		Total Project Budget	Tow	n Hall Site	l	Public Works NORTH Property	F	Public Works SOUTH Property
A.	Building & Site Construction Costs												
	Town Hall Site	8,000 SF											
	Existing Police Station Demolition	3,183 SF	\$/SF	\$	10.00	1 -	31,830		31,830				
	2. Existing PW Building Demolition	3,430 SF	\$/SF	\$	10.00			\$	34,300				
	3. Existing PW Shed Demolition	2,058 SF	\$/SF	\$	10.00			\$	20,580				
	New Police Station New Site Development (See attached breakdown)	8,000 SF 1.30 Acres	\$/SF \$/Acre	\$ \$	400.00	1 -		\$	3,200,000				
	э. New Site Development (See attached breakdown)	1.50 Acres	\$/Acre	\$	541,077	\$	703,400	\$	703,400				
	Public Works NORTH Property, Vanderbilt Rd	18,200 SF											
	New Operations Building Public Works Offices	1,400 SF	¢/0E	•	205.00	•	200,000			Φ.	200,000		
	Crew Muster Room/Support Spaces	1,400 SF 1,400 SF	\$/SF \$/SF	\$ \$	285.00 285.00	1 -	399,000 399,000			\$ \$	399,000 399,000		
	4 - Covered (Non-Enclosed/Non-Heated) Vehicle Bays	5,000 SF	\$/SF	\$	285.00		1,425,000			\$	1,425,000		
	3 - Covered (Enclosed/Heated) Vehicle Bays	6,100 SF	\$/SF	\$	285.00	1 -	1,738,500			\$	1,738,500		
	1 - Covered/Enclosed Vehicle Maintenance Bay	1,600 SF	\$/SF	\$	285.00		456,000			\$	456,000		
	1 - Vehicle Wash Bay	1,100 SF	\$/SF	\$	200.00	1 -	220,000			\$	220,000		
	New Covered Equipment Storage Building	.,	Ψ/ΟΙ	Ψ	200.00	Ψ	220,000			Ψ	220,000		
	5 - Covered/Unenclosed Bays	1,000 SF	\$/SF	\$	200.00	\$	200,000			\$	200,000		
	3. New Fuel Island	600 SF	\$/SF	\$	100.00	1 -	60,000			\$	60,000		
	New Site Development (See attached breakdown)	3.50 Acres	\$/Acre	\$	472,543	1 -	1,653,900			\$	1,653,900		
	Public Works - SOUTH Property, Valley Springs Rd	18,200 SF	Ī										
	New Operations Building	10,200 01											
	Public Works Offices	1,400 SF	\$/SF	\$	285.00							\$	399,000
	Crew Muster Room/Support Spaces	1,400 SF	\$/SF	\$	285.00							\$	399,000
	4 - Covered (Non-Enclosed/Non-Heated) Vehicle Bays	5,000 SF	\$/SF	\$	285.00							\$	1,425,000
	3 - Covered (Enclosed/Heated) Vehicle Bays	6,100 SF	\$/SF	\$	285.00							\$	1,738,500
	1 - Covered/Enclosed Vehicle Maintenance Bay	1,600 SF	\$/SF	\$	285.00							\$	456,000
	1 - Vehicle Wash Bay	1,100 SF	\$/SF	\$	200.00							\$	220,000
	2. New Covered Equipment Storage Building												
	5 - Covered/Unenclosed Bays	1,000 SF	\$/SF	\$	200.00							\$	200,000
	3. New Fuel Island	600 SF	\$/SF	\$	100.00							\$	60,000
	4. New Site Development (See attached breakdown)	2.60 Acres	\$/Acre	\$	541,615							\$	1,408,200
В.	Design Contingency		% of A		5.0%	\$	527,076	\$	199,506	\$	327,570	\$	70,410
C.	Construction Cost Escalation (1 year @ 6%/year)		% of A + B		6.0%	\$	664,115	\$	251,377	\$	412,738	\$	88,717
D.	Construction Cost Subtotal		(A thru C)			\$	11,732,701	\$	4,440,992	\$	7,291,708	\$	6,464,827
					Cost/SF	\$	448	\$	555	\$	401	\$	355
E.	Professional Fees												
	Architectural/Engineering Fees		% of D		8.0%	\$	938,616	\$	355,279	\$	583,337	\$	517,186
F.	Geotechnical Survey		Lump Sum			\$	15,000	\$	7,500	\$	7,500	\$	7,500
G.	Site Survey		Estimated			\$	30,000	\$	15,000	\$	15,000	\$	15,000
Н.	Asbestos and Lead Paint Survey		Estimated			\$	7,500	\$	7,500	\$	-	\$	-
l.	Construction Materials (IBC Chapter 17) Testing		% of D		0.8%	\$	93,862	\$	35,528	\$	58,334	\$	51,719
J.	Fees Subtotal		(E thru I)			\$	1,084,978	\$	420,807	\$	664,170	\$	591,405
Κ.	Owner's Project Reserve/Contingency		% of D		2.0%	\$		\$	88,820	\$	145,834	\$	129,297
	, , ,		70 01 5		2.070		201,001	Ψ	00,020		110,001	Ψ	120,201
	Movable Equipment Owner provided furnishings		\$/SF of A		\$7.50	¢	196,500	\$	60,000	\$	136,500	\$	136,500
	Owner Provided Equipment		Estimated		Ψ1.50	\$	*	\$	-	\$	100,000	\$	100,000
M.	Fixed Equipment Cost Appliances		Lump Sum			\$	45,000	\$	15,000	\$	30,000	\$	30,000
			•						,		,,,,,,,,,,,,,,,,,,,,,,,,,,,,,,,,,,,,,,,		
N.	Telecommunications/Data/Security		A/2=		4						-,	_	
	Access Control & CCTV		\$/SF of A \$/SF of A		\$3.00 \$2.50		•	\$ \$	24,000 20,000		54,600 45,500	\$	54,600 45,500
_	Data/Telephone Network						05,500		20,000		45,500		40,000
0.	Hazardous Materials Abatement (Assumed)		N/A		\$0.00		-	\$	-	\$	-	\$	-
Р.	Additional Owner Items Subtotal		(K thru O)			\$	720,254	\$	207,820	\$	512,434	\$	495,897
	TOTAL PROJECT BUDGET		(D+J+P)			\$	13,537,932	\$	5,069,620	\$	8,468,313	\$	7,552,128
					Cost/SF	\$	517	\$	634	\$	465	\$	415

NOTES:

- 1. Budget is based on preliminary layouts prepared by DP3 Architects and McGill.
- 2. Budget does not include land acquisition costs, moving costs, or tap fees.
- Site costs have not accounted for unsuitable soils including rock, contaminated or wet soils.
 Town Hall site costs assume no stormwater detention requirements (i.e. no increase in impervisous area), and no new utilities.
- 5. Estimate assumes that construction is completed within the next 12 months. For each year beyond 12 months add 6% Construction Cost Escalation for Item C above.
- 6. This "Estimated Order of Magnitude Project Budget" should not be considered a guaranteed maximum cost, but instead is a professional opinion of probable construction costs at the time of preparation.
- 7. The "Design Contingency" is a percentage of calculated costs which is added to the subtotal. This contingency helps compensate for unknown elements or conditions, variations in quantities used, and other unforeseen circumstances at the time of the Study.
- 8. The "Construction Contingency" will allow for changes to the design, other program alterations, and unforeseen site conditions encountered after construction initiation.
- 9. DP3 Architects and its consultants have no control over the cost of labor, equipment, materials, or a contractor's method of pricing. It should be anticipated that bids and actual costs will vary from this budget.







Town of Biltmore Forest Police Public Works Master Plan Bllitmore Forest, North Carolina

ESTIMATED ORDER OF MAGNITUDE SITE CONSTRUCTION COSTS March 6, 2024

Tov	Town Hall Site						
1.	General (w/ Mobilization)	\$	153,500.00				
2.	Site Demolition - Site Elements Only	\$	20,000.00				
3.	Erosion Control	\$	30,000.00				
4.	Earthwork	\$	46,900.00				
5.	Stormwater System	\$	145,200.00				
6.	Paving Surfaces	\$	257,800.00				
7.	Utilities	\$	-				
8.	Landscaping	\$	50,000.00				
	Total Estimated Costs	\$	703,400.00				

Du	Public Works NORTH Property, Vanderbilt Rd					
1.	General (w/ Mobilization)	\$	268,200.00			
	,		*			
2.	Erosion Control	\$	75,000.00			
3.	Earthwork	\$	268,100.00			
4.	Stormwater System	\$	421,200.00			
5.	Paving Surfaces	\$	351,400.00			
6.	Utilities	\$	195,000.00			
7.	Landscaping	\$	75,000.00			
	Total Estimated Costs	\$	1.653.900.00			

Pul	Public Works - SOUTH Property, Valley Springs Rd					
1.	General (w/ Mobilization)	\$	228,100.00			
2.	Erosion Control	\$	75,000.00			
3.	Earthwork	\$	198,900.00			
4.	Stormwater System	\$	400,400.00			
5.	Paving Surfaces	\$	309,800.00			
6.	Utilities	\$	121,000.00			
7.	Landscaping	\$	75,000.00			
	Total Estimated Costs	\$	1.408.200.00			



