### **Zoning Compliance Application**

Town of Biltmore Forest

Name

Carrie (Architect) McLauchlan

**Address** 

22 Cedarcliff Road

**Phone** 

(828) 253-1124

**Email** 

carrie@samselarchitects.com

Parcel ID/PIN Number

9647626756

**ZONING INFORMATION** 

**Current Zoning** 

R-1

**Lot Size** 54.885.6 sf

**Maximum Roof Coverage** 

6,100 square feet (Up to 2 acres)

**Proposed Roof Coverage Total** 

5,393 sf

**Maximum Impervious Surface Coverage** 

25 percent of lot area (1-3 acres)

**Proposed Impervious Surface Coverage** 

8,370 sf

**Front Yard Setback** 

60 feet (R-1 District)

**Side Yard Setback** 

20 feet (R-1 District)

**Rear Yard Setback** 

25 feet (R-1 District)

No buildings or structures may be located within these setback areas. A variance application is required if your project requires encroachment upon

the setback.

**Description of the Proposed Project** 

SM. Lh

One and a half story single family home with unfinished basement, wood lap siding, and standing seam metal roof.

**Estimated Cost of Project** 

\$1,500,000.00

**Estimated Completion Date** 

6/1/2020

**Applicant Signature** 

# Supporting Documentation (Site Plan, Drawings, Other Information) 190110 Olesky Residence.pdf

#### VARIANCE APPLICATION

Town of Biltmore Forest

Name

Carrie McLauchlan

**Address** 

60 Biltmore Avenue

**Phone** 

(828) 253-1124

Email

carrie@samselarchitects.com

**Current Zoning/Use** 

Residence

**Requested Use** 

Residence

**APPLICATION REQUIREMENTS**: An application to the Board of Adjustment for a variance must be submitted to the Town of Biltmore Forest Town Manager at least 21 days prior to the meeting at which the application will be considered. A pre-application meeting with Town staff is required prior to application submittal to the Board of Adjustment.

#### What would you like to do with your property?

Build a single family residence, 1.5 stories with unfinished basement, detached Office and Workshop. Because of the narrow lot and dramatic slope at the back of the lot we will need a retaining wall for a turnaround space that is outside of the side setback.

#### What does the ordinance require?

The ordinance requires the retaining wall for the turn-around space to be within the side setback.

BOARD OF ADJUSTMENT: N.C.G.S. 160A-388(D) requires that the Board of Adjustment shall vary the provisions of the Zoning Ordinance only upon a showing of ALL the items below. The Board of Adjustment must follow strict procedure and all determiniations must be decided by a concurring vote of four-fifths of the members of the Board. It is important to provide detailed supporting documentation for the Board of Adjustment to review. If necessary, additional sheets may be attached to this application.

#### REQUIRED FINDINGS: Please provide a thorough response to each.

#### Unnessary hardship would result from the strict application of the ordinance.

There is an existing drive and graded area for pulling into the Garage. Because of this current location, the naturally narrow lot, and dramatic slope toward the back of the lot, we will need this retaining wall to be over the side setback for a vehicle to have the appropriate radius for turning around, or to be able to park in that space.

### The hardship results from conditions that are peculiar to the property, such as location, size, or topography.

Because there was an existing home on the property (since demolished) the location of the existing drive and grading from the existing home set the site up naturally for the layout of the Site Plan. The dramatic incline at the back of the property also limits the amount of flexibility that we have for a vehicle without a retaining wall.

#### The hardship did not result from actions taken by the applicant or the property owner.

No, the lot dimensions, natural grade and existing drive location were not driven by the Owner.

The requested variance is consisent with the spirit, purpose, and intent of the ordinance, such that public safety is secured, and subtaintial justice is achieved.

Yes, we will provide a vegetated buffer so that the neighbors are not disturbed by the program that is over the side setback.

I hereby cetify that all of the information set forth above is true and accurate to the best of my knowledge.

Signature

CSM LL

**Date** 1/23/2019

### **Conditional Use Permit Application**

Town of Biltmore Forest

#### **Transaction Details**

Number: F16E8T1

Date: 1/23/2019 5:46 PM

Application Fee \$100.00

Subtotal: \$100.00

Order Total: \$100.00

#### **Application Fee**

\$100.00

#### Name

Carrie McLauchlan

#### **Address**

60 Biltmore Avenue

Phone Email

(828) 253-1124 carrie@samselarchitects.com

#### Please select the type of conditional use you are applying for:

**Accessory Buildings** 

The applicant must show that the proposed use will not materially endanger public health or safety or injure value of adjoining or abutting property. In addition, the proposed use must be in general conformity with the plan of development of the town and be in harmony with scale, bulk, height, coverage, density, and character of the neighborhood.

#### Please provide a description of the proposed project:

Single family residence, 1.5 stories with a full basement, detached Office and Workshop, with stone slab steps to the back of the property.

### Explain why the project would not adversely affect the public interest of those living in the neighborhood:

The character of the residence is in keeping with the surrounding properties. The home Office and Workshop are tucked to the back of the property, nestled into natural grade and will be concealed from the neighbors to the side with a vegetated buffer. Natural stone pavers allow access to the back of the property which is otherwise separated by steep grade.

I hereby certify that all of the information set forth above is true and accurate to the best of my knowledge.


Signature

**Date** 1/23/2019

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# OLESKY RESIDENCE 15.50

22 CEDARCLIFF ROAD, BILTMORE FOREST, NC, 28803



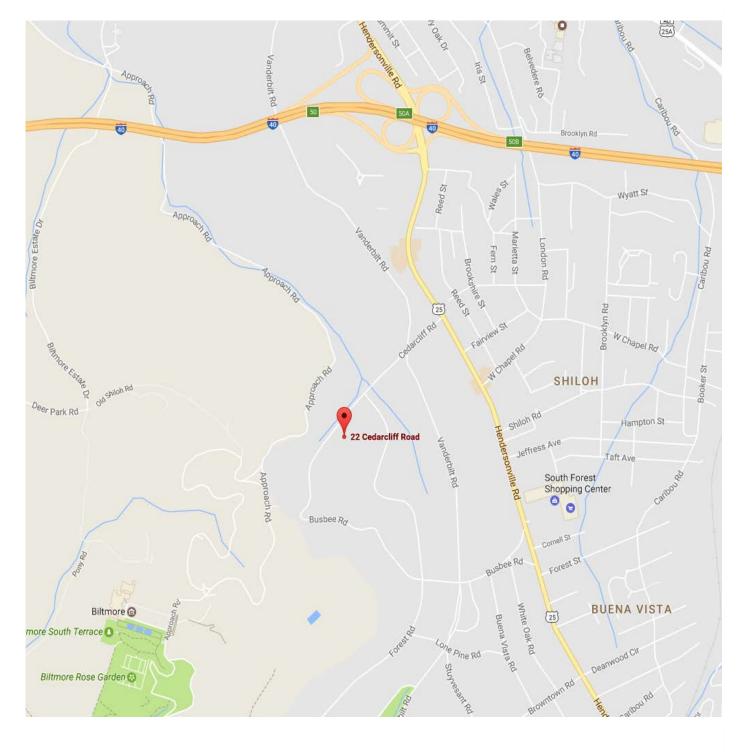

### **ABBREVIATIONS**

ABI	BREVIATIONS		
AC	Acoustic	FO	Face of
ACT	Acoustic Ceiling Tile	FOC	Face of Concrete
AD	Access Door	FUIVI	race of Masonry
ADJ	Adjacent	FOS	Face of Stud(s)
AFF	Above Finished Floor	FOW	Face of Wall
AHU	Air Handling Unit	FP	Fire Protection
ALT	Alternate	FRGWE	Fire Rated Gypsum V
ALUM	Aluminum	FRP	Fiber Reinforced Pan
AP	Access Panel	FT	Foot/Feet
BEV	Beveled	FTG	Footing
BLDG	Building	FUT	Future
ВО	Bottom of	GA	Gage
BOW	Bottom of Wall	GALV	Galvanized
BLKG	Blocking	GC	General Contractor
BRD	Board	GL	Glass/Glazing
BRG	Bearing	GWB	Gypsum Wallboard
CAB	Cabinet	Н	Heigh/Height
CER	Ceramic	HD HT	
CJ	Control Joint	HDWD	Hardwood
CL	Closet	<b>HDWR</b>	Hardware
CLG	Ceiling	HM	Hollow Metal
CLR	Clear(ance)	HORIZ	Horizontal
CMU	Concrete Masonry Unit	HC	Handicapped
COL	Column	HVAC	
CONC	Concrete	INSUL	_
CONT	Continuous	INT	Interior
DEMO	Demolish/Demolition	KD	Kiln Dried
DET	Detail	LAV	Lavatory
DF	Drinking Foundation	LCC	Lead Coated Copper
DIM	Dimension	LVL	Laminated Veneer Lu
DISP	Dispenser	LVR	Louver
DMT	Demountable	MAX	Maximum
DN	Down	MDF	Medium Density Fibe
DNSP	Downspout	MDO	Medium Density Ove
DWG	Drawing(s)	MECH	Mechanical
DWR	Drawer	MEMB	
EA	Each	MFR	Manufacturer
EJ	Expansion Joint	MIN	
EL	Elevation		Miscellaneous
	Electric(al)	MO	Masonry Opening
ELEV		MLDG	U
EQ	Equal	MR	Moisture Resistant
EQUIP			BMoisture Resistant G
EXIST	Existing	MTD	Mounted
EXP	Expansion	MTL	Metal
EXT	Exterior	NIC	Not In Contact
FD	Floor Drain	NOM	Nominal
FEC	Fire Extinguisher Cabinet	NTS	Not to Scale
FF	Finish Face	OC	On Center(s)
FG	Fixed Glass	OD	Outside Diameter
FIN	Finish(ed)	OPNG	Opening
	Finished Floor	OSB	Oriented Strandboard
FL	Floor	OPP	Opposite

PARTN Partition

PERF Perforated

FLSH Flashing

FNDN Foundation

ace of	PI AM	Plastic Laminate
ace of Concrete	PLBG	Plumbing
ace of Masonry	PLY	Plywood
ace of Stud(s)	POLY	Polyethelene
ace of Wall	PNBD	Panelboard
ire Protection	PR	Pair
ire Rated Gypsum Wallboard iber Reinforced Panel	PSF PSI	Pounds per Square Foot
	PSL	Pounds per Square Inch
oot/Feet	PT	Parallel Strand Lumber Pressure Treated
ooting		
uture	PTD	Painted
age	PVC	Polyvinyl Chloride
alvanized	QT	Quarry Tile
eneral Contractor	R	Riser
lass/Glazing	RAD	Radius
ypsum Wallboard	REG	Register
eigh/Height	REQ'D	Required
ead Height	RET	Return
ardwood	REV	Revised/Revision(s)
ardware	RO	Rough Opening
ollow Metal	SAN SF	Sanitary
orizontal		Square Foot/Feet Similar
andicapped	SIM	
eating, Ventilation & Air Conditioning sulation	SPF	Sealant
terior	S/S	Spruce/Pine/Fir Stainless Steel
iln Dried	STD	Standard
avatory	SUSP	Suspend(ed)
•	SYP	Southern Yellow Pine
ead Coated Copper aminated Veneer Lumber	T	Tread
ouver	T&G	Tongue & Groove
laximum	TELE	Telephone
ledium Density Fiberboard	THRU	Though
ledium Density Overlay	TO	Top of
lechanical	TOB	Top of Beam
lembrane	TOD	Top of Decking
lanufacturer	TOF	Top of Footing
linimum	TOPL	Top of Plate
liscellaneous	TOS	Top of Slab
lasonry Opening	TOSTL	Top of Steel
loulding	TOW	Top of Wall
loisture Resistant	TRTD	Pressure Treated Lumber
loisture Resistant Gypsum Wallboard		Typical
lounted	UL	Underwriters Laboratory
1-4-1	LINIT	I lufiniala ad

UNF Unfinished

VB Vapor Barrier

W/ With

W/O Without WP Waterproofing

UNO Unless Noted Otherwise

VCT Vinyl Composition Tile

WWF Welded Wire Fabric

### PROJECT TEAM

ARCHITECT:
Samsel Architects, P.A.
60 Biltmore Avenue
Asheville, NC 28801
P: 828.253.1124

CONTRACTOR:
Jade Mountain Builders
362 Depot Street
Suite 10
Asheville, NC 28801
P: 828.216.3948

LANDSCAPE ARCHITECT:
Osgood Landscape Architecture
14 Church Street
Asheville, NC 28801
P: 828.337.7496

# SQUARE FOOTAGE

**CONDITIONED SPACE:** 

Main Level: Upper Level: Lower Level (Unfinished): Office: Total Heated:	2,146 s.f. 2,013 s.f. 2,192 s.f. 146 s.f. 6,497 s.f.
UNCONDITIONED SPACE: Main Level Garage: Work Shop: Front Entry Porch: Screened Porch:	671 s.f. 313 s.f. 250 s.f. 395 s.f.
Total Unconditioned:	1,629 s.f.
TOTAL:	8,126 s.f.

<u> </u>	DRAWING INDEX			
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L-101	SITE PLAN	01.10.19		
A-101	FOUNDATION PLAN	01.10.19		
A-102	LOWER LEVEL FLOOR PLAN	01.10.19		
A-103	MAIN LEVEL FLOOR PLAN	01.10.19		
A-104	UPPER LEVEL FLOOR PLAN	01.10.19		
A-105	ROOF PLAN	01.10.19		
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A-112	UPPER LEVEL FLOOR FRAMING PLAN			
A-113	ROOF FRAMING PLAN			
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A-122	UPPER LEVEL REFLECTED CEILING PLAN			
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A-132	UPPER LEVEL FURNITURE PLAN			
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A-205	EXTERIOR ELEVATIONS	01.10.19		
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A-302	BUILDING SECTIONS			
A-303	BUILDING SECTIONS			
A-304	BUILDING SECTIONS			
A-401	INTERIOR ELEVATIONS			
A-402	INTERIOR ELEVATIONS			
A-403	INTERIOR ELEVATIONS			
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A-601	SCHEDULES			
A-602	SCHEDULES			
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E-102	MAIN LEVEL ELECTRICAL PLAN			
E-103	UPPER LEVEL ELECTRICAL PLAN			

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PROJECT:
OLESKY RESIDENCE

22 CEDARCLIFF ROAD BILTMORE FOREST, NC 28803

SHEET TITLE:

COVER SHEET	

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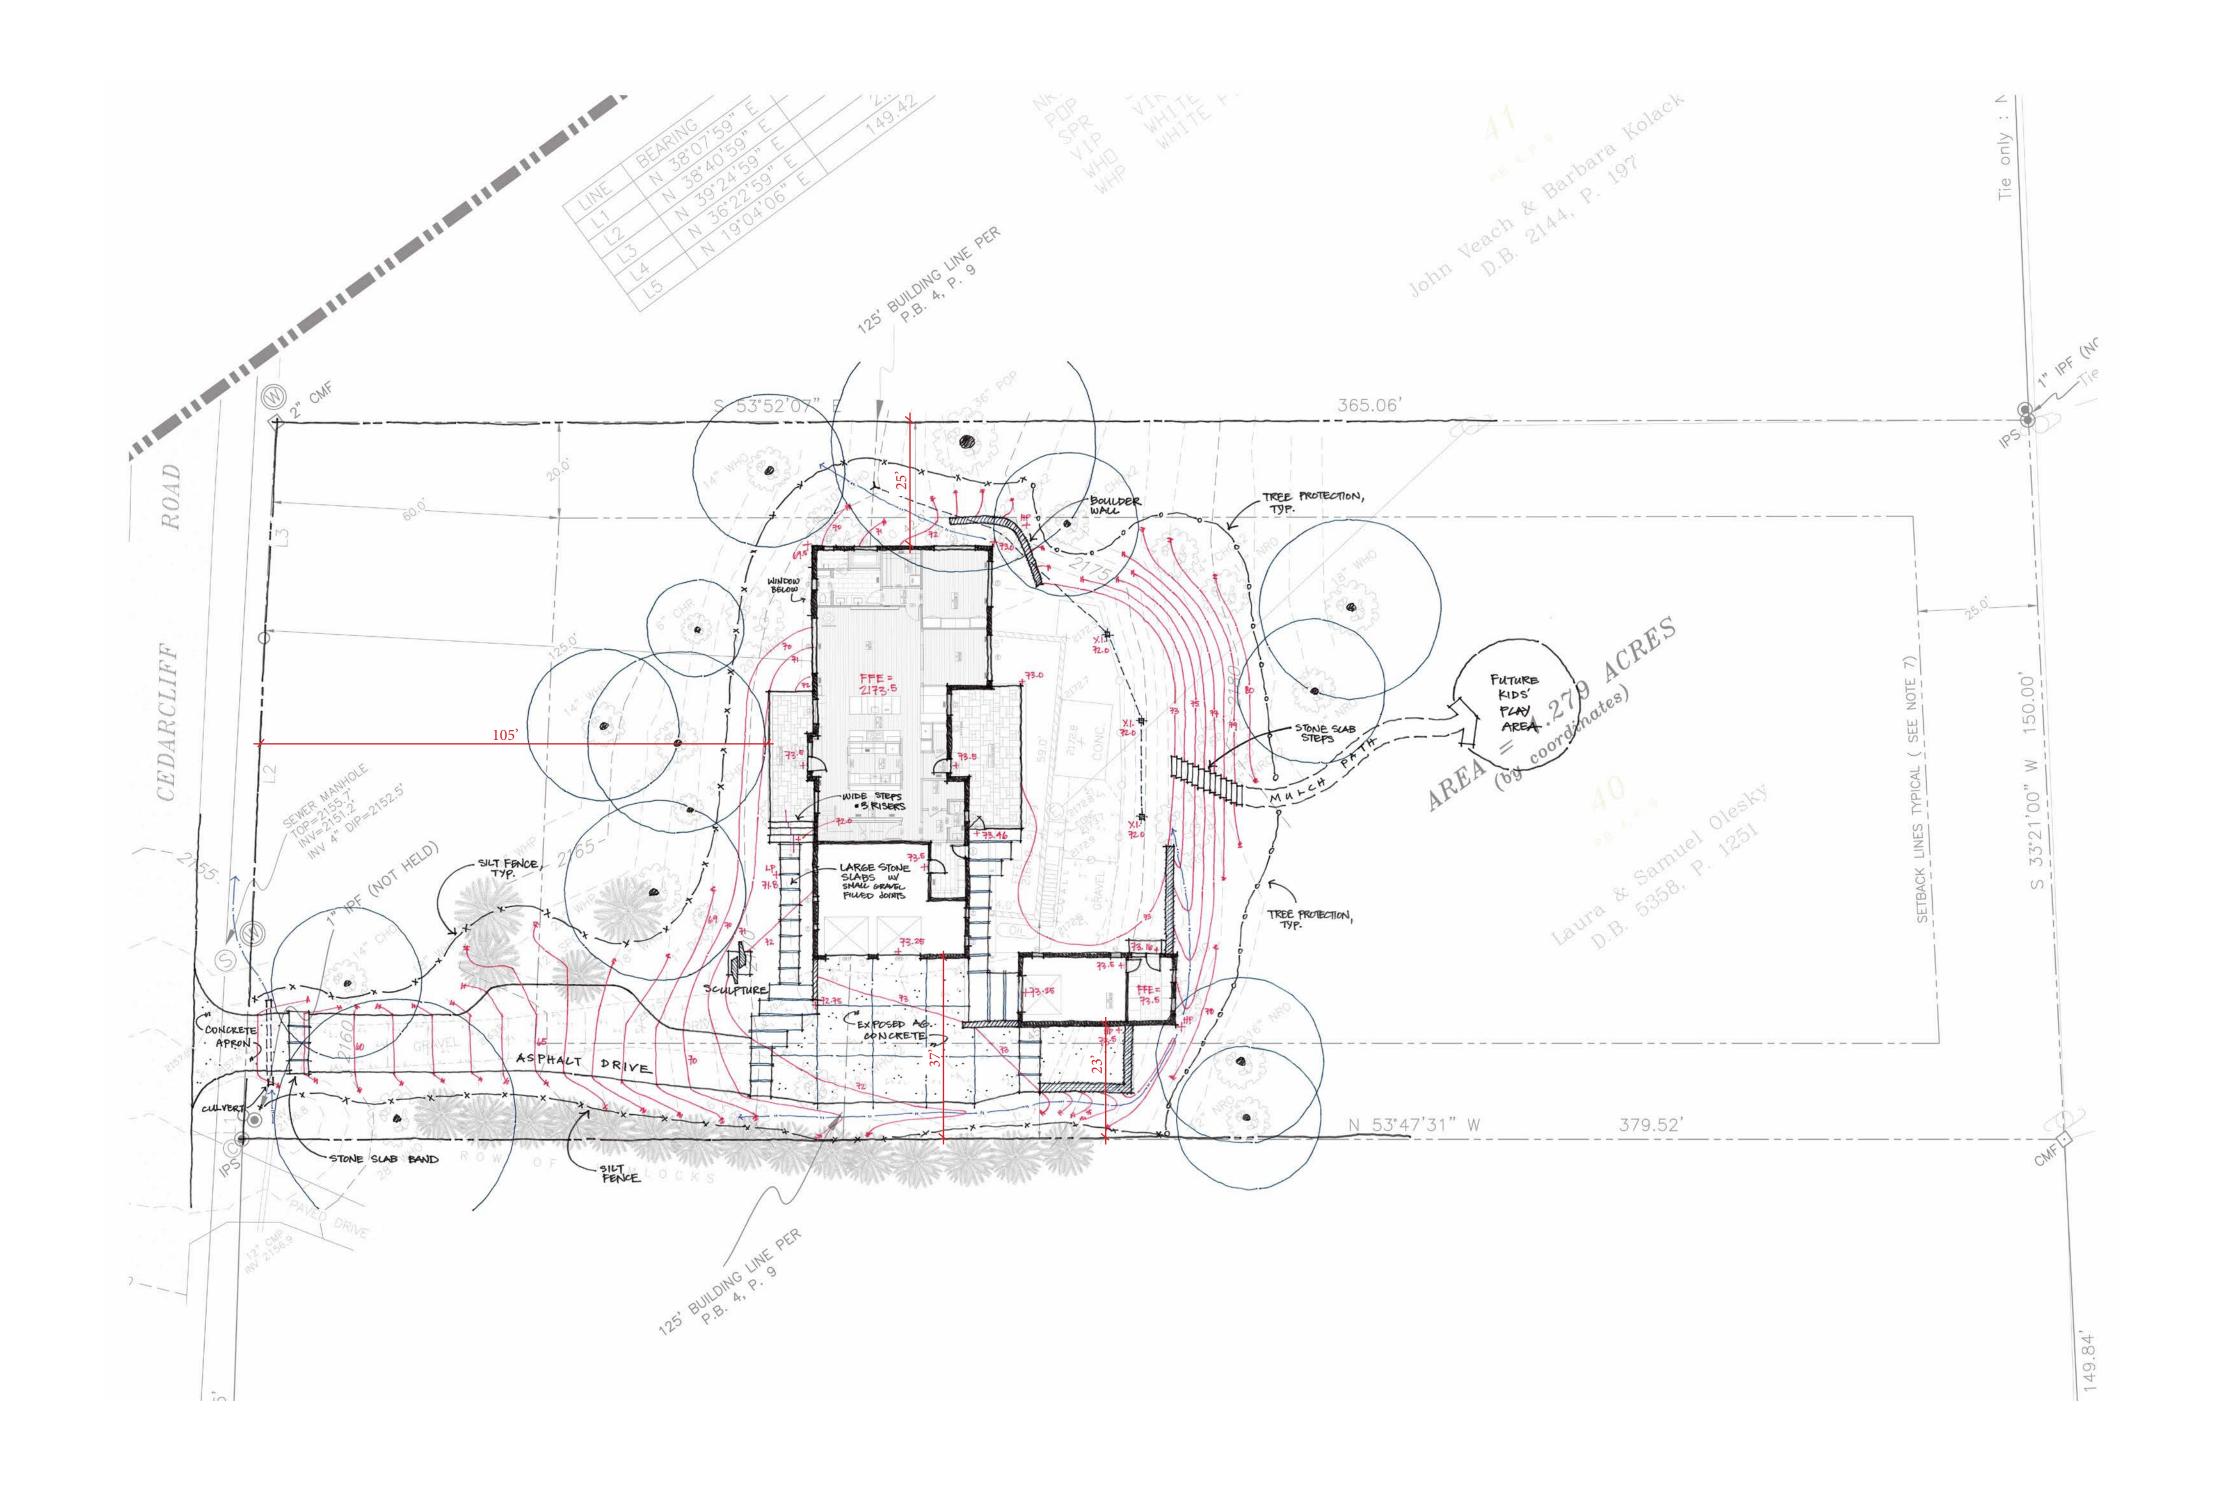
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SHEET #:

G-001



# DEVELOPMENT DATA

LOCATION:

22 Cedarcliff Road
Biltmore Forest, NC 28803

PIN:
9647-62-6756

PROPERTY OWNERS:
Sam and Laura Olesky
CONTACT:
Joel Osgood, RLA
Osgood Landscape Architecture, Inc.
14 Church Street
Asheville, NC 28801
828.527.6566

PROPERTY SIZE:
1.26 Acres (54,885.6 SF)
AREA OF DISTURBANCE
0.39 Acres (SF)

SCALE: 1" = 20'-0"


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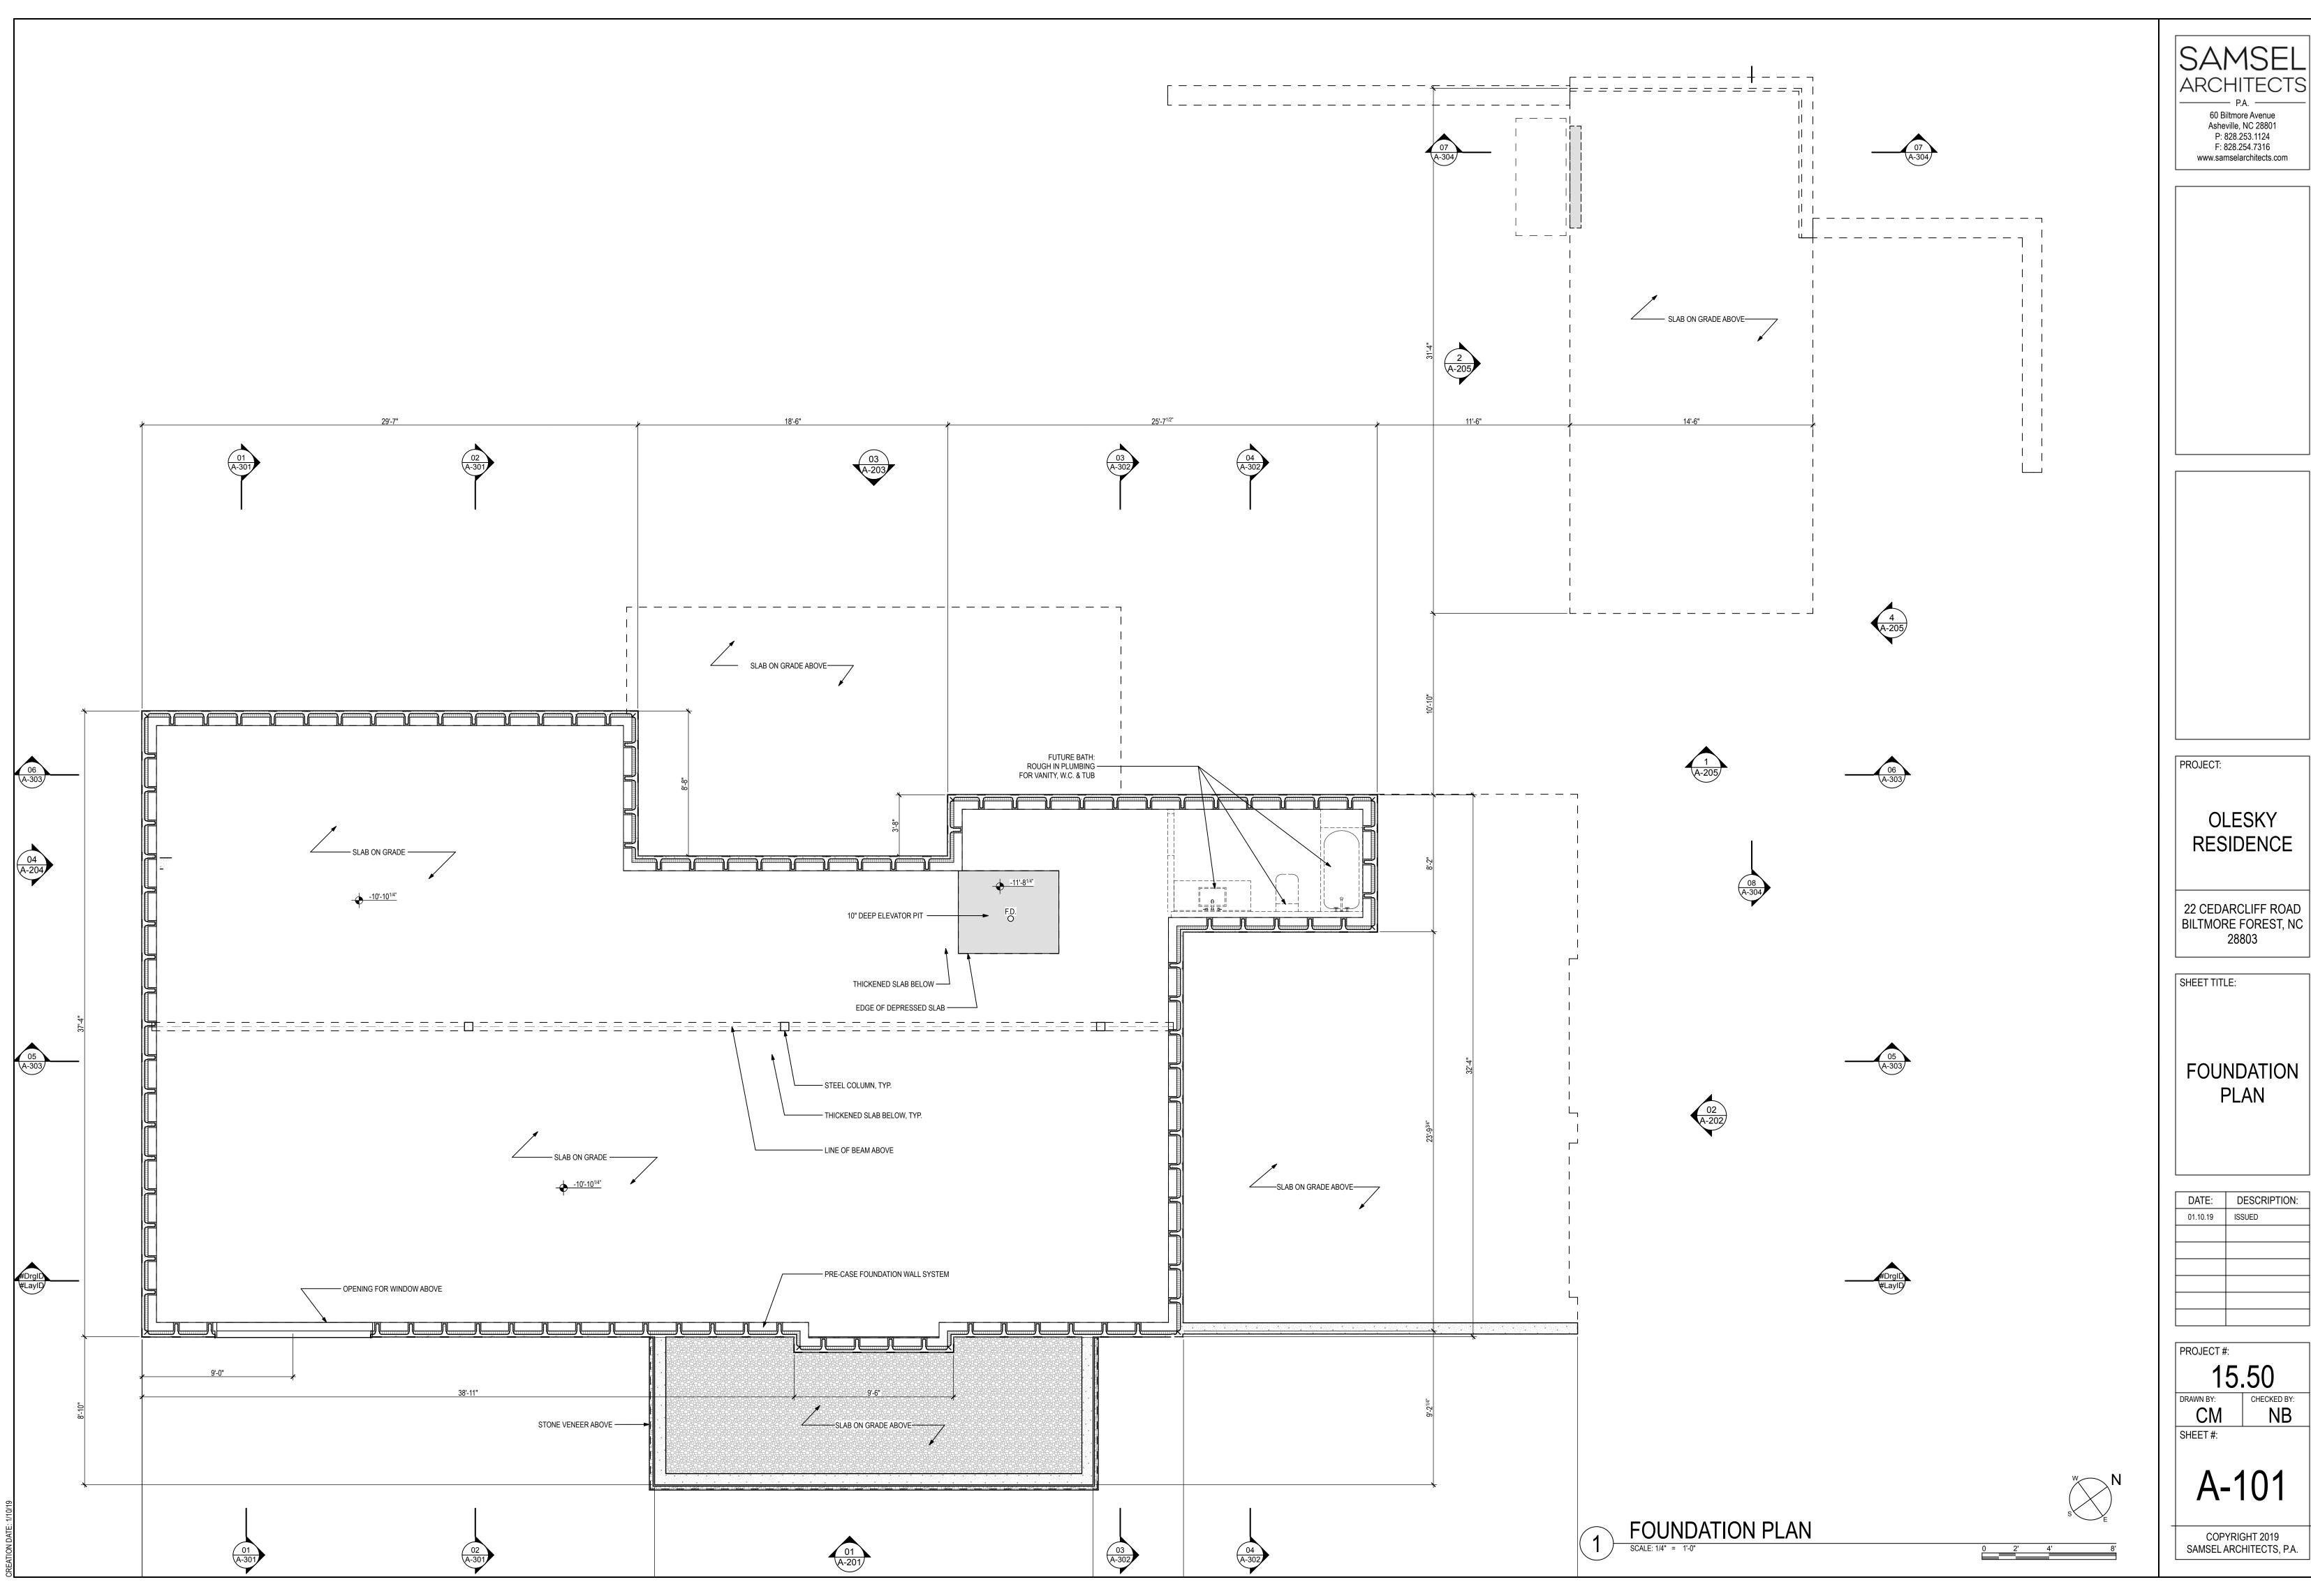
OLESKY RESIDENCE

# OVERALL SITE PLAN


January 10, 2019 Biltmore Forest, North Carolina






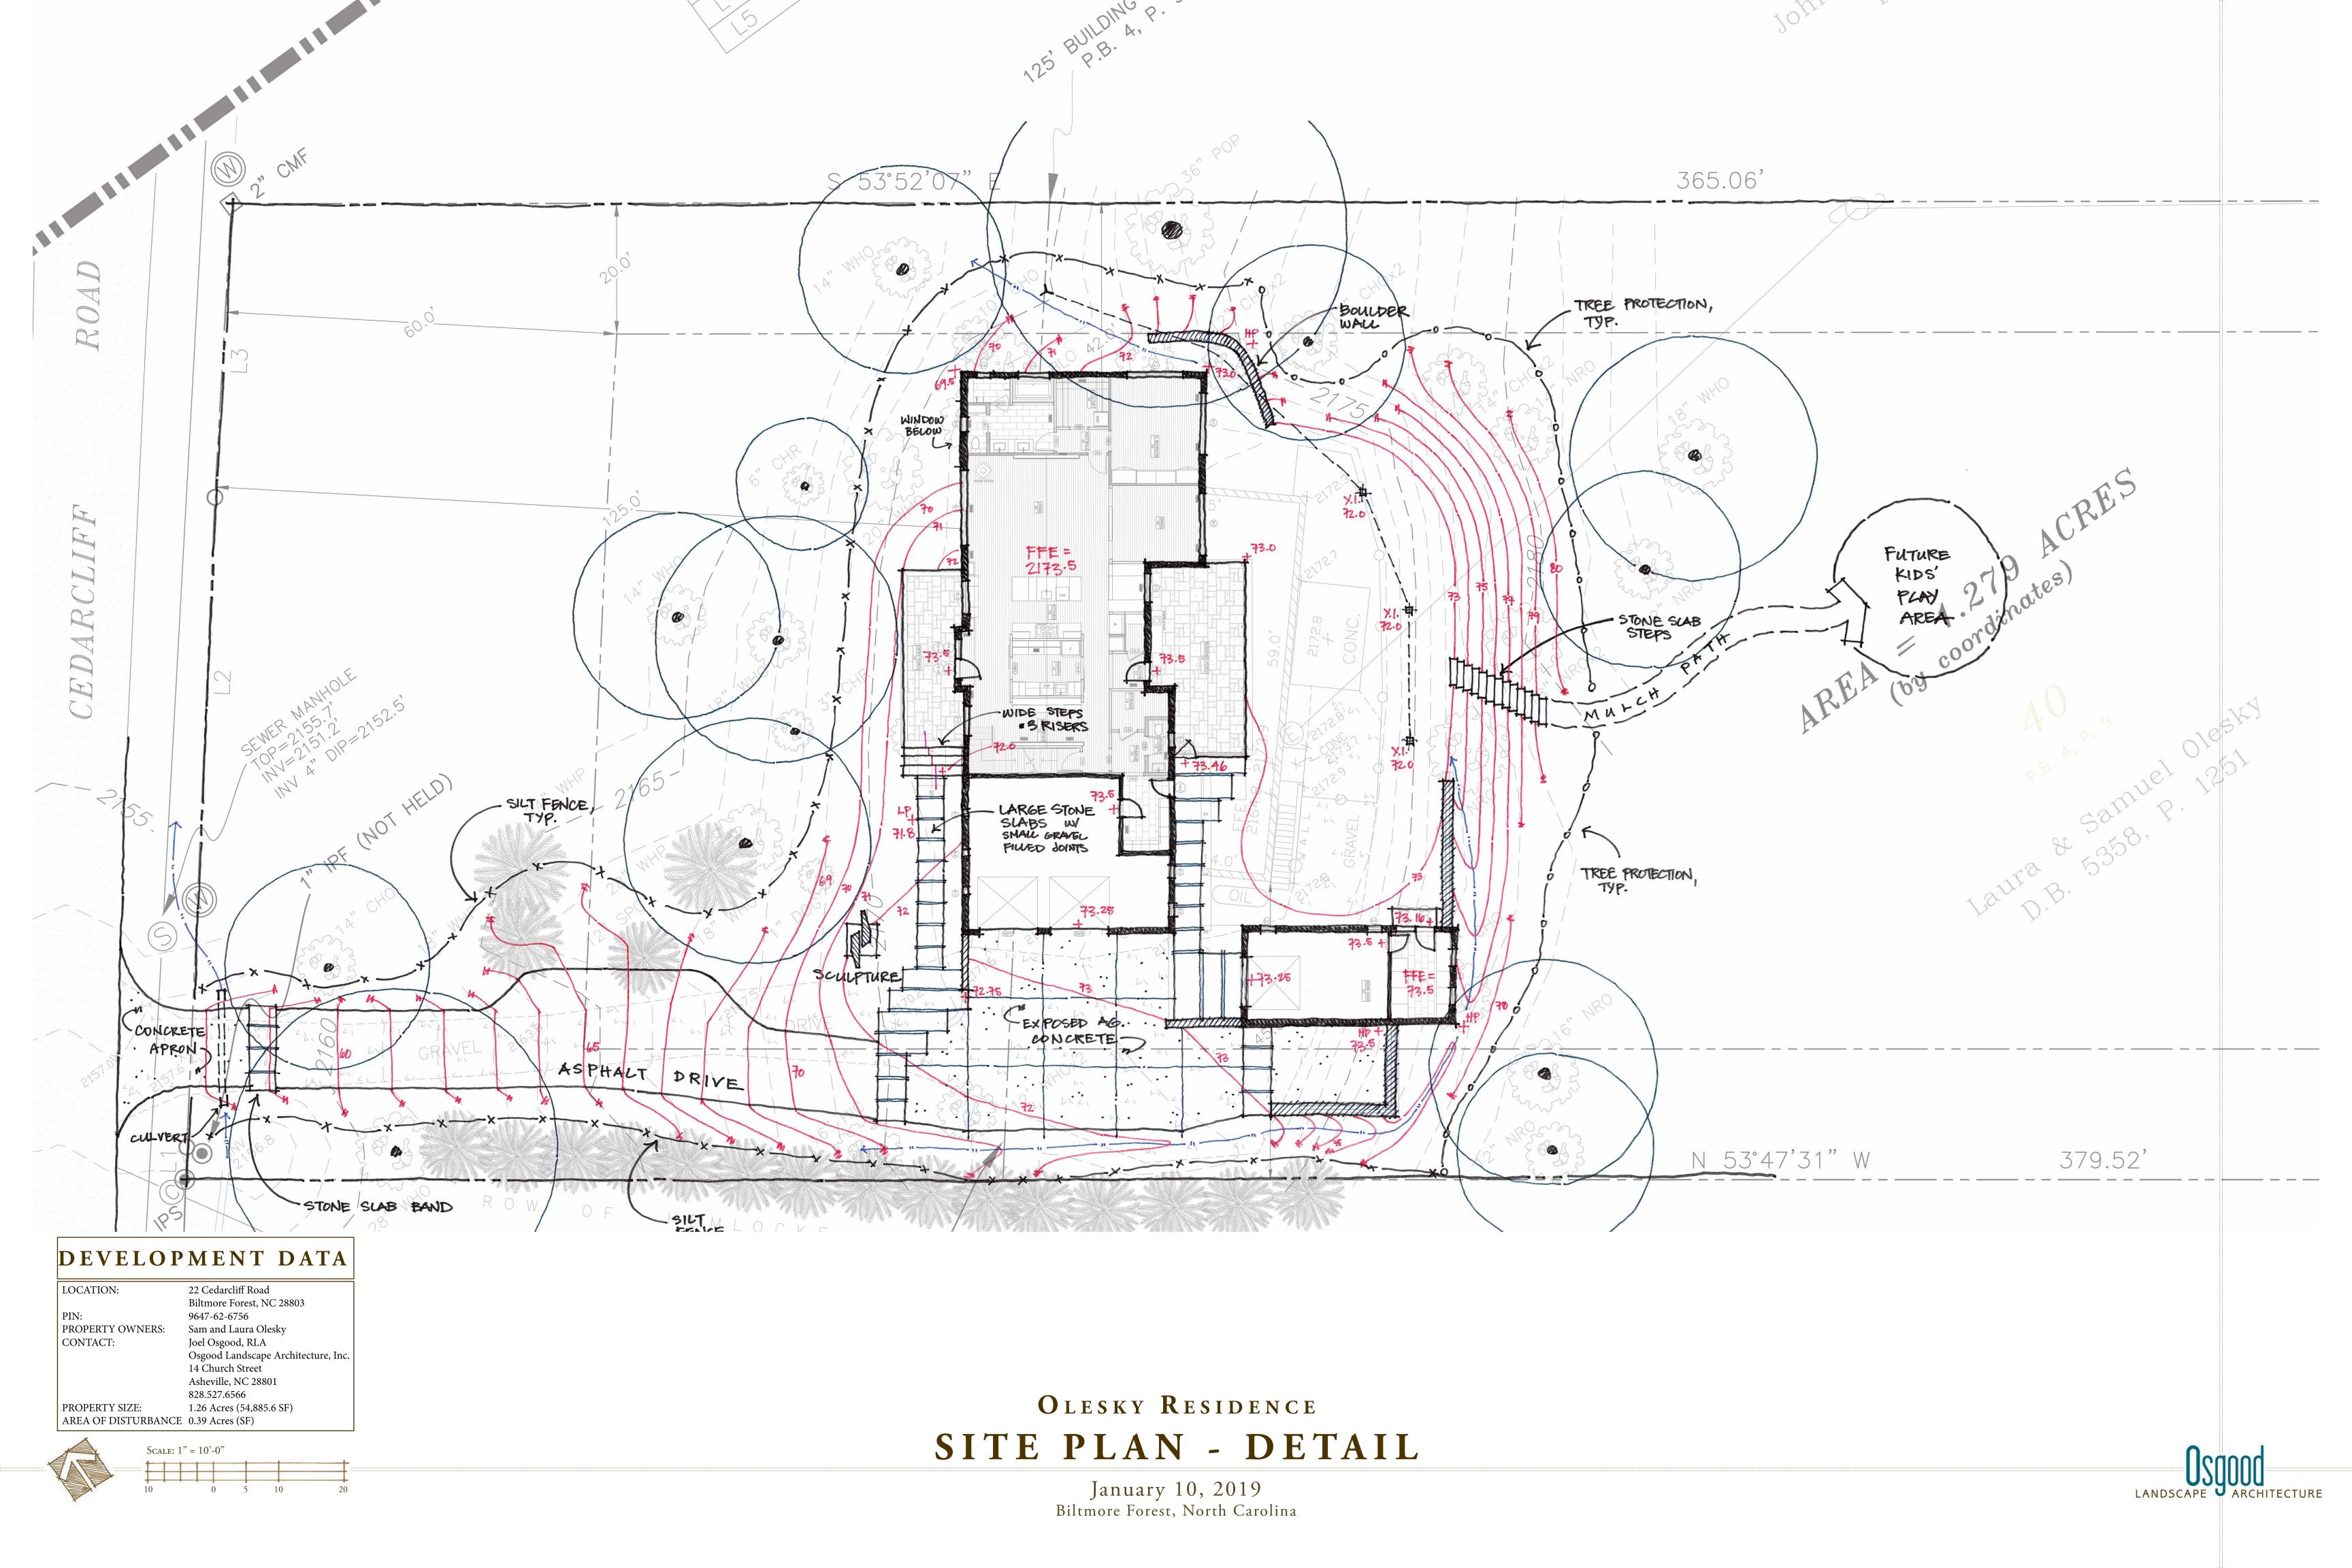



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DATE:	DESCRIPTION:
01.10.19	ISSUED

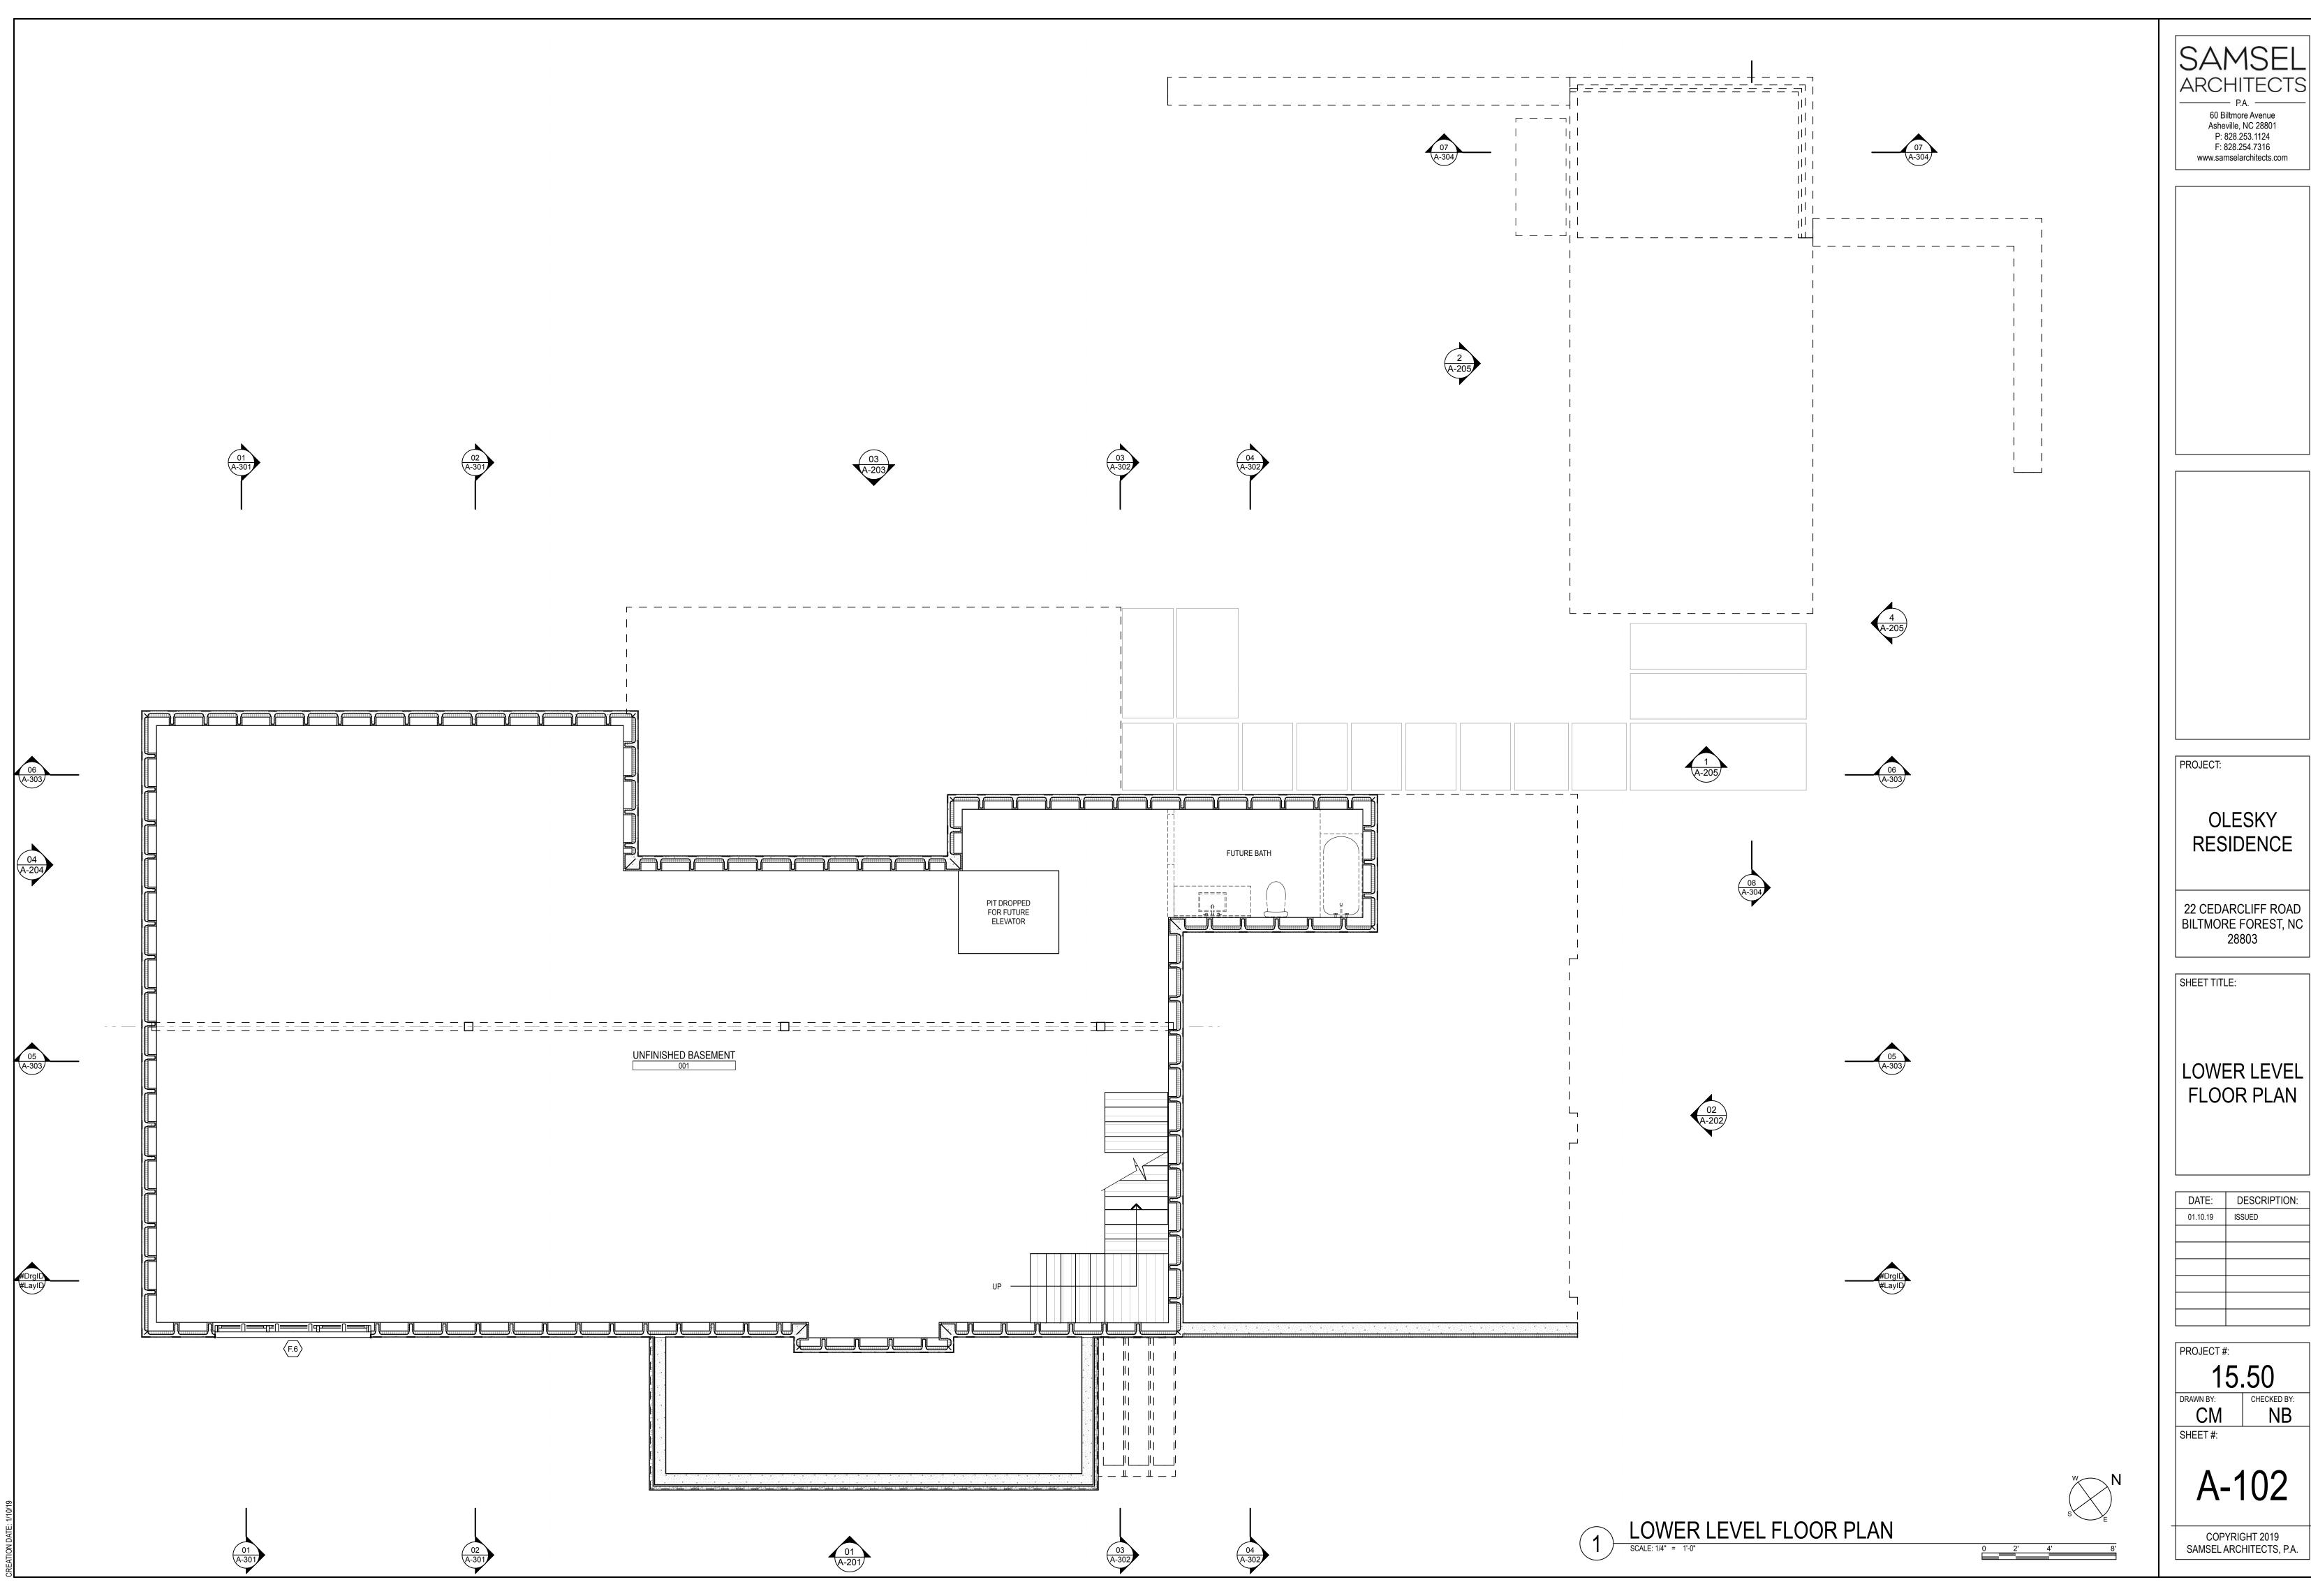



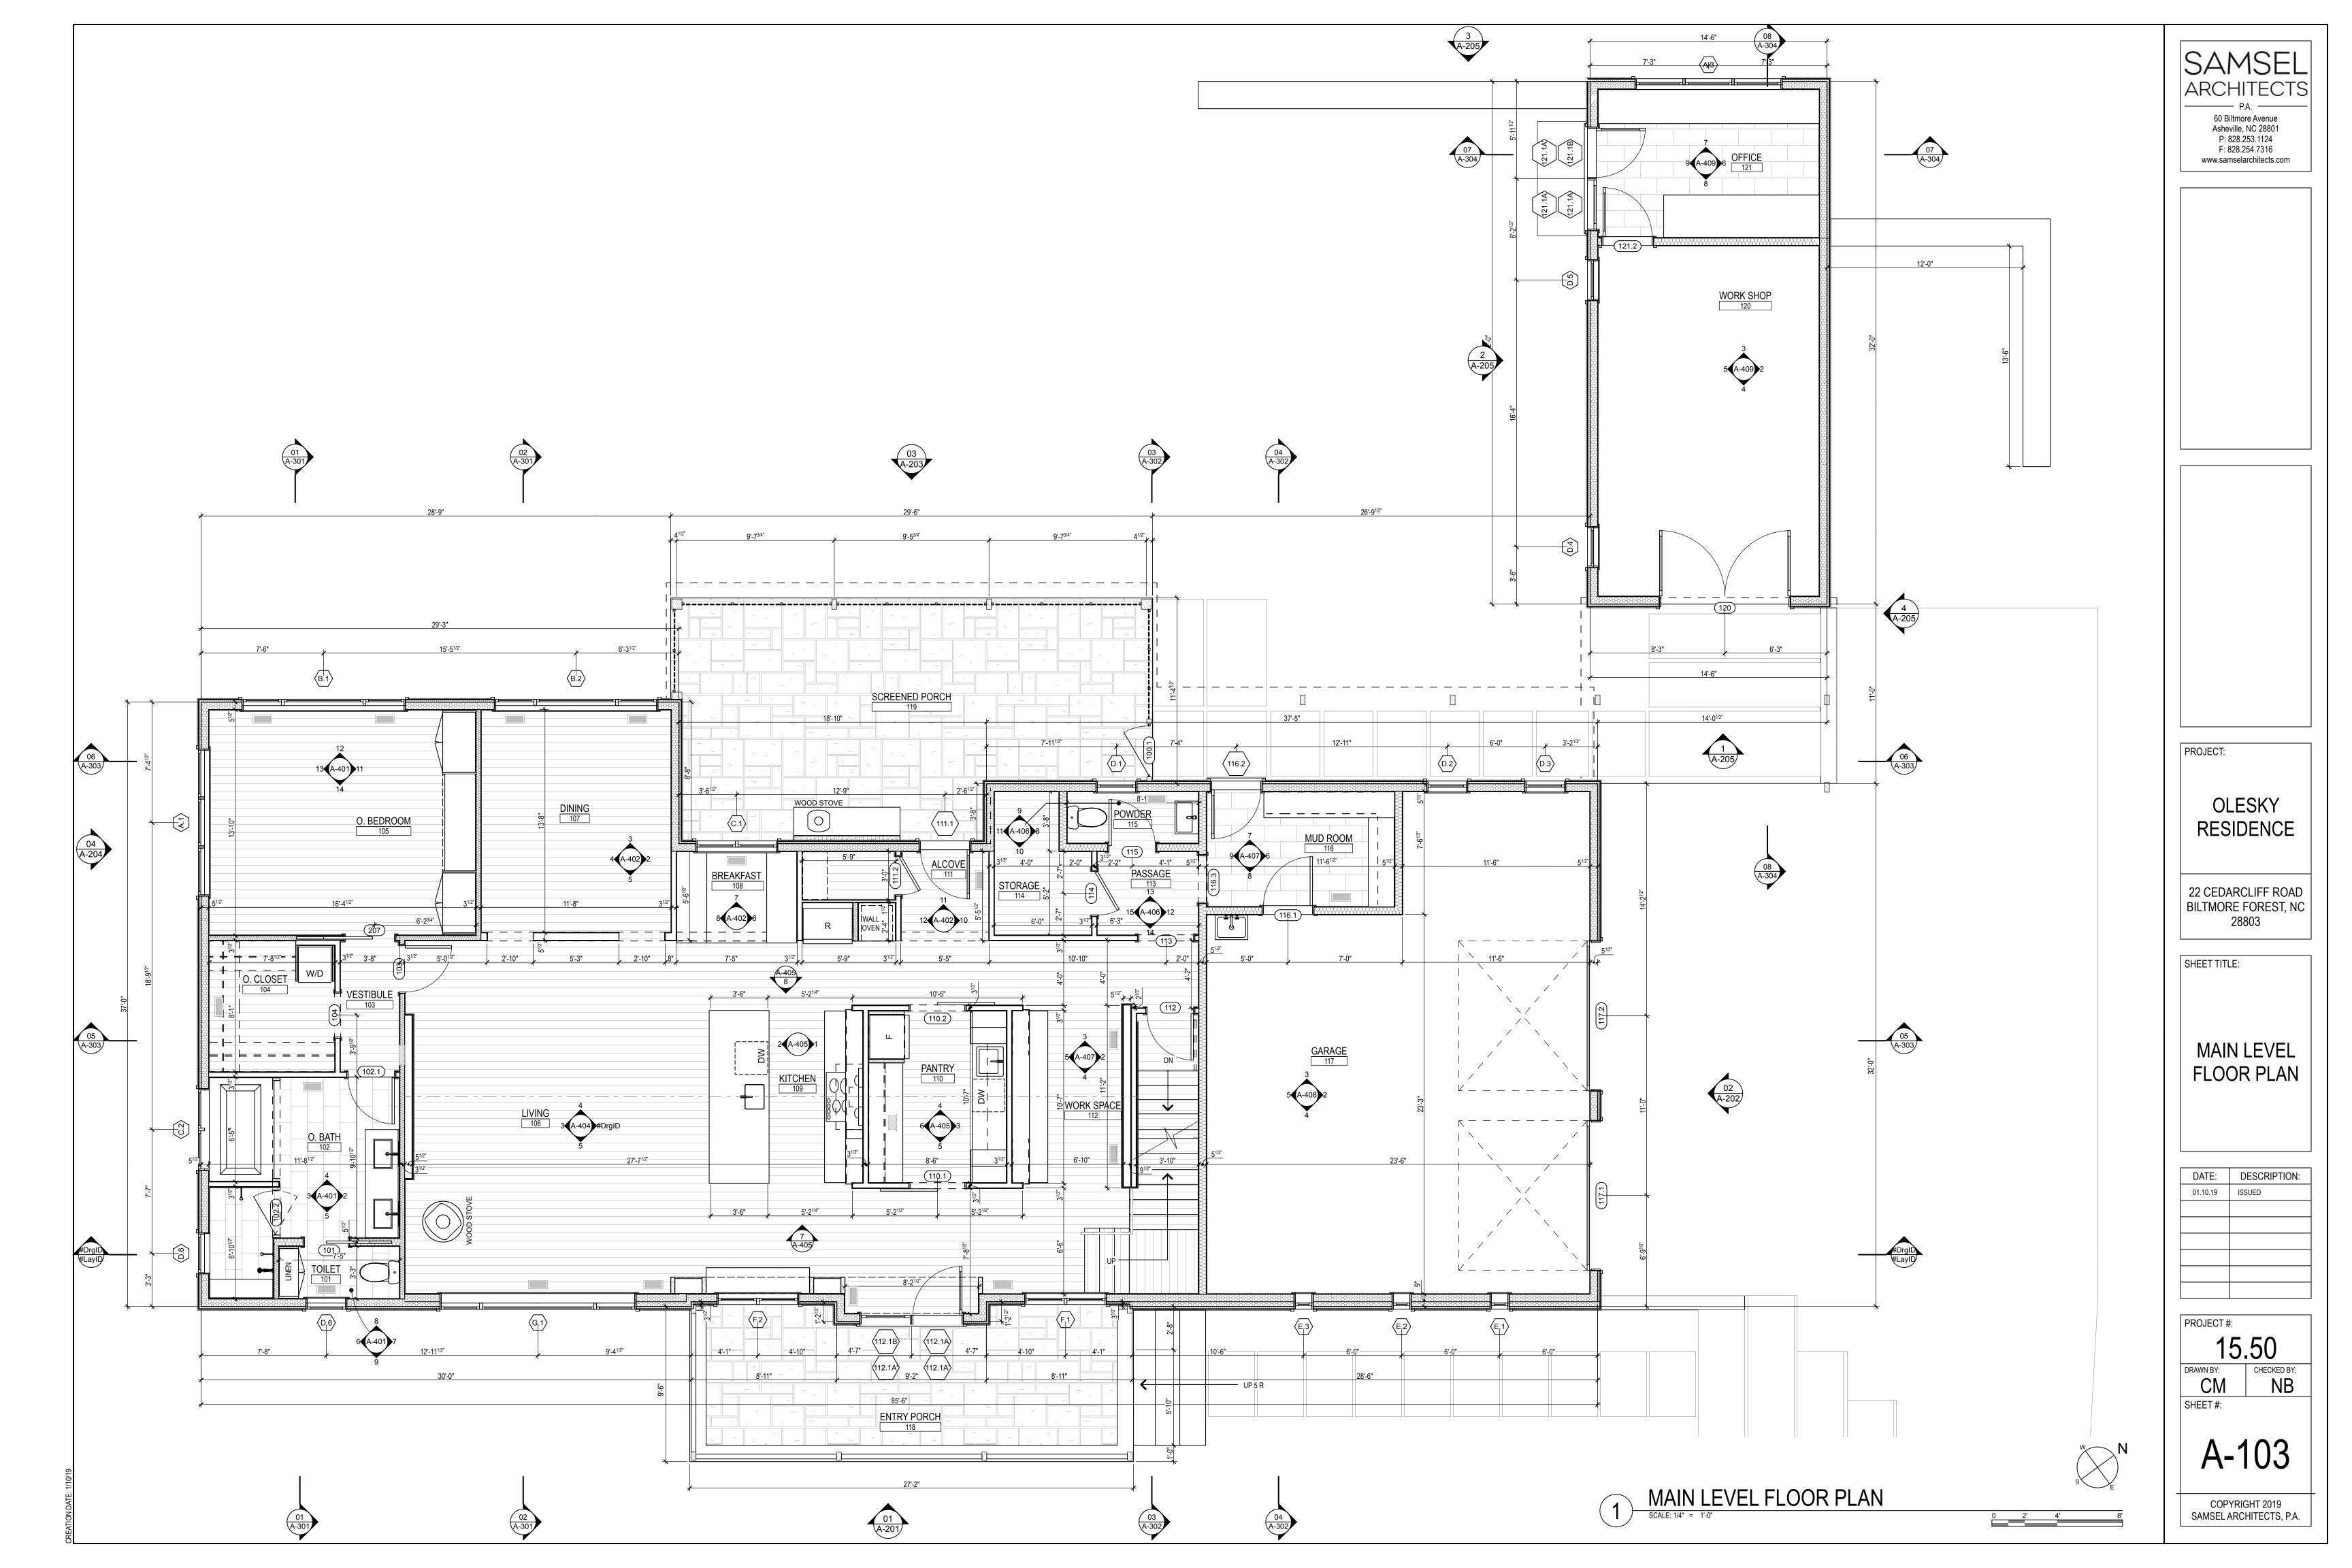

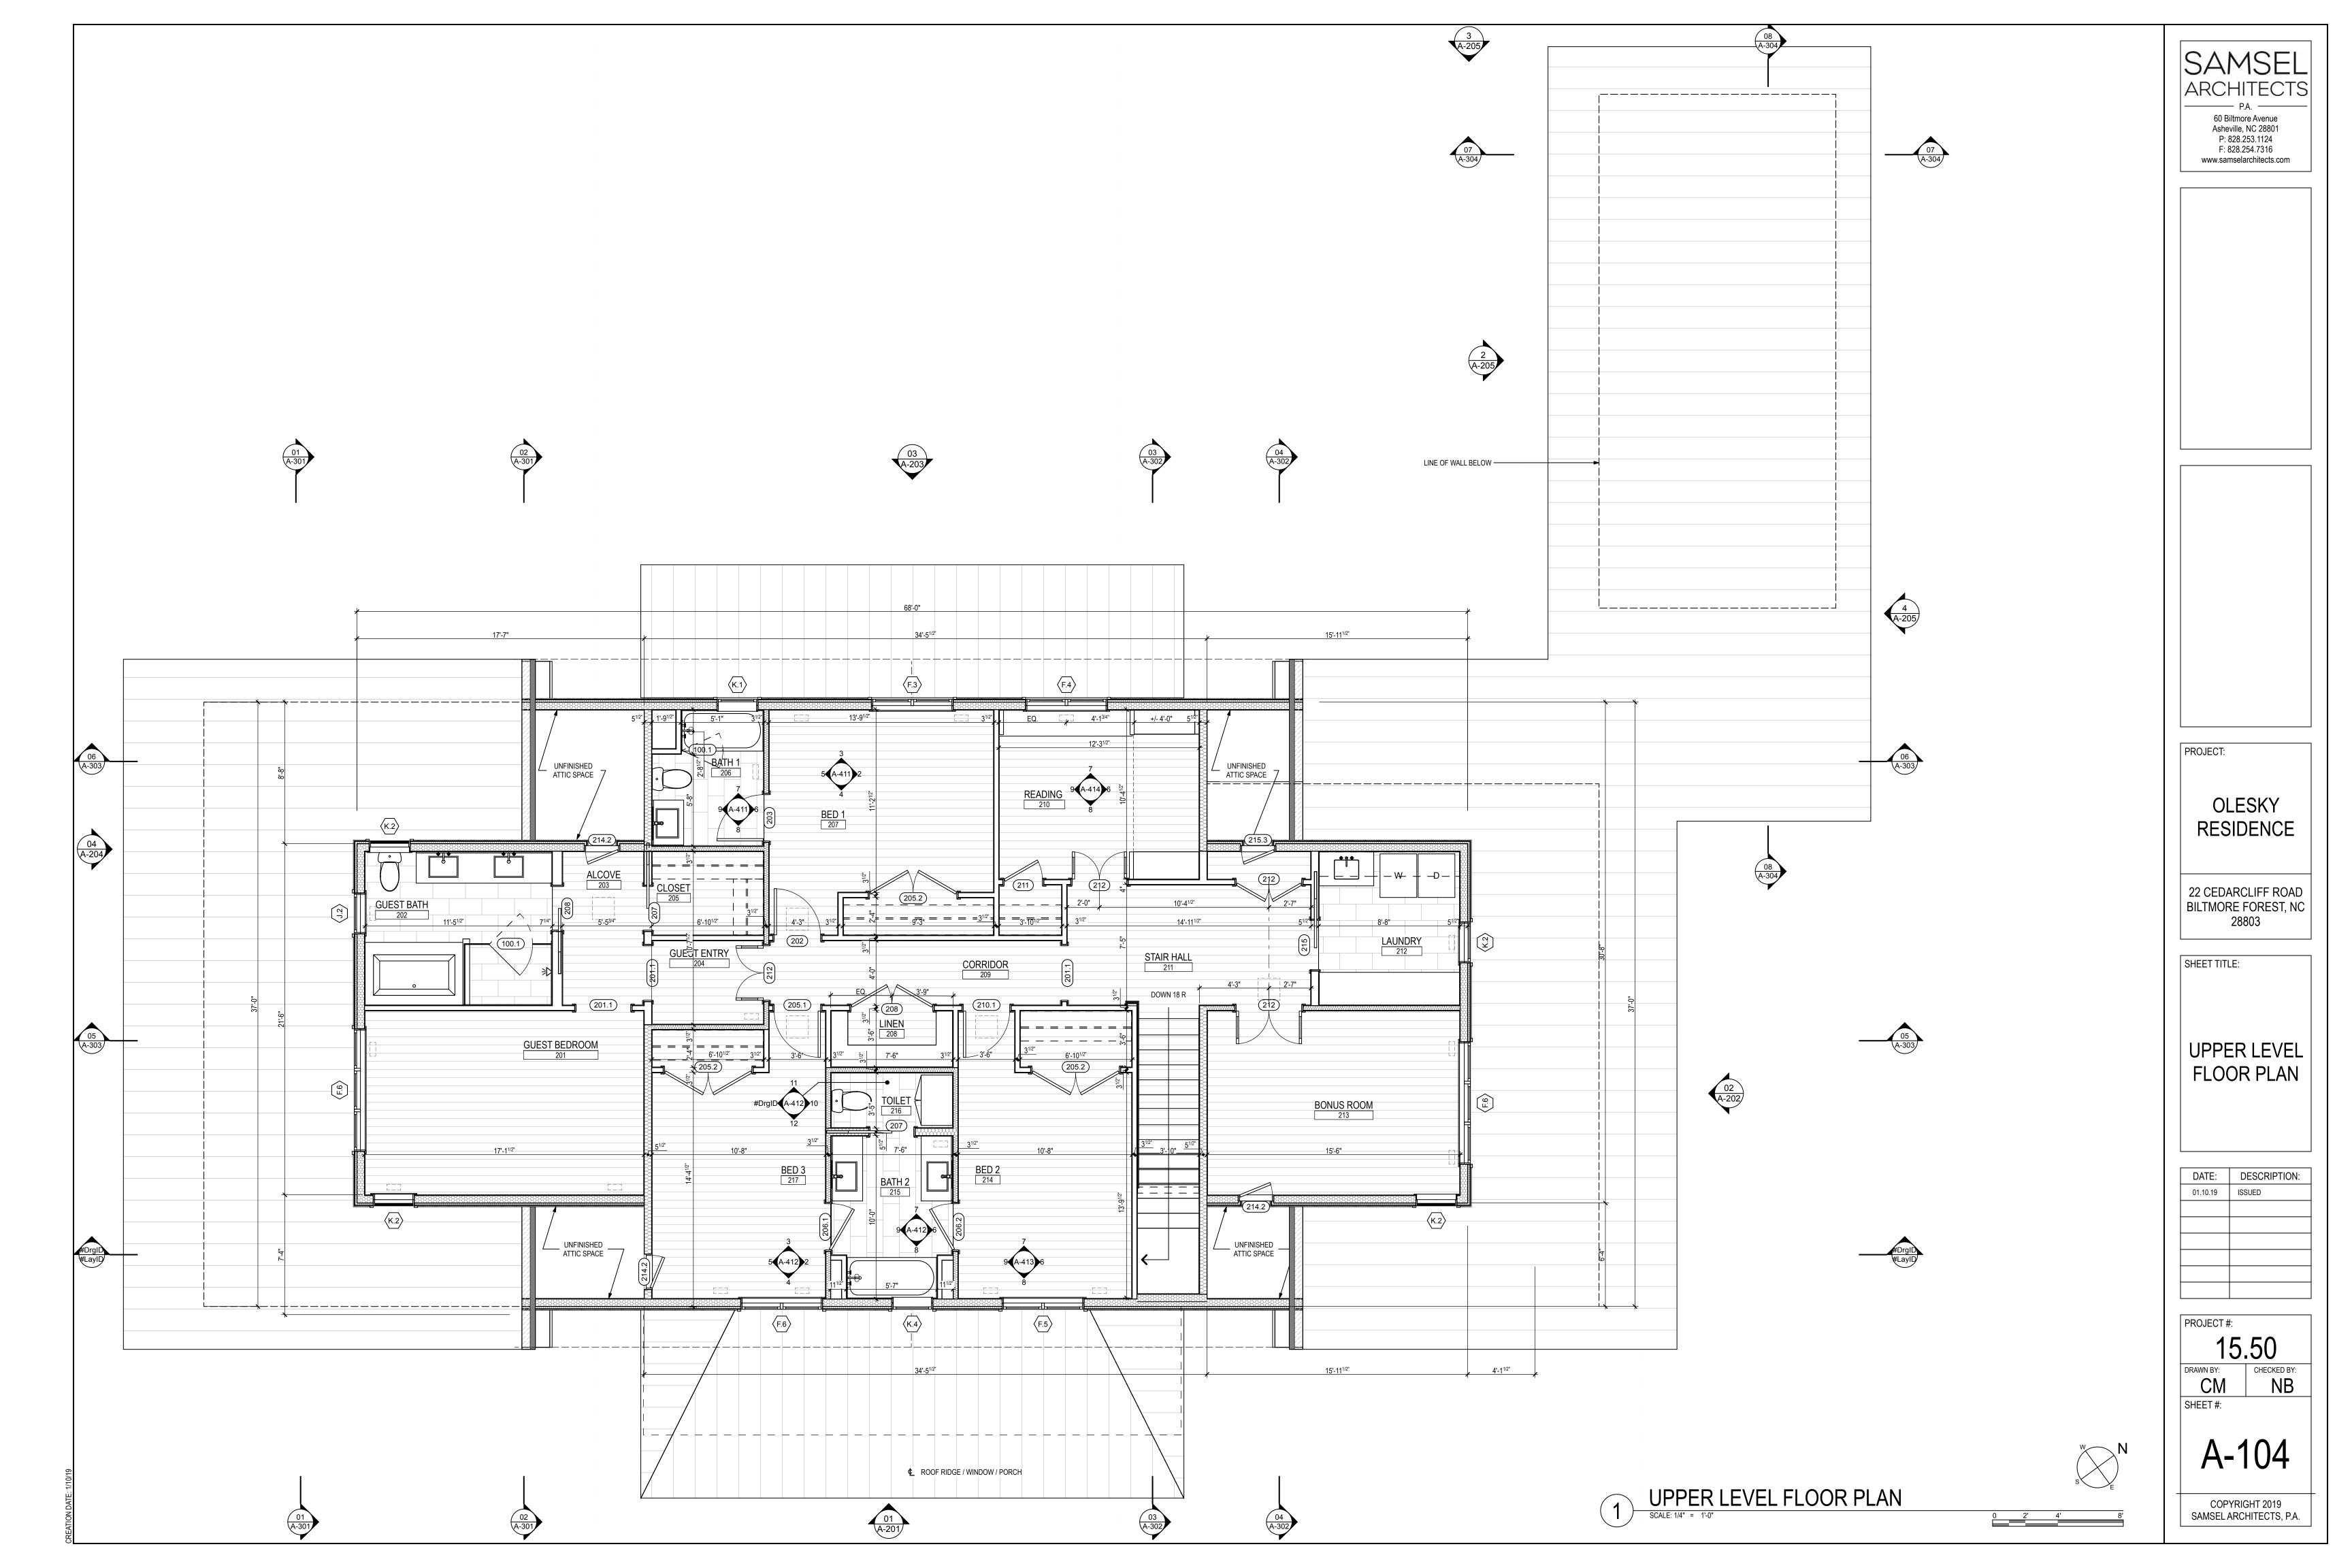60 Biltmore Avenue Asheville, NC 28801 P: 828.253.1124 F: 828.254.7316

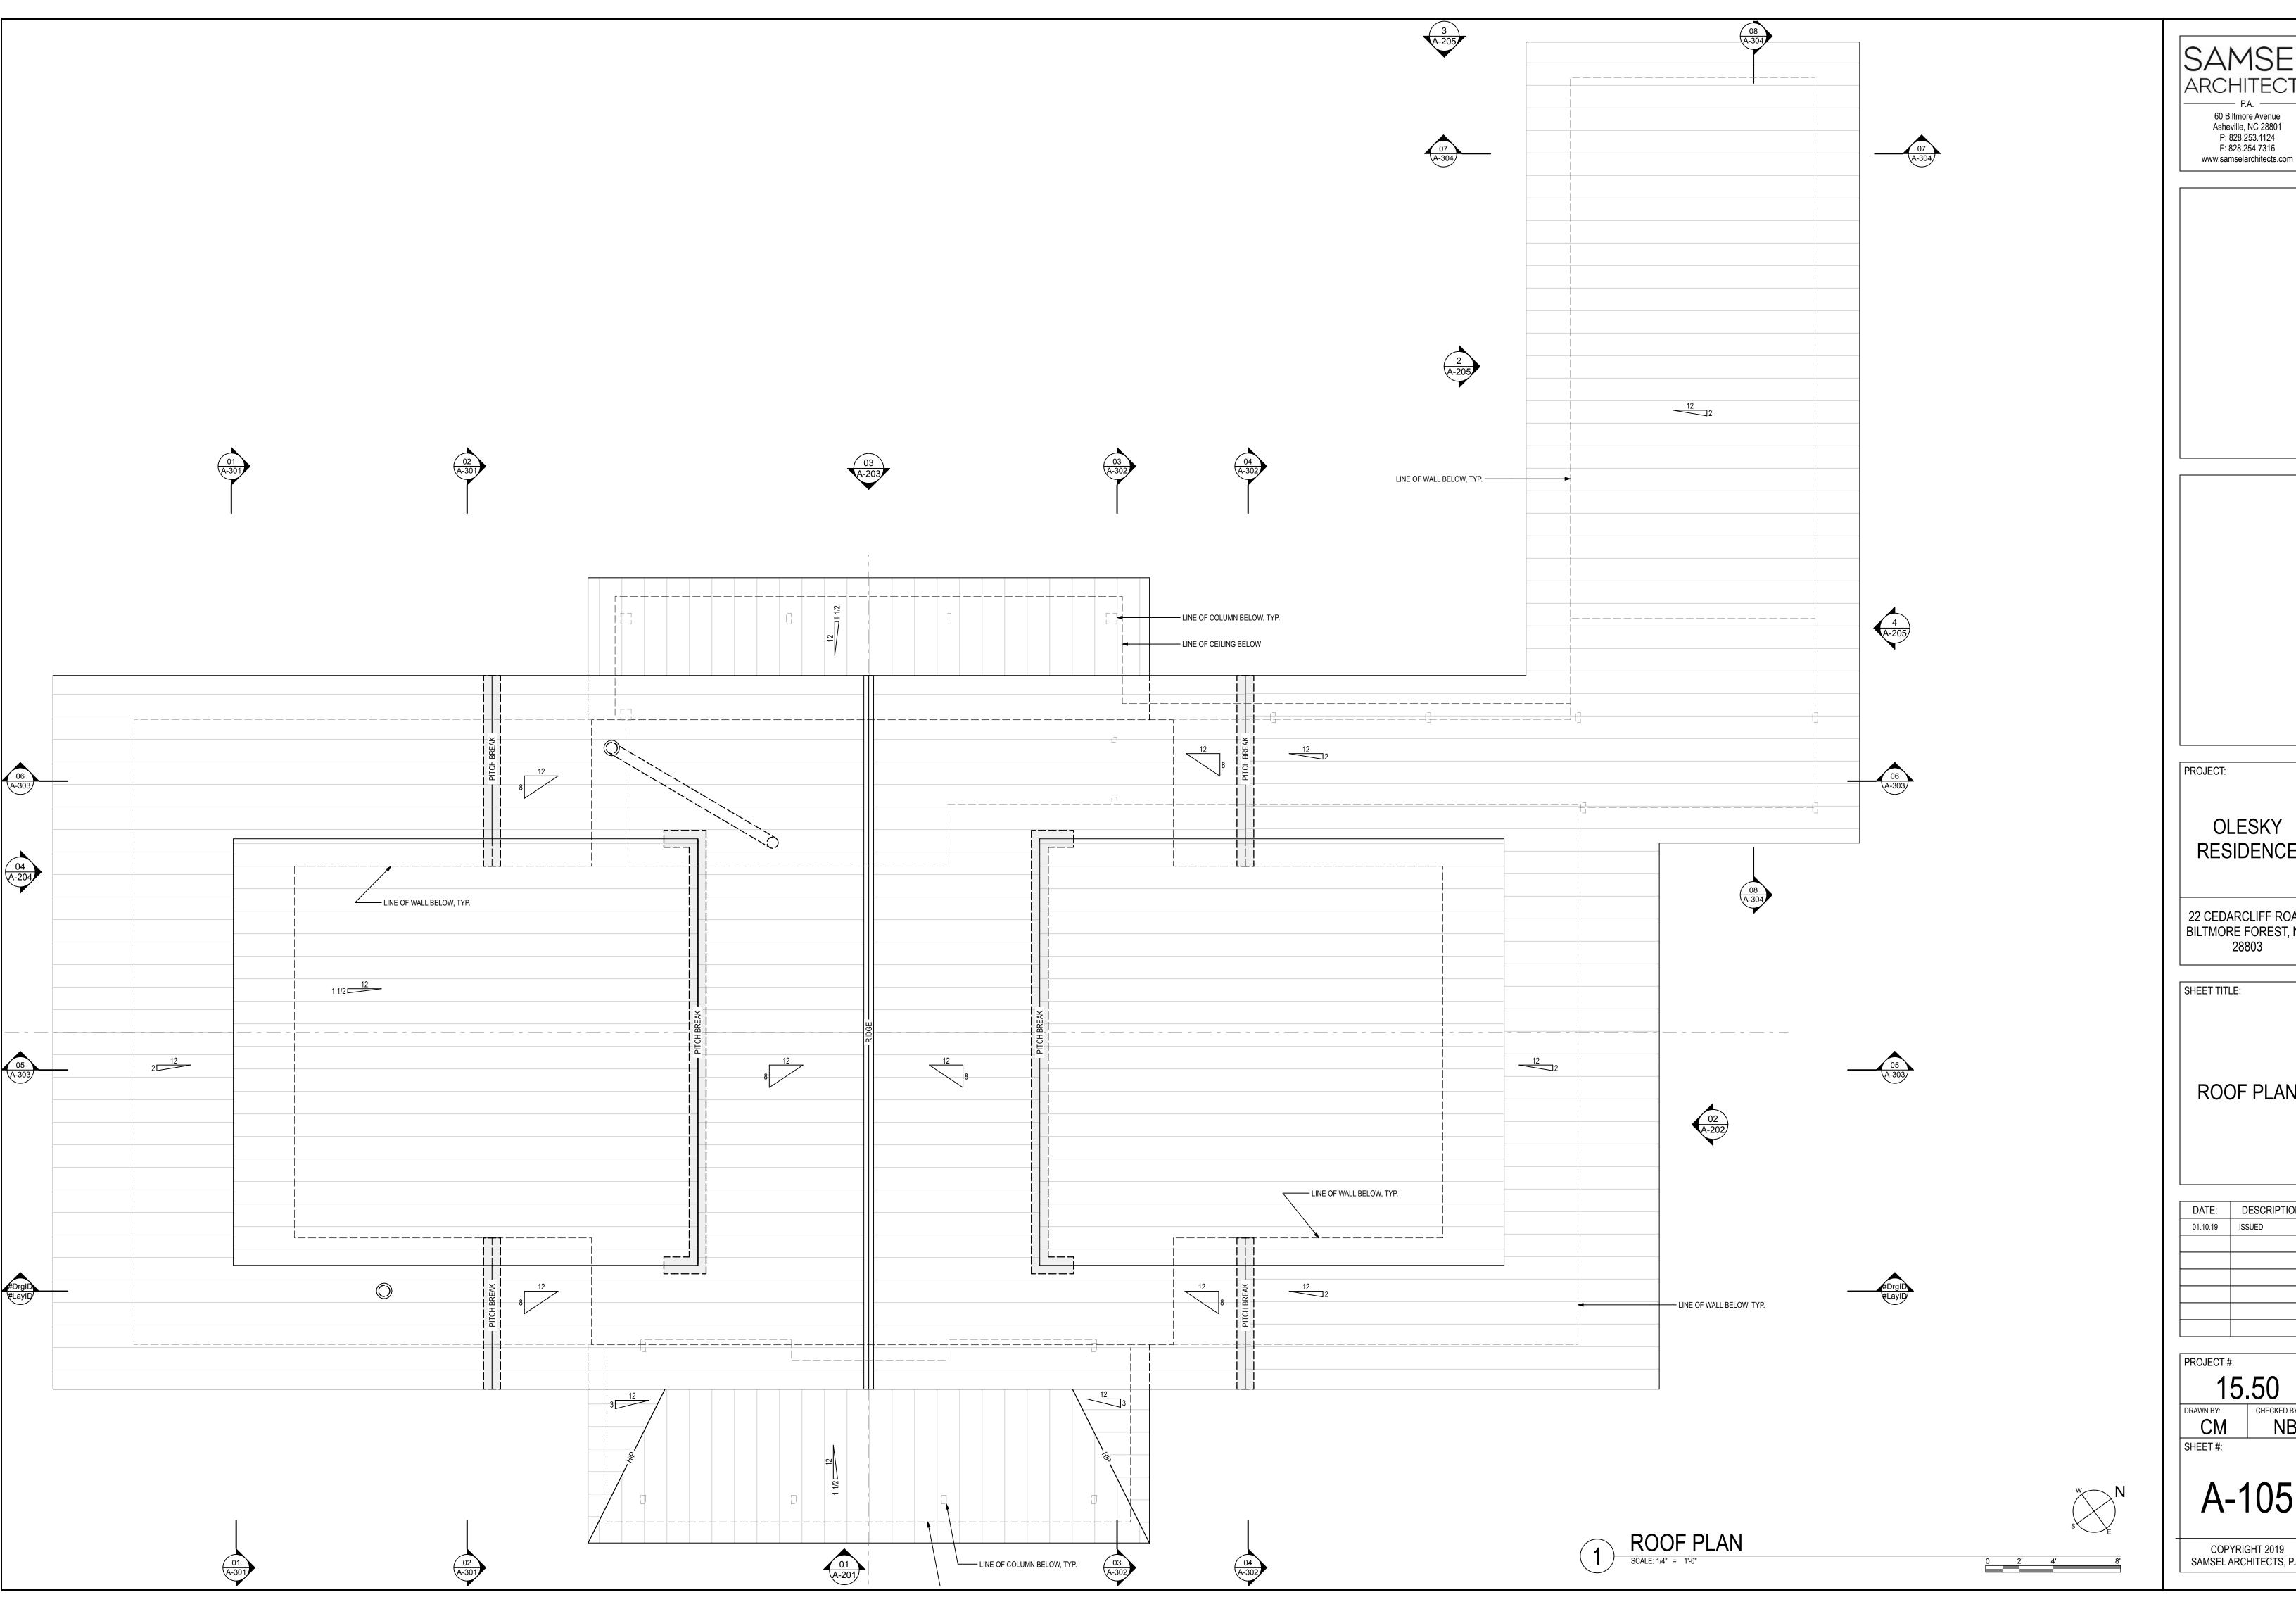OLESKY RESIDENCE

22 CEDARCLIFF ROAD BILTMORE FOREST, NC 28803

**ROOF PLAN** 

DATE:	DESCRIPTION:
01.10.19	ISSUED



60 Biltmore Avenue Asheville, NC 28801 P: 828.253.1124 F: 828.254.7316 www.samselarchitects.com

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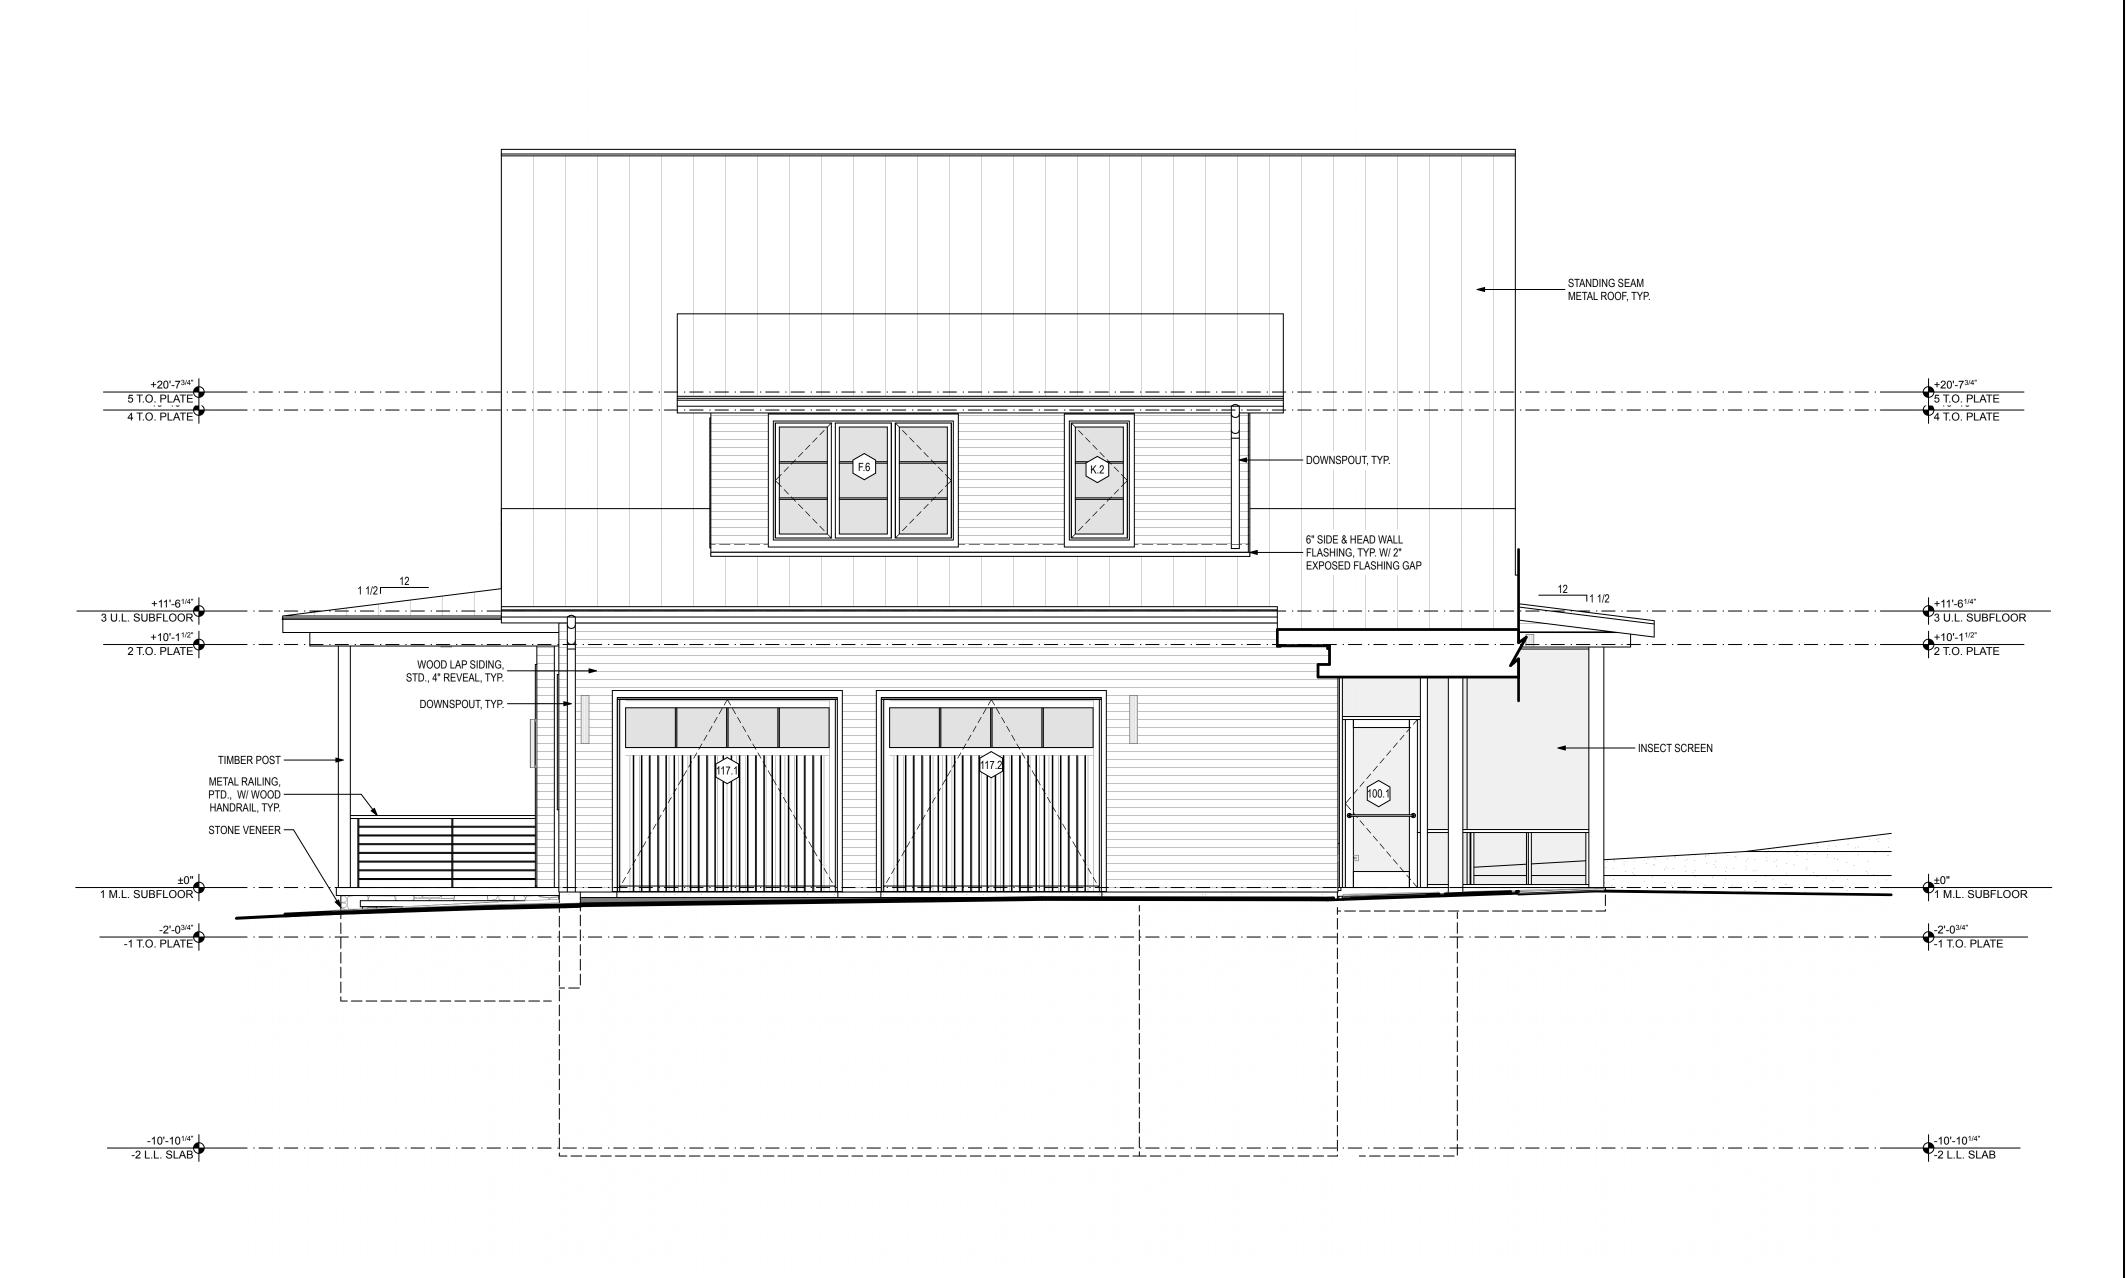
22 CEDARCLIFF ROAD BILTMORE FOREST, NC 28803

SHEET TITLE:

**EXTERIOR ELEVATIONS** 

DATE:	DESCRIPTION:
01.10.19	ISSUED

PROJECT #:



P.A.

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SHEET TITLE:

EXTERIOR ELEVATIONS

DATE:	DESCRIPTION:
01.10.19	ISSUED

PROJECT#:

15.50

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CM CHECKED NI SHEET #:

A-202



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ARCHITECTS

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EXTERIOR ELEVATIONS

	DATE:	DESCRIPTION:
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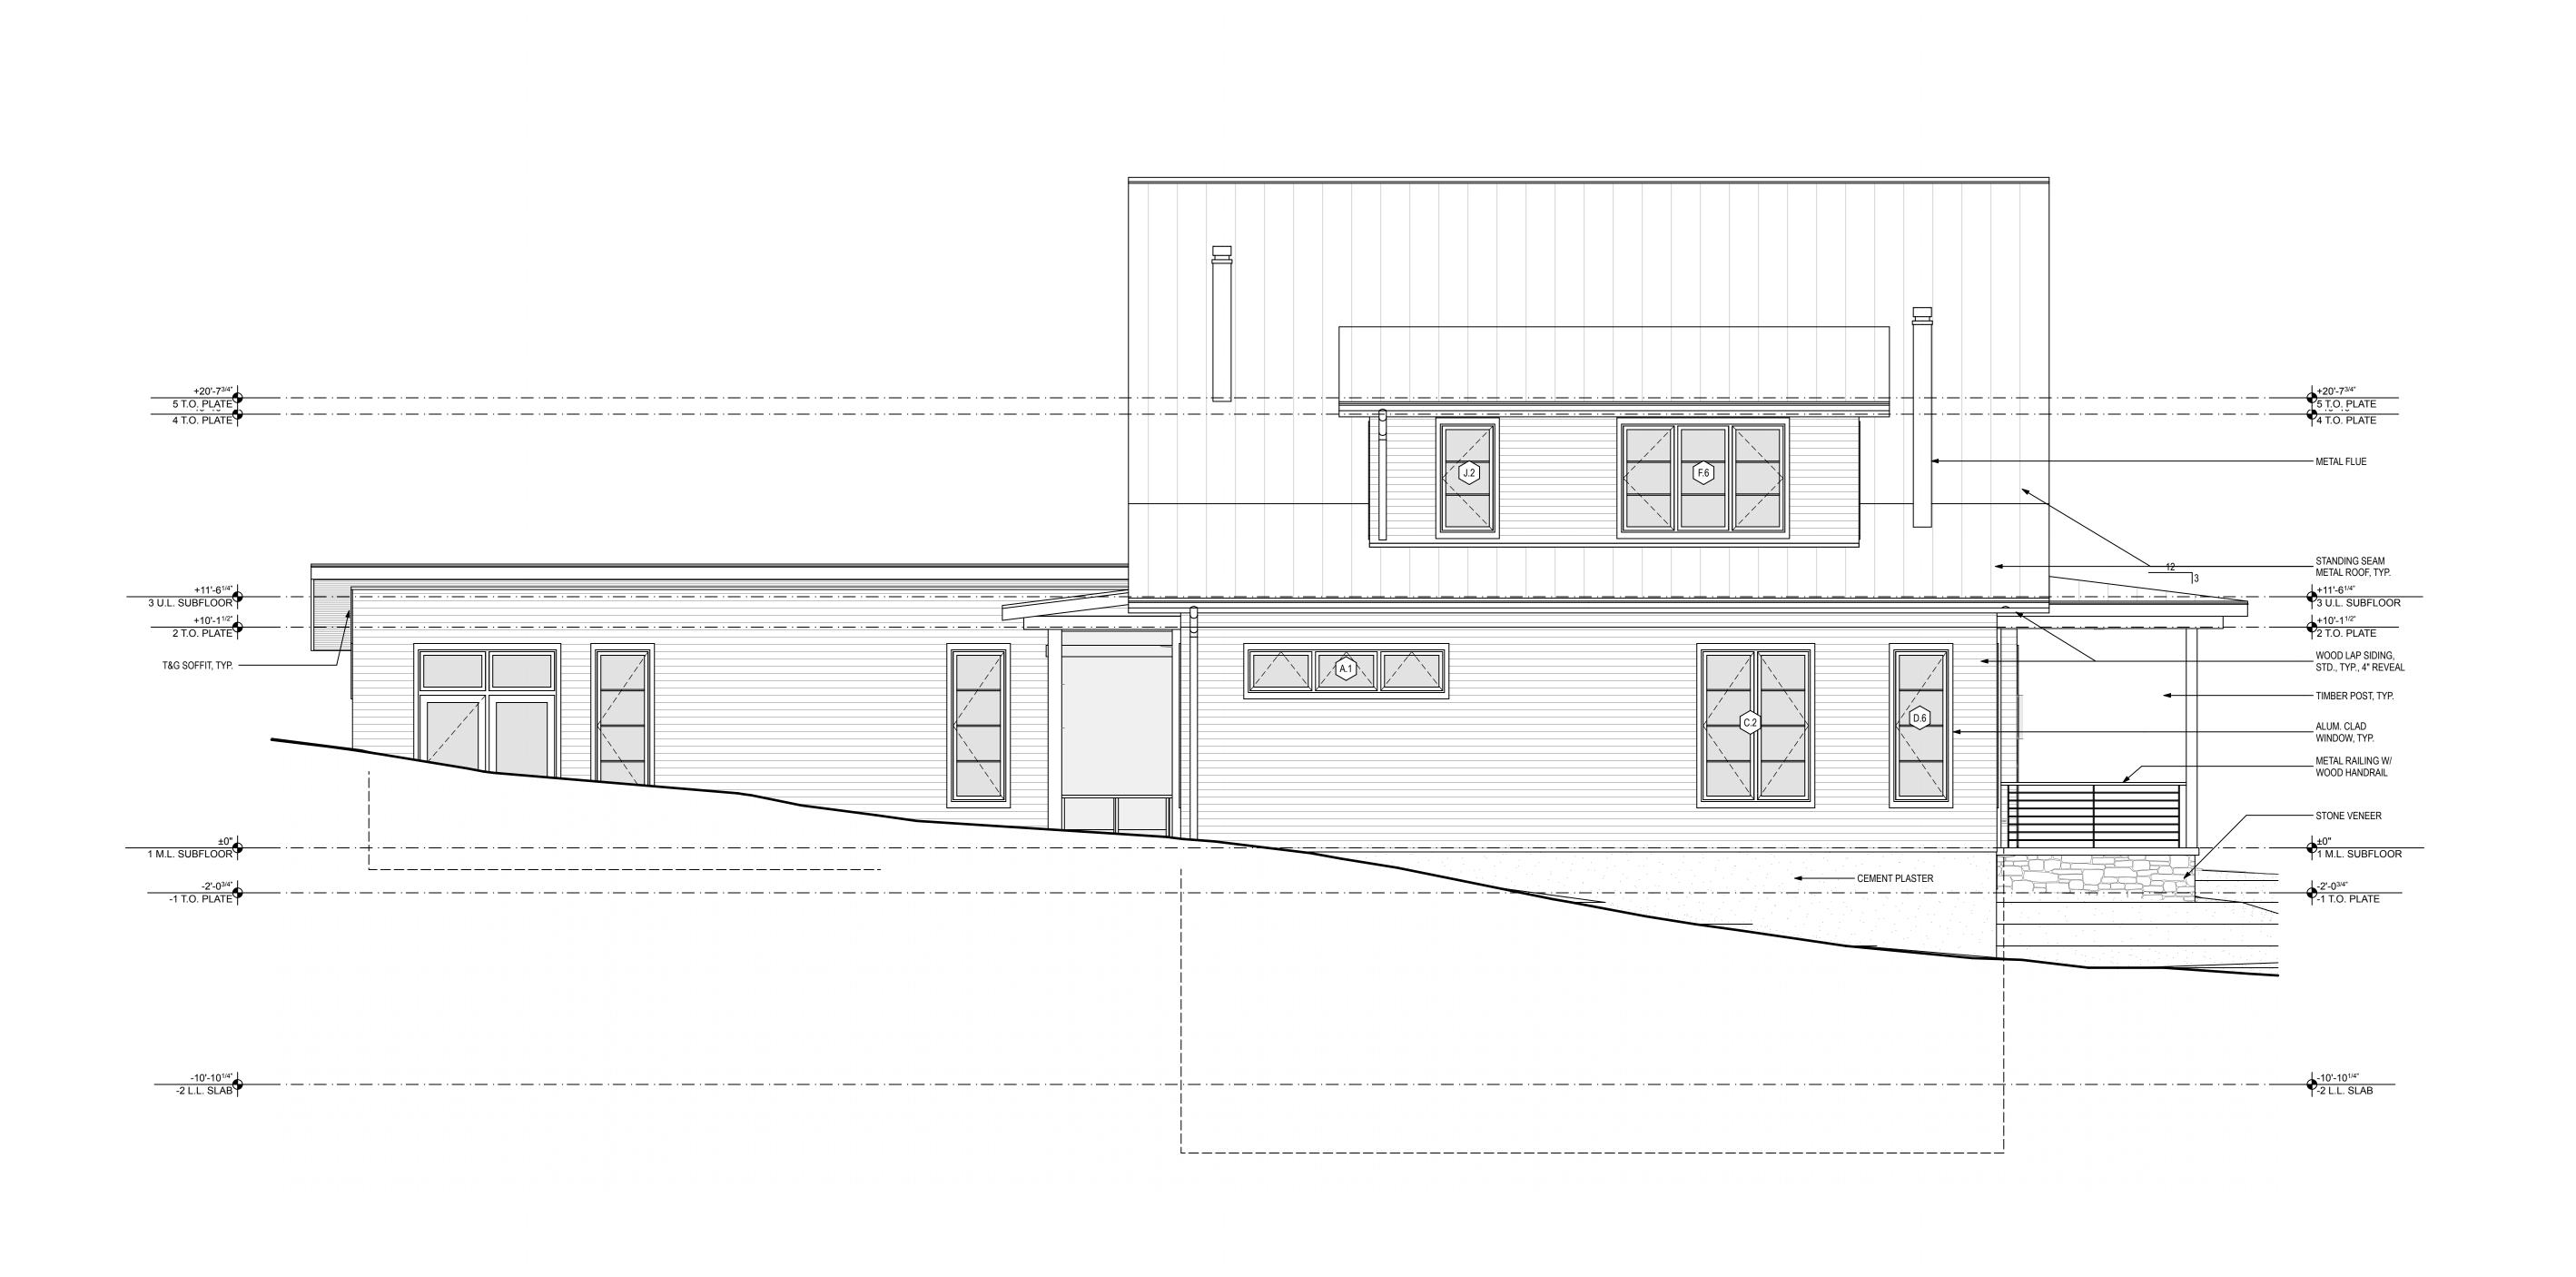
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SHEET #:

A-203



NORTHEAST ELEVATION

SCALE: 1/4" = 1'-0"

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EXTERIOR ELEVATIONS

	DATE:	DESCRIPTION:
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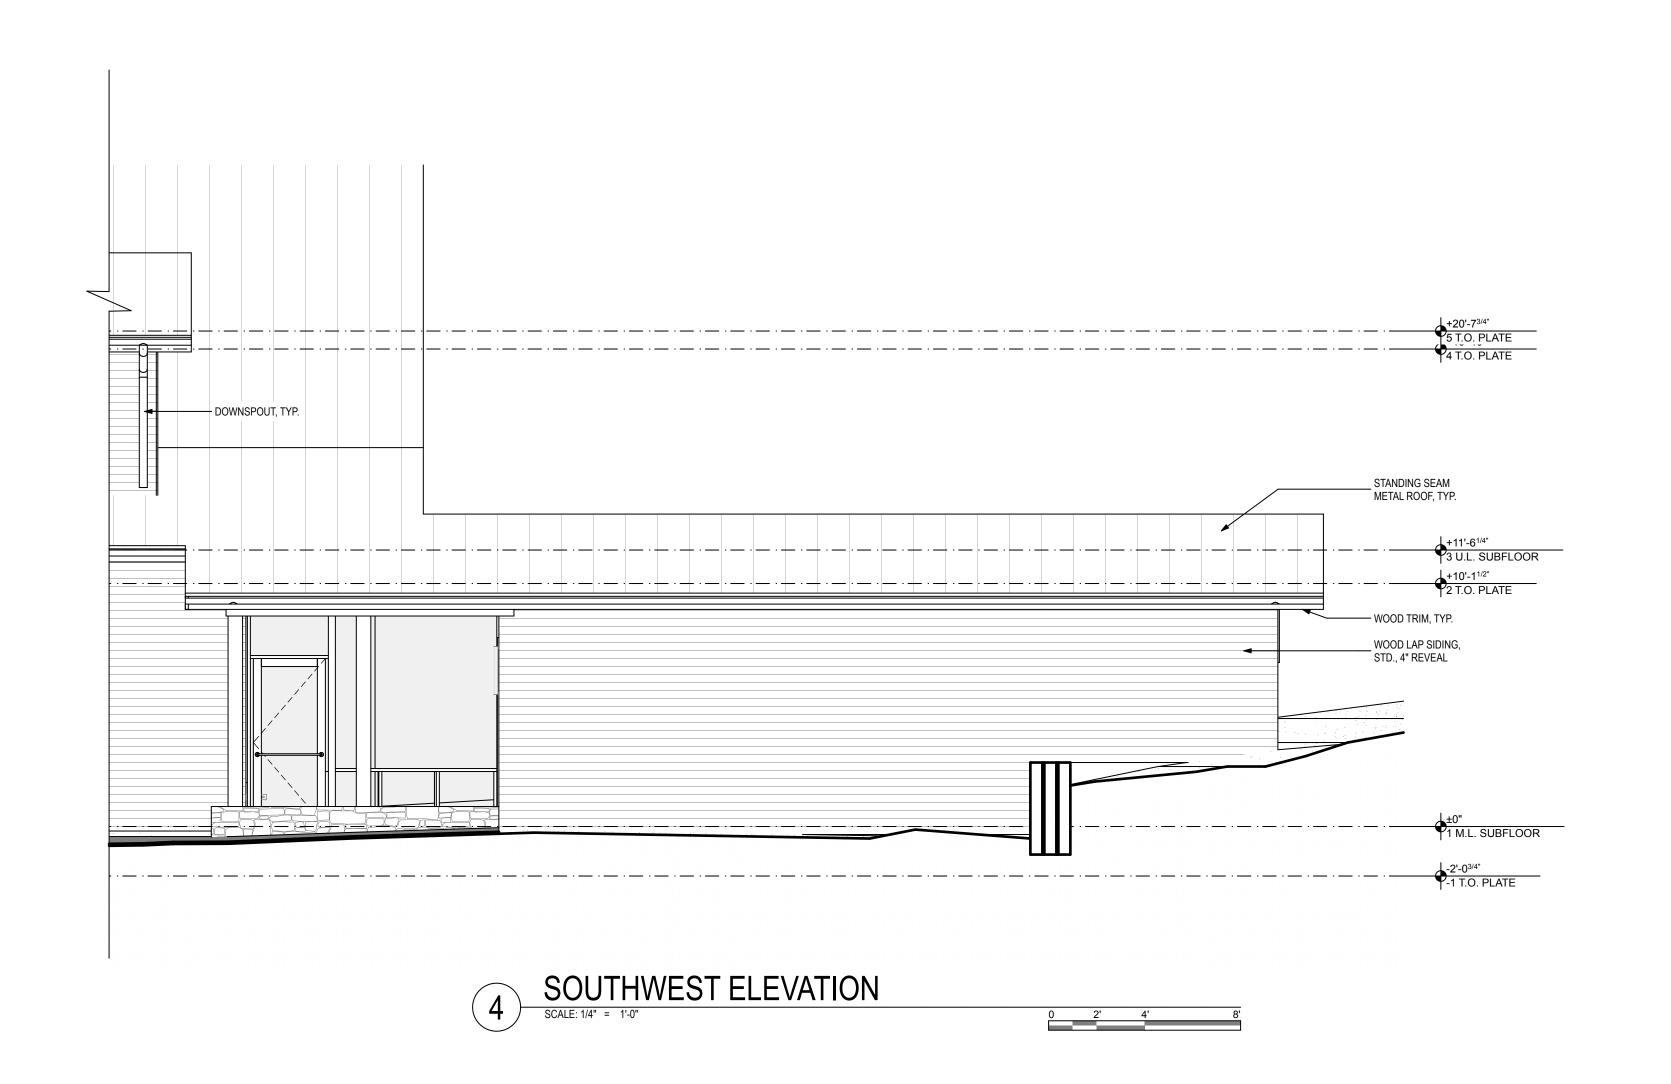
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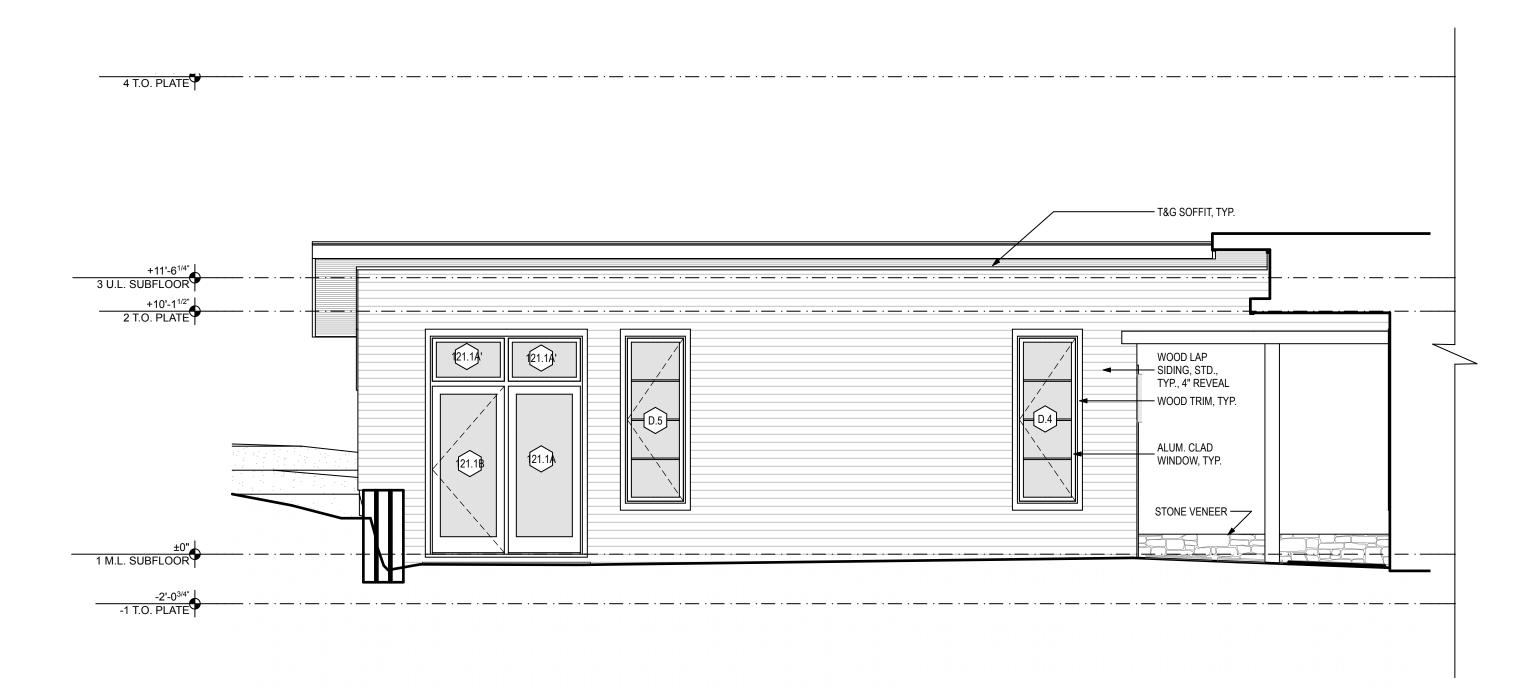
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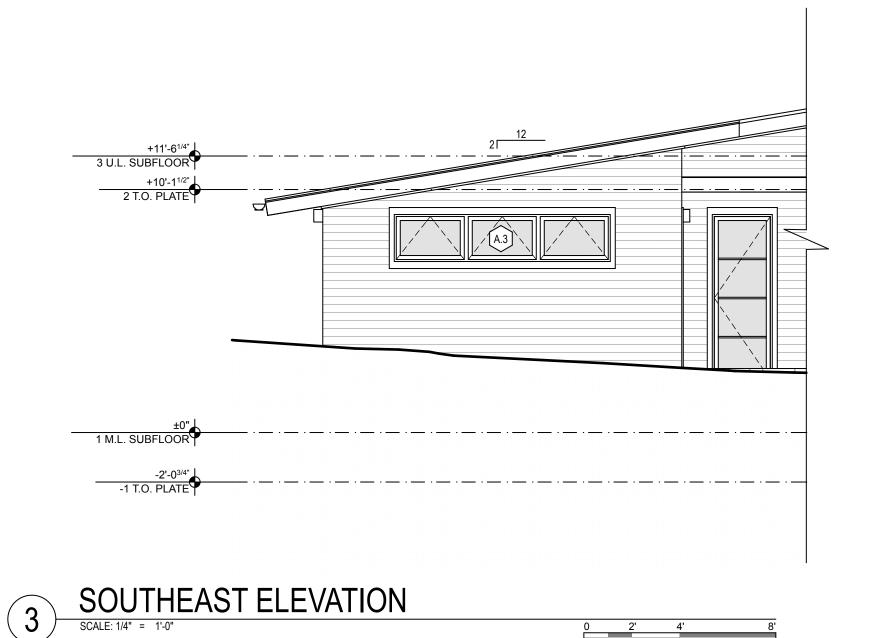
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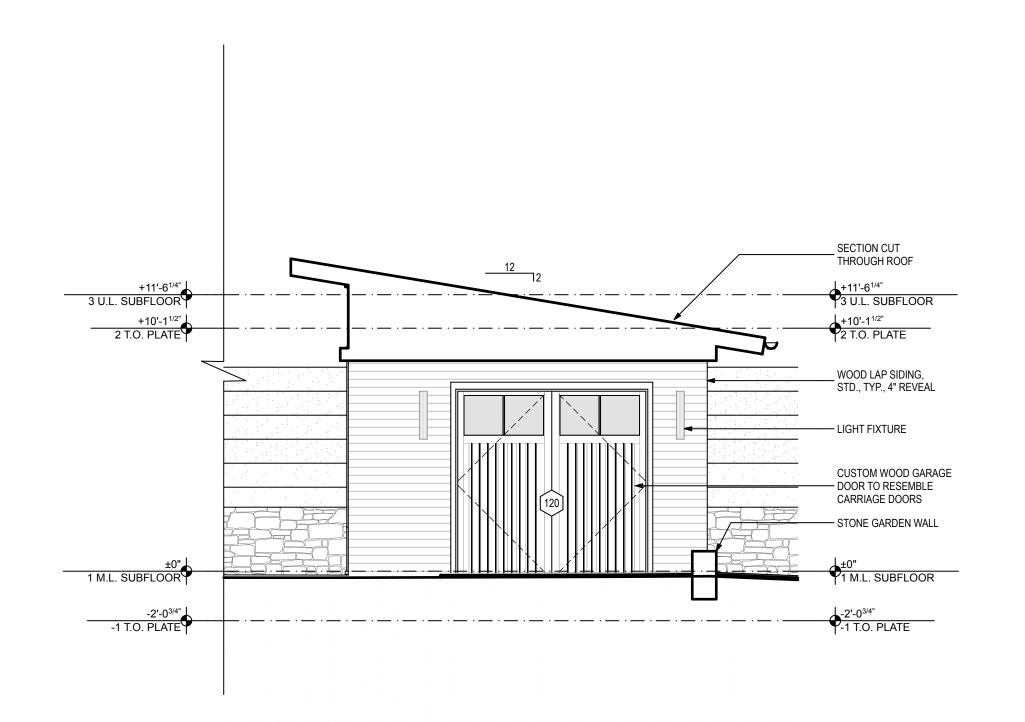




NORTHEAST ELEVATION

SCALE: 1/4" = 1'-0"





1 NORTHWEST ELEVATION

SCALE: 1/4" = 1'-0"

P.A.

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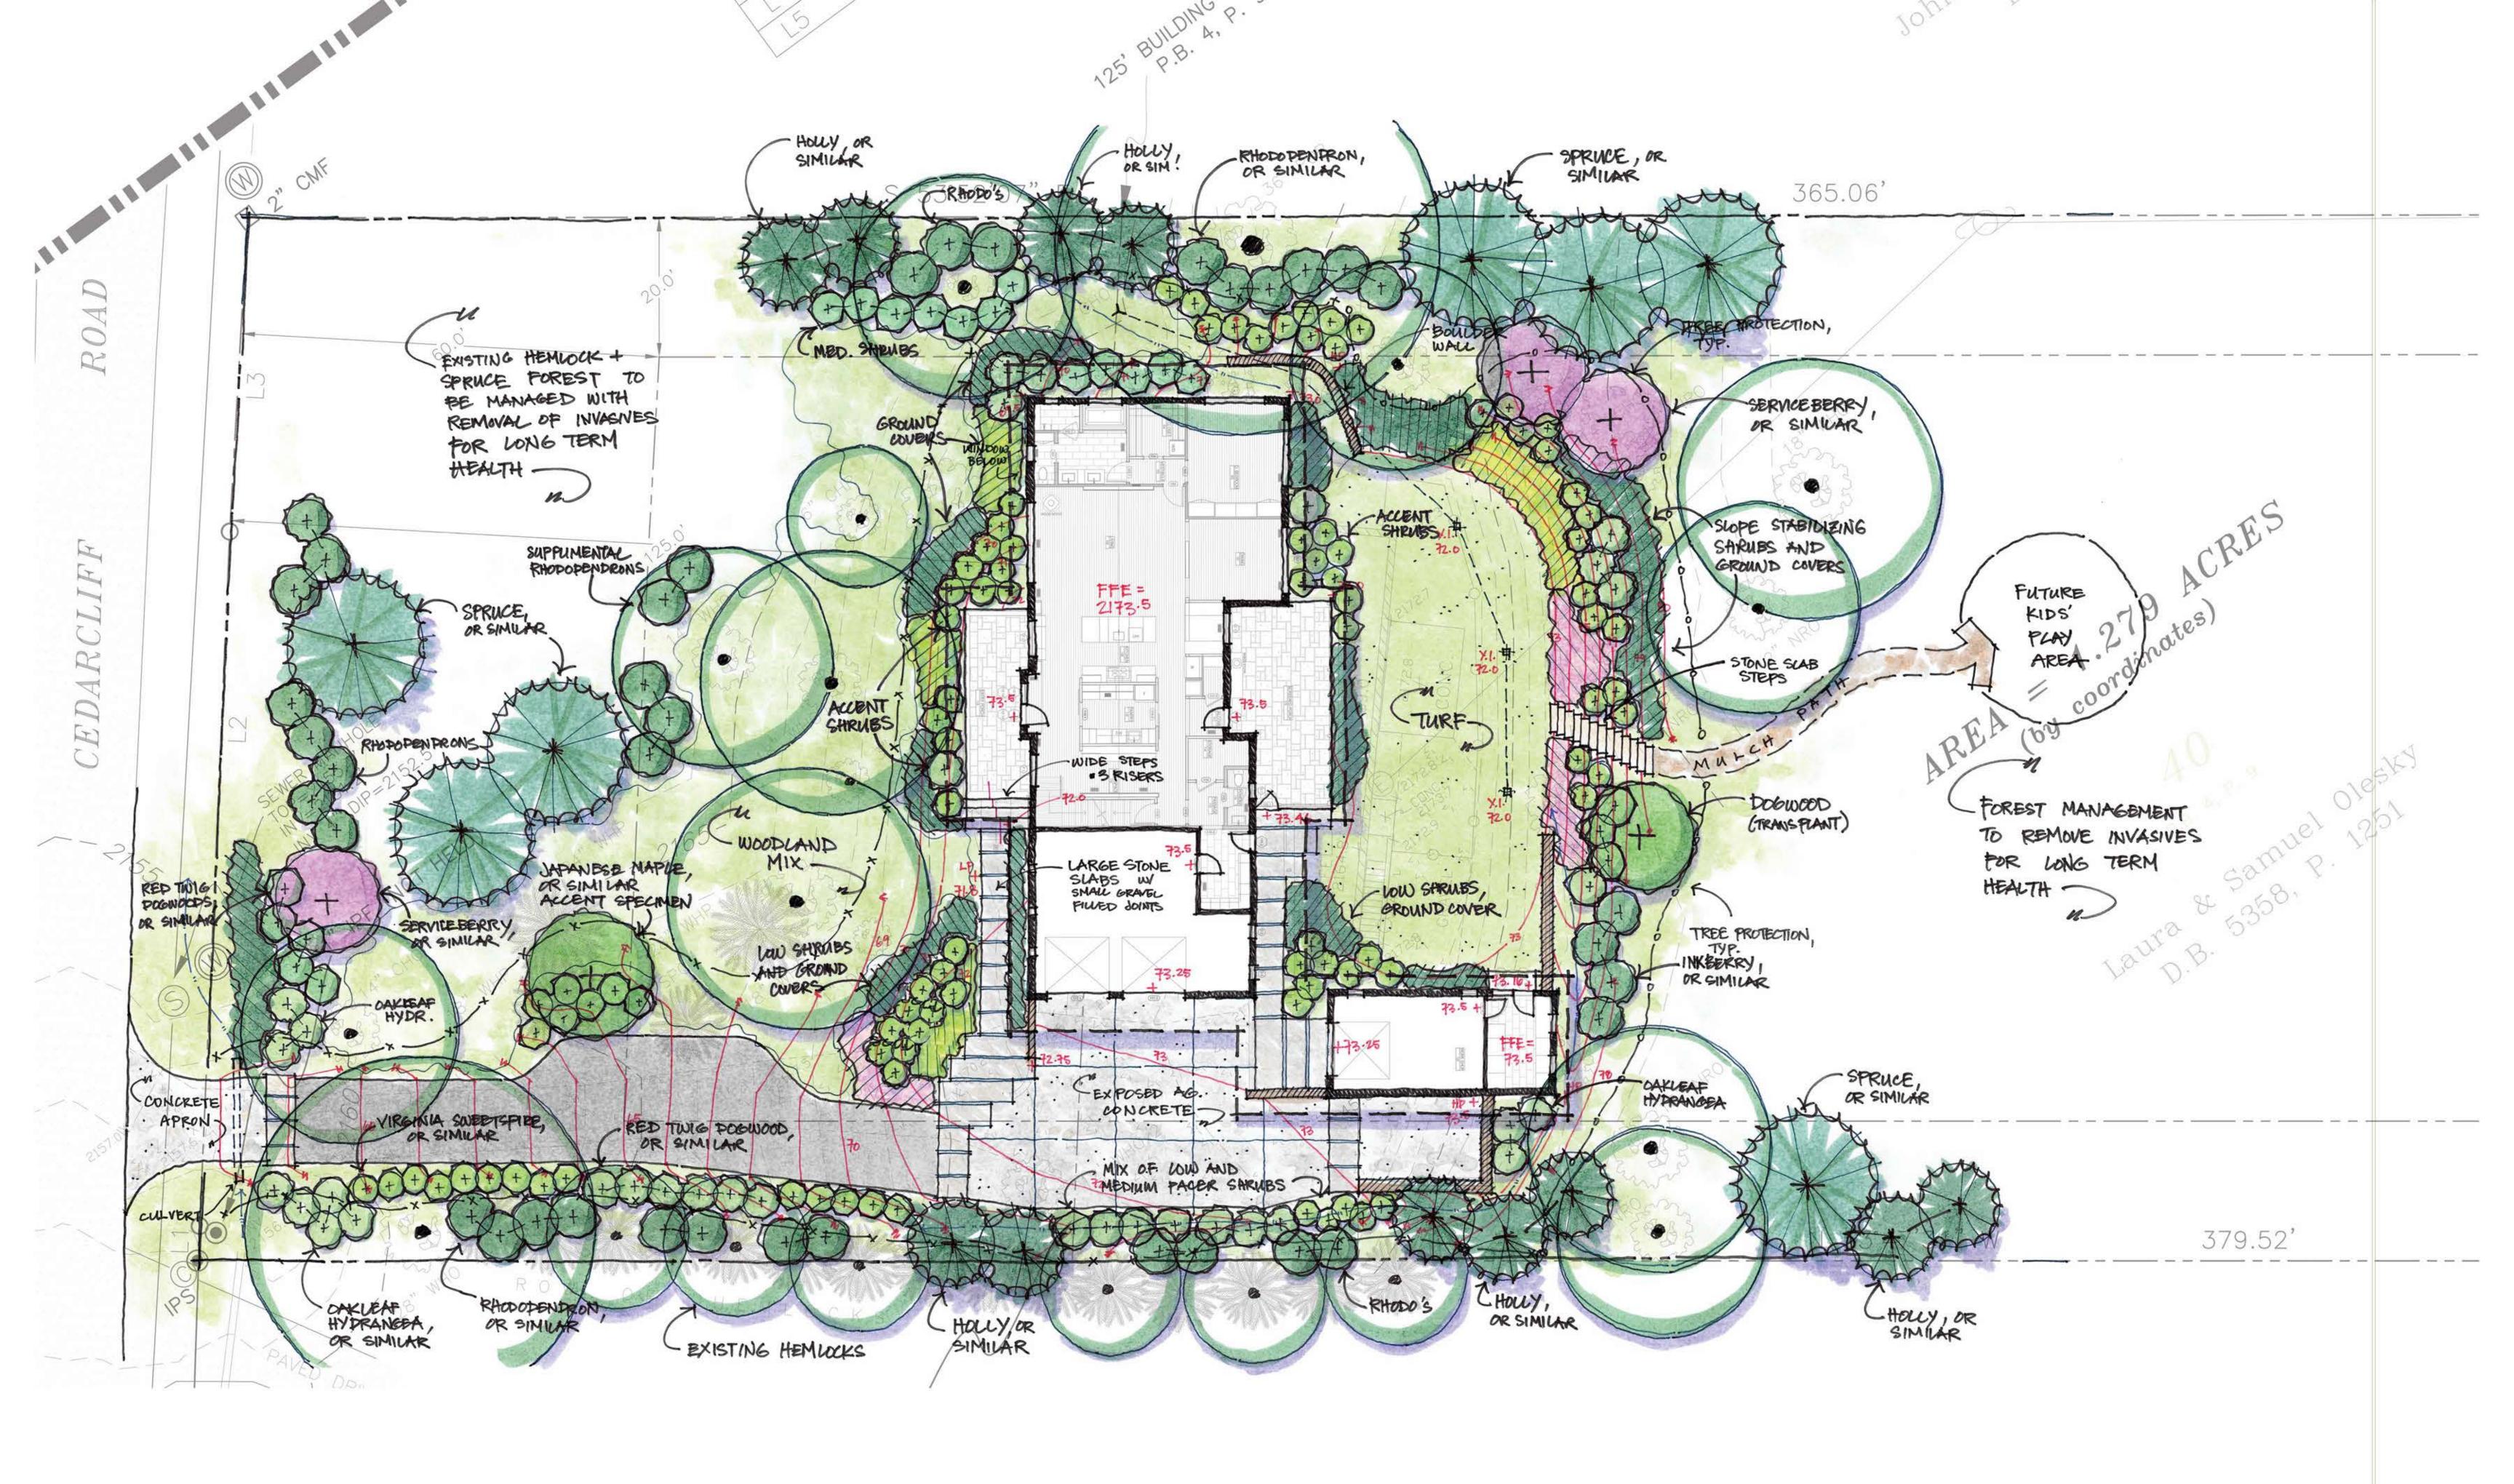
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OLESKY RESIDENCE

# LANDSCAPE PLAN

