

PROPOSED AGENDA

Thursday, September 23, 2021
5:30 p.m.

Meeting of the Design Review Board

- I. Chairman Johnson will call the meeting to order.
- II. Review and Approval of Minutes from July 29, 2021 and September 2, 2021.
- III. Design Review Board Presentations
 1. 51 Hilltop Road –Roof-mounted solar panel installation
 2. 3 Stuyvesant Crescent – Renovation to Existing Home
 3. 414 Vanderbilt Road – Construction of New Single-Family Residence

Projects 1 & 3 received special use permit approval from the Board of Adjustment at the Monday, September 20, 2021 meeting. Project 2 received approval for a variance to exceed the maximum roof coverage by approximately 4% at the September 20, 2021 meeting.

- IV. Next Meeting – Thursday, October 21, 2021
- V. Adjourn

MINUTES OF THE TOWN OF BILTMORE FOREST
DESIGN REVIEW BOARD MEETING OF JULY 29, 2021

Those in attendance:

Mr. Jonathan Kanipe, Town Manager
Mr. Bruce Johnson, Chairman
Ms. Gay Coleman
Mr. Tony Saponaro

The first matter discussed was regarding 31 Stuyvesant Road at the Biltmore Forest Country Club. Mr. Mike Beatty, architect, reviewed plans and elevations for the building. The new structures will have slate roofing and stucco which would blend in with the existing facility. The tennis court design was also described. The building changed a bit over time from when the fitness facility was first drawn. There will be an entrance created for ADA compliance in the basement area, which faces the golf course. There will be a new fitness facility, which moves to the upper level. It will be attractive from all sides of the building.

Ms. Gay Coleman asked about the slide going into the pool and it going into areas not as deep. Mr. Beatty said the slide specified is a slide for smaller children. The slide is very small with several turns and mostly elementary age and younger. Mr. Beatty said this is not a large slide.

Mr. Allen Peele who also represents the Country Club project said the elevation of the pool in that area is 3-4 feet and the slide is designed for smaller kids.

They are scheduled to start the project the day after Labor Day. Between the two structures, the total square footage is approximately 17,000. The main building is

approximately 8,000 square feet per level. The other building is much smaller with some pool equipment below.

Mr. Kip Warlick said they have told the members they will likely not have the pool open next year. They are hoping the tennis courts will be in place.

Mr. Tony Saponaro told Mr. Clay Mooney that he is very pleased with the project overall. Mr. Saponaro said there are 5-6 large trees coming out to remove the tennis court. Mr. Saponaro said he would like to see some larger trees planted back in this area. Mr. Mooney said there are some limitations with utilities and met requirements for the tree protection ordinance. Mr. Mooney said it is difficult to plant many large trees when one is trying not to disturb the area in question. There is a possibility the final landscaping plan may include some areas adjacent to Stuyvesant Road. Mr. Mooney said everything likes sunlight so he is not necessarily wanting to plant within the canopy and shade areas because the trees could not grow and thrive well in this area. Mr. Saponaro mentioned some specific varieties of large trees and replanting with a Japanese maple. Mr. Saponaro added this is a tree that will fill and grow in the space. He also said there is another large locust that is leaning over the tennis court and suggested that area to be a filler. Mr. Mooney said a water line was relocated and storm drain lines as well to avoid the impact of the trees.

Mr. Johnson asked when they submit the final landscape plan. Mr. Mooney and Mr. Kanipe said the landscaping plan approval was done by the Board of Adjustment this past Monday.

Mr. Saponaro questioned about the line going through #8. Mr. Michael Cain said there is a sewer service going through this area.

Ms. Coleman asked where the access road would be for the heavy equipment. Mr. Cain showed the board a gravel pattern going in from the circle in front of the club. It will go in through the current road and court #1. Mr. Allen said the upper tennis courts are

sacrificial so they can get into the wooded area from the backside rather than cutting an alley to get into the area. Most of the demo equipment will stay on the pool deck area.

Mr. Saponaro said they would drive in through the front entrance, go into the scoreboard stand and drive straight through there by #11. Ms. Coleman asked how this would affect golfing. Mr. Warlock said the cart path is seven feet and they have constructed an area to land everything. The plan is to put a fence with fabric on it. The turret will be an open air turret and is to get stairs up into the top for observation from swimming and tennis courts.

The project was approved by the Board.

The next project is 1095 Hendersonville Road driveway project cutting through the back. Mr. Mooney said this is a much better idea. The project was approved by the Board.

The final project is 23 Eastwood Road. There were questions regarding tree removal at 23 Eastwood Road. Mr. Saponaro understood that some trees need to come down. The change will be overall materially better for coverage and removing asphalt that is bad for the drainage. Overall, it is a good idea but his main concern is moving the driveway farther left and taking out four very large trees, including the three white oaks and a tulip poplar tree. Mr. Saponaro thinks with some flexibility, there may be an ability to keep them. From a construction standpoint, it would be much easier to remove.

There was discussion about the tree canopy and measurement for figuring out how far the roots go and keeping the trees in place.

The project was approved.

The meeting was adjourned at 6:10pm. The next Design Review Board meeting is scheduled for Thursday, September 2, 2021.

Bruce Johnson, Chairman

Laura Jacobs, Town Clerk

MINUTES OF THE TOWN OF BILTMORE FOREST
DESIGN REVIEW BOARD MEETING OF SEPTEMBER 2, 2021

Those in attendance:

Mr. Jonathan Kanipe, Town Manager
Mr. Bruce Johnson, Chairman
Ms. Gay Coleman
Mr. Tony Saponaro
Mr. Art Garst

Chairman Bruce Johnson called the meeting to order at 5:30pm on Thursday, September 2, 2021.

The first matter discussed was a driveway redesign request for a new residence at 15 Eastwood Road. Mr. Matt Zink discussed the project. The existing driveway will be used as a construction entrance. The approximate time for construction will take four months. The driveway is within the setbacks. The plantings in the front entrance will be replaced with new shrubbery.

The project at 15 Eastwood was approved.

The next matter discussed was at 5 White Oak Road for a circular drive addition. The driveway will be made from concrete and gravel. There will be brick pavers for edging. There are also some screening bushes proposed. The aesthetics of the house will be greatly improved. Mr. Johnson asked if there would be mud mats installed which is required per Town Ordinance. This information will be passed on to the contractor.

The project was approved.

The next project discussed was 377 Vanderbilt Road for a carport shed on an existing detached garage. This house is on a half-acre lot. The detached garage was built in 1928 and is very inconvenient. A shed roof carport would be added to the side of it. The same materials will be used which was on the entryway. The garage would be used for inside parking. There is no change to the current structure other than the door.

The project was approved.

The next project was 32 Hilltop Road for roof-mounted solar panel installation for a new residence. The solar panels would be on the rear of the house and not visible from the road. It would be a black on black panel.

The project was approved.

The next project discussed was for 6 Stuyvesant Road, which was a request for a rear yard deer fence installation. There will be brown posts and it will stand eight foot tall. It will be 2x3 square and galvanized. They got a Variance from the Board of Adjustment because they have heavy landscaping and got approval regarding the setbacks.

The project was approved.

The next project was at 8 White Oak Road for a circular drive addition and an addition of a second level sunroom and small deck over an existing covered porch. They are under their allowance for pervious and impervious surface coverage. They will be using water permeable pavers. The driveway was already approved by the Board of Adjustment. Ten trees will be removed but plantings will be replaced. The driveway will be asphalt. The existing masonry garden wall will be replaced.

The project was approved.

The next project discussed was 15 White Oak Road, which was a request for a 16x12 shed roof over an existing stone patio. It will be located on the side of the home.

The project was approved.

The last project discussed was for 14 Southwood Road, which requested an addition to the living room and the kitchen.

The project was approved.

Chairman Johnson adjourned the meeting at 6:14 pm. The next Design Review Board meeting is scheduled for Thursday, September 23, 2021.

Bruce Johnson, Chairman

Laura Jacobs, Town Clerk

Zoning Compliance Application

Town of Biltmore Forest

Name

Stephen Miller

Property Address

51 Hilltop Road Biltmore Forest NC 28803

Phone

(828) 712-0672

Email

smiller@gen-span.com

Parcel ID/PIN Number

964664329700000

ZONING INFORMATION

Current Zoning

R-1

Lot Size

1.68 acres

Maximum Roof Coverage

2,874 square feet (Up to .5 acres)

Proposed Roof Coverage Total

0

Maximum Impervious Surface Coverage

Up to 1 acre (27.5 percent of lot area)

Proposed Impervious Surface Coverage

0

Front Yard Setback

60 feet (R-1 District)

Side Yard Setback

20 feet (R-1 District)

Rear Yard Setback

25 feet (R-1 District)

Building Height

0

Description of the Proposed Project

Rooftop Solar Installation 11.84kW(32 panels)

Estimated Start Date

10/1/2021

Estimated Completion Date

10/31/2021

Estimated Cost of Project

\$23,680.00

Supporting Documentation (Site Plan, Drawings, Other Information)

TSP93362 Eng Letter.pdf

TSP93362 Plans.pdf

Special Use Permit Application

Town of Biltmore Forest

Name

Stephen Miller

Address

51 Hilltop Road Biltmore Forest NC 28803

Phone

(828) 712-0672

Email

smiller@gen-span.com

Please select the type of special use you are applying for:

Accessory Structures

The applicant must show that the proposed use will not materially endanger public health or safety or injure value of adjoining or abutting property. In addition, the proposed use must be in general conformity with the plan of development of the town and be in harmony with scale, bulk, height, coverage, density, and character of the neighborhood.

Please provide a description of the proposed project:

Rooftop Solar Installation 11.84kW(32 panels)

Explain why the project would not adversely affect the public interest of those living in the neighborhood:

Proposed project is solar panels on roof of home.

I hereby certify that all of the information set forth above is true and accurate to the best of my knowledge.

Signature



Date

8/26/2021

SCOPE OF WORK:

TO INSTALL A ROOF MOUNTED SOLAR PHOTOVOLTAIC SYSTEM AT THE OWNER RESIDENCE LOCATED AT 51 HILLTOP ROAD BILTMORE FOREST, NC 28803. THE POWER GENERATED BY THE PV SYSTEM WILL BE INTERCONNECTED WITH THE UTILITY GRID THROUGH THE EXISTING ELECTRICAL SERVICE EQUIPMENT. THE PV SYSTEM DOES NOT INCLUDE STORAGE BATTERIES

EQUIPMENT SUMMARY

32 LG ELECTRONICS LG370Q1C-V5 MODULES
01 SOLAREEDGE SE10000H-US INVERTER
32 SOLAREEDGE POWER OPTIMIZER P370

GENERAL NOTES:

- THESE CONSTRUCTION DOCUMENTS HAVE BEEN BASED ON FIELD INSPECTIONS AND OTHER INFORMATION AVAILABLE AT THE TIME. ACTUAL FIELD CONDITIONS MAY REQUIRE MODIFICATIONS IN CONSTRUCTION DETAILS.
- ARCHITECT HAS NOT BEEN RETAINED TO SUPERVISE ANY CONSTRUCTION OR INSTALLATION OF ANY EQUIPMENT AT SITE.
- CONTRACTOR SHALL FURNISH ALL LABOR, MATERIAL, EQUIPMENT, TOOLS, OBTAINS ALL PERMITS, LICENSES AND PAY ALL REQUIRED FEES AND COMPLETE INSTALLATION.
- CONTRACTOR HAS THE FULL RESPONSIBILITY TO CHECK AND VERIFY ALL DIMENSIONS AND EXISTING CONDITIONS. ANY DISCREPANCIES SHALL BE REPORTED TO THE ENGINEER BEFORE PROCEEDING WITH THE WORK. ANY WORK STARTED BEFORE CONSULTATION AND ACCEPTANCE BY THE ENGINEER SHALL BE THE SOLE RESPONSIBILITY OF THE CONTRACTOR AND SHALL BE SUBJECT TO CORRECTION BY THEM WITHOUT ADDITIONAL COMPENSATION.
- DAMAGE CAUSED TO THE EXISTING STRUCTURE, PIPES, DUCTS, WINDOWS, WALL, FLOORS, ETC. SHALL BE REPAIRED TO THE ORIGINAL CONDITION OR REPLACED BY THE CONTRACTOR AT NO ADDITIONAL COST.
- THE CONTRACTOR SHALL BE HELD RESPONSIBLE FOR THE PROPER INSTALLATION AND COMPLETION OF THE WORK WITH APPROVED MATERIALS.
- NO CHANGES ARE TO BE MADE WITHOUT THE CONSULTATION AND APPROVAL OF THE ARCHITECT.
- CONTRACTOR SHALL OBTAIN BUILDING PERMIT. NO WORK TO START UNLESS BUILDING PERMIT IS PROPERLY DISPLAYED.
- ALL WORKMANSHIP AND MATERIALS SHALL BE OF FIRST QUALITY AND IN COMPLIANCE WITH THE REQUIREMENTS OF THE NC BUILDING CODE, THE DEPARTMENT OF ENVIRONMENTAL PROTECTION AND ALL PERTINENT AGENCIES.
- IT IS ESSENTIAL THAT ALL WORK PROCEED WITH THE MAXIMUM COOPERATION OF ALL PARTIES AND WITH MINIMUM INTERFERENCE TO THE OCCUPANTS WITHIN THE BUILDING. THE OWNER'S DIRECTIONS IN THIS REGARD SHALL BE FULLY COMPLIED WITH.
- ALL EXPOSED PLUMBING, HVAC, ELECTRICAL DUCTWORK, PIPING AND CONDUITS ARE TO BE PAINTED BY GENERAL CONTRACTOR.
- THE CONTRACTOR SHALL PERFORM THE WORK IN STRICT CONFORMANCE WITH THE LOCAL LAWS, REGULATIONS AND THE NATIONAL ELECTRIC CODE.
- THE CONTRACTOR SHALL OBTAIN ALL PERMITS, APPROVALS, AFFIDAVITS, CERTIFICATIONS, ETC. AND PAY ALL FEES AS REQUIRED BY THE LOCAL AUTHORITIES.
- CONTRACTORS SHALL OBTAIN FIRE CERTIF. UPON COMPLETION OF WORK.

ELECTRICAL NOTES:

- THE EQUIPMENT AND ALL ASSOCIATED WIRING AND INTERCONNECTION SHALL BE INSTALLED ONLY BY QUALIFIED PEOPLE. A QUALIFIED PERSON IS ONE WHO HAS SKILLS AND KNOWLEDGE RELATED TO THE CONSTRUCTION AND OPERATION OF THE ELECTRICAL EQUIPMENT AND INSTALLATIONS AND HAS RECEIVED SAFETY TRAINING TO RECOGNIZE AND AVOID THE HAZARDS INVOLVED. (NEC 690.4(E) AND 705.6)
- LOCAL UTILITY PROVIDER SHALL BE NOTIFIED PRIOR TO USE AND ACTIVATION OF ANY SOLAR PHOTOVOLTAIC INSTALLATION. FOR A LINE SIDE TAP CONNECTION, UTILITY NEEDS TO BE NOTIFIED WELL IN ADVANCE TO COORDINATE BUILDING ELECTRICAL SHUT OFF.
- NEW CONDUIT ROUTING SHOWN IS ESSENTIALLY SCHEMATIC. SUBCONTRACTOR SHALL LAY OUT RUNS TO SUIT FIELD CONDITIONS AND THE COORDINATION REQUIREMENTS OF OTHER TRADES.
- ARRAY WIRING SHOULD NOT BE READILY ACCESSIBLE EXCEPT TO QUALIFIED PERSONNEL.
- ALL EXTERIOR CONDUIT, FITTINGS, AND BOXES SHALL BE WATERTIGHT AND APPROVED FOR USE IN WET LOCATIONS. (NEC 314.15A).
- WIRING METHODS FOR PV SYSTEM CONDUCTORS AREN'T PERMITTED WITHIN 10 IN. OF THE ROOF DECKING OR SHEATHING EXCEPT WHERE LOCATED DIRECTLY BELOW THE ROOF SURFACE THAT'S COVERED BY PV MODULES AND ASSOCIATED EQUIPMENT WIRING
- BACK-FED BREAKER MUST BE AT THE OPPOSITE END OF BUS BAR FROM THE MAIN BREAKER OR MAIN LUG SUPPLYING CURRENT FROM THE UTILITIES.
- ALL CONDUCTORS AND WIRE TIES EXPOSED TO SUNLIGHT ARE LISTED AS UV RESISTANT.
- CONTRACTOR SHALL FOLLOW ALL ELECTRICAL EQUIPMENT LABELING REQUIREMENTS IN NEC 690 AND IFC 2015
- MEASURE THE LINE-TO-LINE AND LINE-TO-NEUTRAL VOLTAGE OF ALL SERVICE ENTRANCE CONDUCTORS PRIOR TO INSTALLING ANY SOLAR EQUIPMENT. THE VOLTAGES FOR THE 240VAC RATED.

GOVERNING CODES

2017 NATIONAL ELECTRICAL CODE
2018 INTERNATIONAL FIRE CODE
2018 INTERNATIONAL BUILDING CODE
2018 INTERNATIONAL RESIDENTIAL CODE
2018 INTERNATIONAL ENERGY CONSERVATION CODE
2018 INTERNATIONAL EXISTING BUILDING CODE
2018 INTERNATIONAL SWIMMING POOL AND SPA CODE
2018 UNIFORM MECHANICAL CODE
2018 UNIFORM PLUMBING CODE

AUTHORITY HAVING JURISDICTION (AHJ): BILTMORE FOREST TOWN

WIRING AND CONDUIT NOTES:

- ALL CONDUIT SIZES AND TYPES, SHALL BE LISTED FOR ITS PURPOSE AND APPROVED FOR THE SITE APPLICATIONS
- ALL PV CABLES AND HOMERUN WIRES BE #10AWG *USE-2, PV WIRE, OR PROPRIETARY SOLAR CABLING SPECIFIED BY MFR, OR EQUIVALENT; ROUTED TO SOURCE CIRCUIT COMBINER BOXES AS REQUIRED
- ALL CONDUCTORS AND OCPD SIZES AND TYPES SPECIFIED ACCORDING TO [NEC 690.8 (A)(1) & (B)(1)], [NEC 240] [NEC 690.7] FOR MULTIPLE CONDUCTORS
- ALL PV DC CONDUCTORS IN CONDUIT EXPOSED TO SUNLIGHT SHALL BE DERATED ACCORDING TO [NEC TABLE 310.15 (B)(2)(C)] BLACK ONLY**
- EXPOSED ROOF PV DC CONDUCTORS SHALL BE USE-2, 90°C RATED, WET AND UV RESISTANT, AND UL LISTED RATED FOR 600V, UV RATED SPIRAL WRAP SHALL BE USED TO PROTECT WIRE FROM SHARP EDGES
- PHASE AND NEUTRAL CONDUCTORS SHALL BE DUAL RATED THHN/THWN-2 INSULATED, 90°C RATED, WET AND UV RESISTANT, RATED FOR 600V PER NEC 2008 OR 1000V PER NEC 2011
- 4-WIRE DELTA CONNECTED SYSTEMS HAVE THE PHASE WITH THE HIGHER VOLTAGE TO GROUND MARKED ORANGE OR IDENTIFIED BY OTHER EFFECTIVE MEANS
- ALL SOURCE CIRCUITS SHALL HAVE INDIVIDUAL SOURCE CIRCUIT PROTECTION
- VOLTAGE DROP LIMITED TO 2% FOR DC CIRCUITS AND 1% FOR AC CIRCUITS
- NEGATIVE GROUNDED SYSTEMS DC CONDUCTORS SHALL BE COLOR CODED AS FOLLOWS: DC POSITIVE - RED (OR MARKED RED), DC NEGATIVE - GREY (OR MARKED GREY)
- POSITIVE GROUNDED SYSTEMS DC CONDUCTORS COLOR CODED: DC POSITIVE - GREY (OR MARKED GREY), DC NEGATIVE - BLACK (OR MARKED BLACK)
- AC CONDUCTORS >4AWG COLOR CODED OR MARKED: PHASE A OR L1- BLACK, PHASE B OR L2- RED, PHASE C OR L3- BLUE, NEUTRAL- WHITE/GRAY

SYSTEM RATING

11.84 KWDC


10.0 KWAC

SHEET INDEX

PV-0	COVER PAGE
PV-1	SITE PLAN
PV-2	ROOF PLAN & MODULES
PV-2A	STRING LAYOUT & BOM
PV-3	ATTACHMENT DETAIL
PV-3A	ATTACHMENT DETAIL
PV-4	ELECTRICAL LINE DIAGRAM & CALCS.
PV-4A	ELECTRICAL LINE DIAGRAM & CALCS.
PV-4B	SPECIFICATIONS & NOTES
PV-5	SIGNAGE
PV-6	JOB SAFETY PLAN
PV-7+	EQUIPMENT SPECIFICATIONS

PROJECT SITE

1 PV-0 HOUSE PHOTO SCALE: NTS

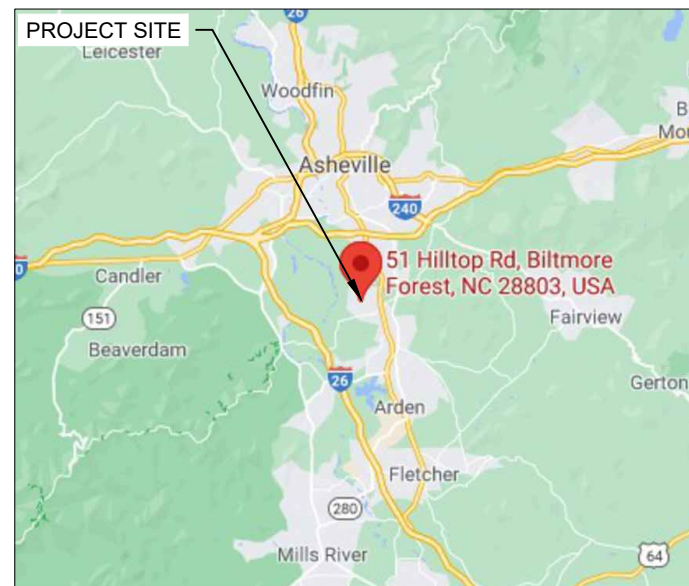

2 PV-0 VICINITY MAP SCALE: NTS



TITAN SOLAR POWER

210 N Sunway Dr,
Gilbert, AZ 85233

www.titansolarpower.com

ELECTRICAL LIC#: U.33714

REVISIONS

DESCRIPTION	DATE	REV
REVISION	08/24/2021	A

Signature with Seal

DATE: 08/24/2021

PROJECT NAME & ADDRESS

STEPHEN MILLER
RESIDENCE
51 HILLTOP ROAD
BILTMORE FOREST, NC 28803
PH NO. 828 712 0672
EMAIL ID: smiller@genspan.

SHEET NAME

COVER PAGE

SHEET SIZE


ANSI B
11" X 17"

SHEET NUMBER

PV-0

SITE NOTES

- A LADDER SHALL BE IN PLACE FOR INSPECTION IN COMPLIANCE WITH OSHA REGULATIONS.
- THE PV MODULES ARE CONSIDERED NON-COMBUSTIBLE AND THIS SYSTEM IS AN UTILITY INTERACTIVE SYSTEM WITH NO STORAGE BATTERIES.
- THE SOLAR PV INSTALLATION SHALL NOT OBSTRUCT ANY PLUMBING, MECHANICAL, OR BUILDING ROOF VENTS.
- PROPER ACCESS AND WORKING CLEARANCE AROUND EXISTING AND PROPOSED ELECTRICAL EQUIPMENT WILL BE PROVIDED AS PER SECTION [NEC 110.26]

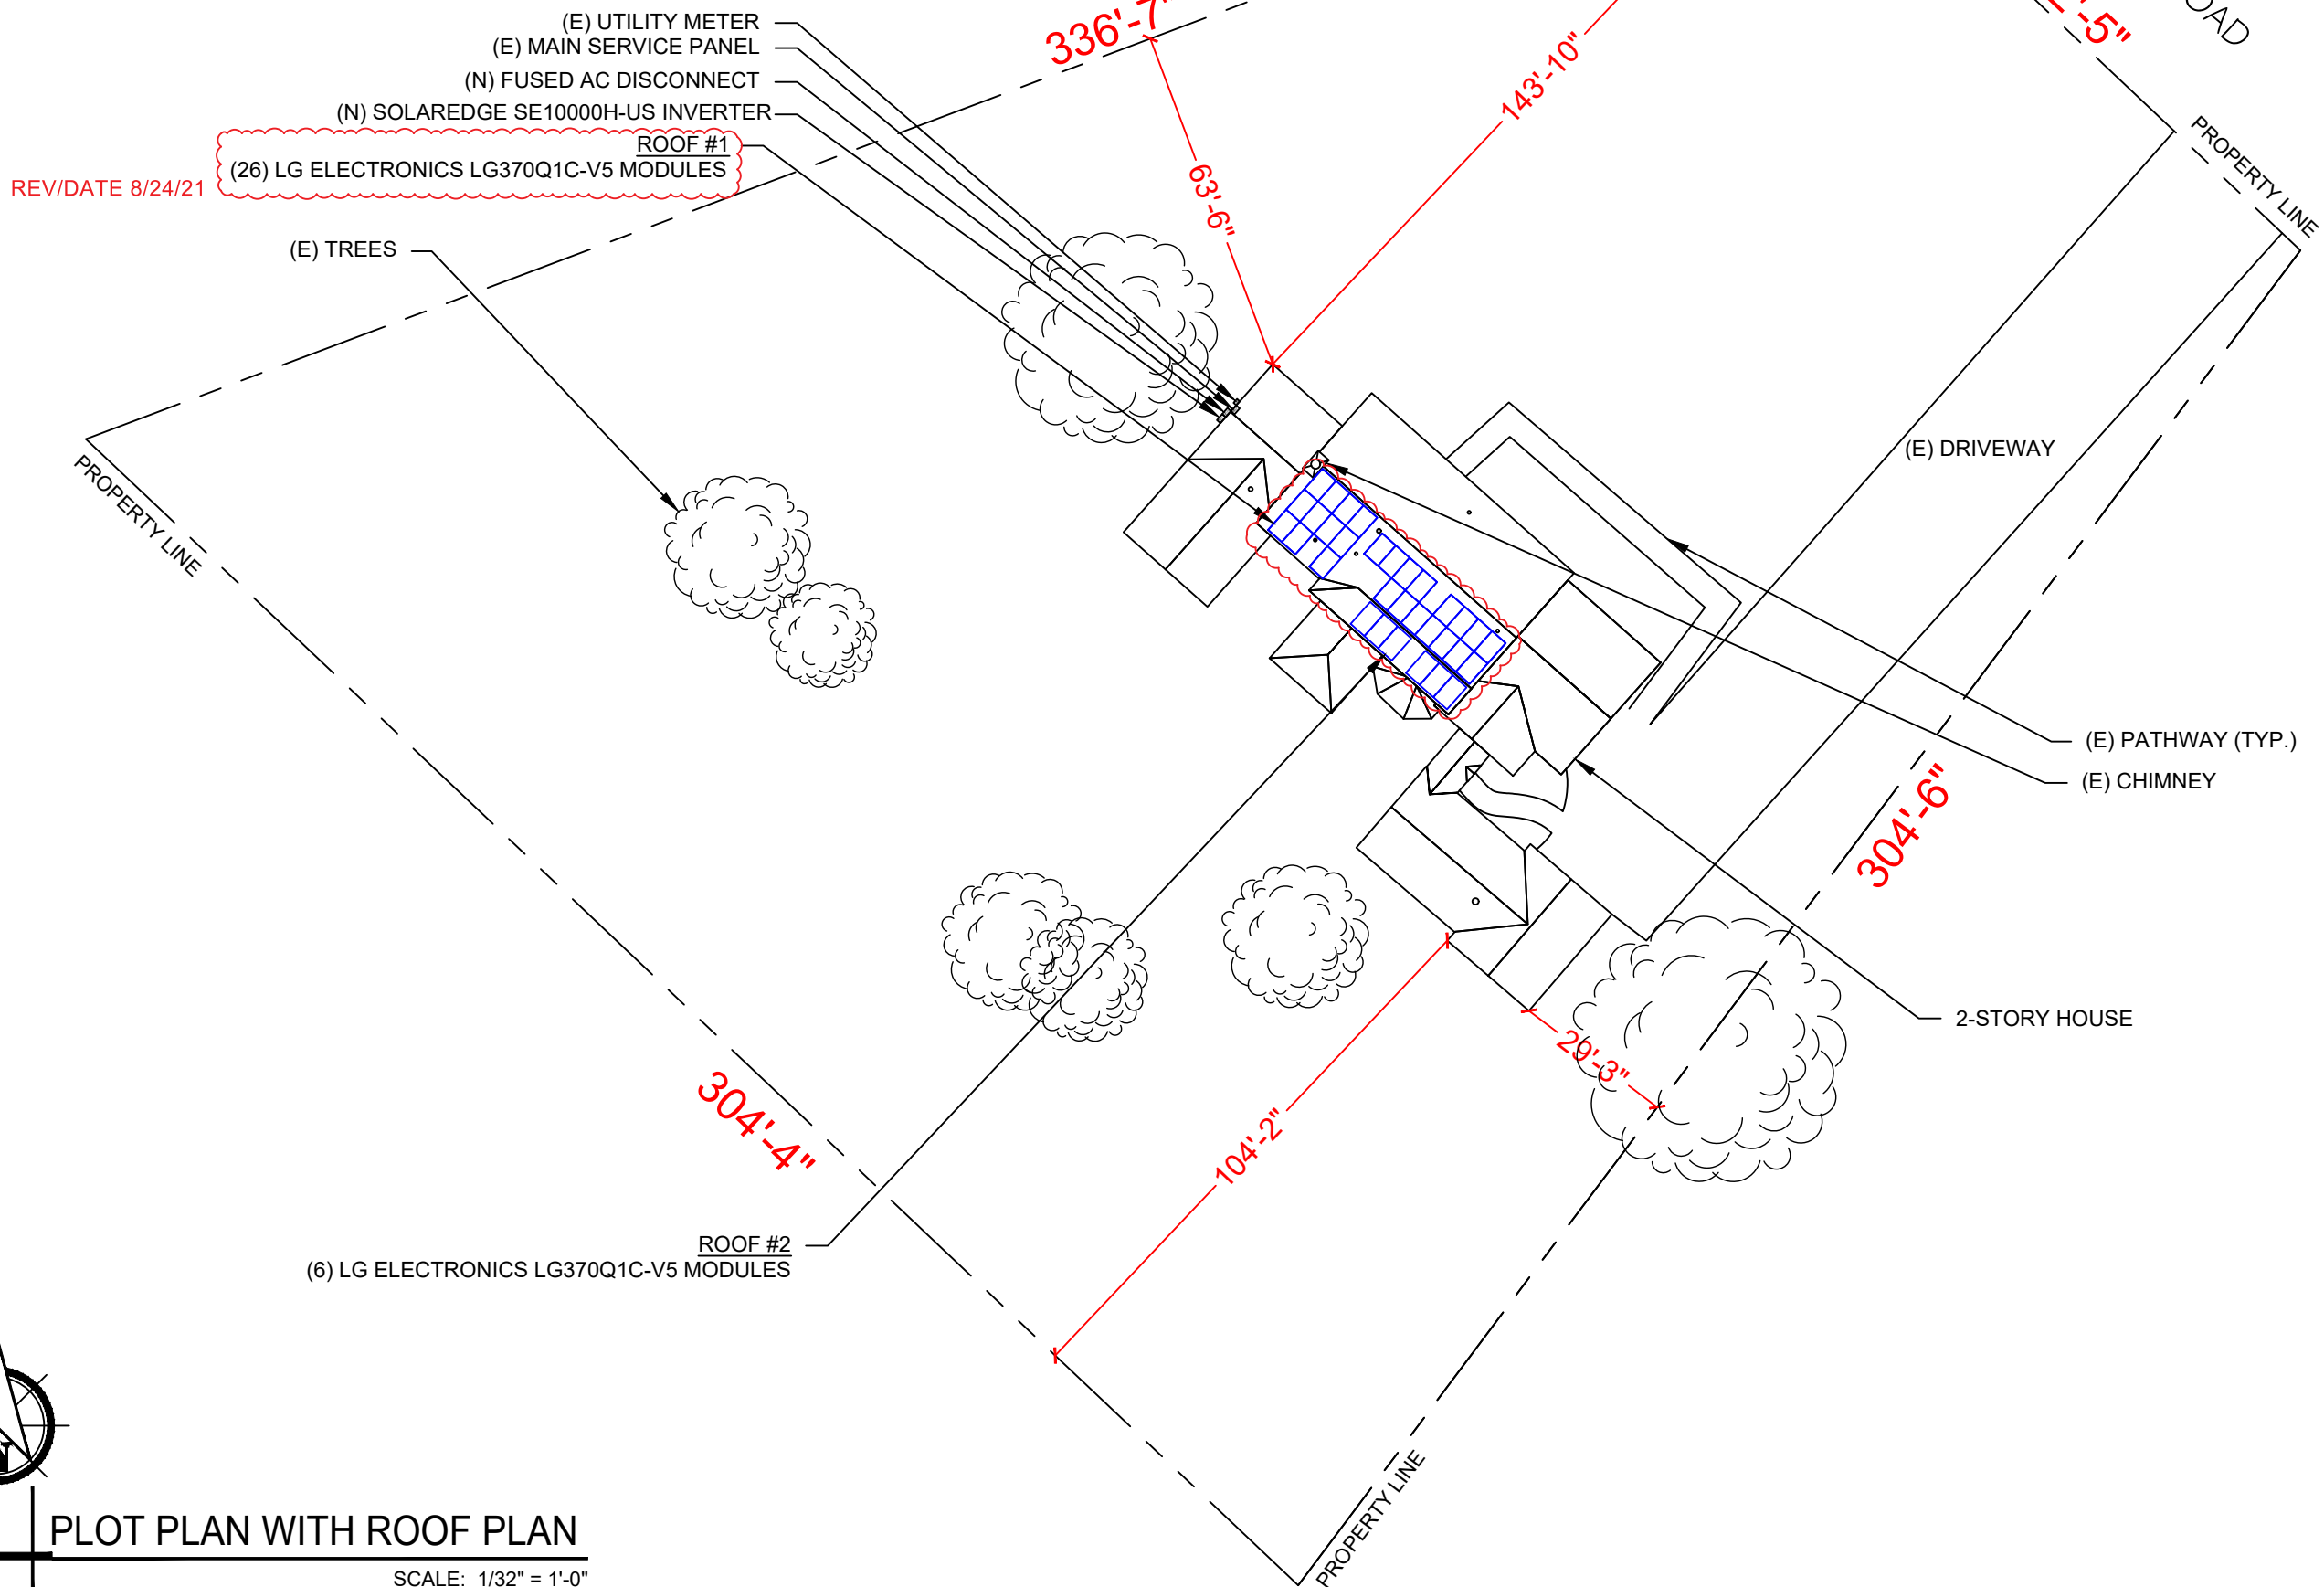

TITAN SOLAR POWER

210 N Sunway Dr,
Gilbert, AZ 85233
www.titansolarpower.com
ELECTRICAL LIC#: U.33714

REVISIONS

DESCRIPTION	DATE	REV
REVISION	08/24/2021	A

Signature with Seal

DATE: 08/24/2021

PROJECT NAME & ADDRESS

**STEPHEN MILLER
RESIDENCE**
51 HILLTOP ROAD
BILTMORE FOREST, NC 28803
PH NO. 828 712 0672
EMAIL ID: smiller@genspan.

SHEET NAME

SITE PLAN

SHEET SIZE

**ANSI B
11" X 17"**

SHEET NUMBER

PV-1



1

PLOT PLAN WITH ROOF PLAN

PV-1

SCALE: 1/32" = 1'-0"

DESIGN SPECIFICATION	
RISK CATEGORY:	II
CONSTRUCTION:	SFD
ZONING:	RESIDENTIAL
SNOW LOAD (ASCE 7-10):	15 PSF
EXPOSURE CATEGORY:	B
WIND SPEED (ASCE 7-10):	115 MPH

PANEL HEIGHT OFF ROOF	4"
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MODULE TYPE, DIMENSIONS & WEIGHT	
NUMBER OF MODULES:	32 MODULES
MODULE TYPE:	LG ELECTRONICS LG370Q1C-V5
MODULE WEIGHT:	40.79 LBS
MODULE DIMENSIONS:	66.93" X 40" = 18.59 SF
UNIT WEIGHT OF AREA:	2.20 PSF

ROOF DESCRIPTION					
ROOF	ROOF TILT	AZIMUTH	TRUSS SIZE	TRUSS SPACING	ROOF MATERIAL
#1	27°	222°	2X8	16"	COMP SHINGLE
#2	15°	222°	2X8	16"	COMP SHINGLE


REV/DATE 8/24/21

ARRAY AREA & ROOF AREA CALC'S				
ROOF	# OF MODULES	ARRAY AREA (Sq. Ft.)	ROOF AREA (Sq. Ft.)	ROOF AREA COVERED BY ARRAY (%)
#1	26	432.69	669.39	65
#2	6	116.3	194.52	60


LEGEND	
[JB]	- JUNCTION BOX
[INV]	- INVERTER
[ACD]	- AC DISCONNECT
[MSP]	- MAIN SERVICE PANEL
[UM]	- UTILITY METER
○ □	- VENT, ATTIC FAN (ROOF OBSTRUCTION)
●	- ROOF ATTACHMENT
---	- CONDUIT

TITAN SOLAR POWER
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 ELECTRICAL LIC#: U.33714

REVISIONS		
DESCRIPTION	DATE	REV
REVISION	08/24/2021	A

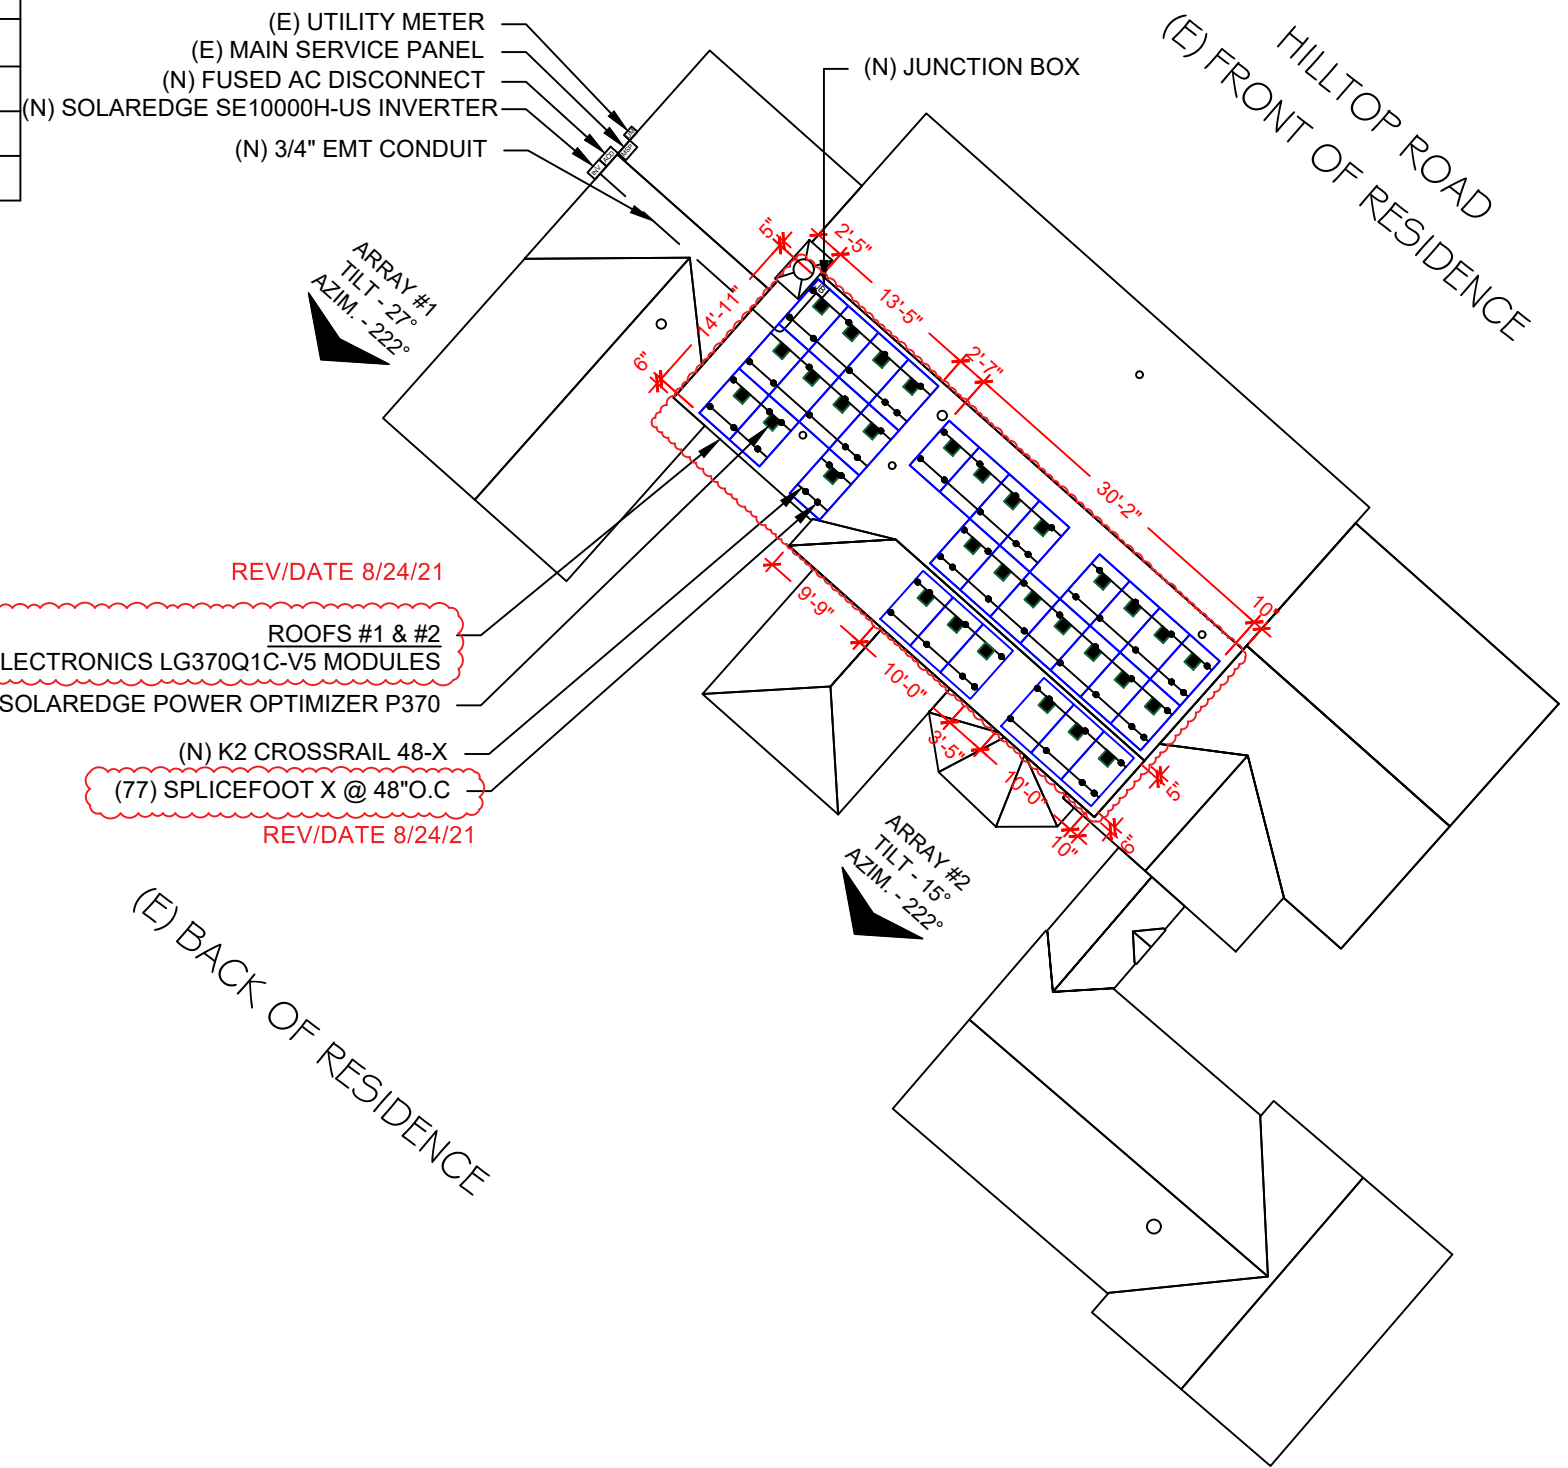

- REV/DATE 8/24/21
- ROOFS #1 & #2
- (32) LG ELECTRONICS LG370Q1C-V5 MODULES
- (32) SOLAREdge POWER OPTIMIZER P370
- (N) K2 CROSSRAIL 48-X
- (77) SPLICEFOOT X @ 48" O.C
- REV/DATE 8/24/21

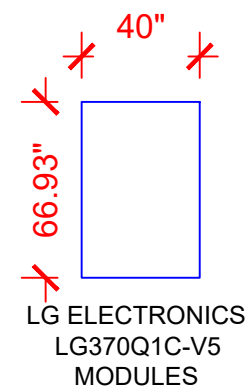

1 ROOF PLAN & MODULES

PV-2 SCALE: 1/16" = 1'-0"

Signature with Seal

 DATE: 08/24/2021

PROJECT NAME & ADDRESS
**STEPHEN MILLER
 RESIDENCE**
 51 HILLTOP ROAD
 BILTMORE FOREST, NC 28803
 PH NO. 828 712 0672
 EMAIL ID: smiller@genspan.

SHEET NAME	ROOF PLAN & MODULES
SHEET SIZE	ANSI B 11" X 17"
SHEET NUMBER	PV-2


BILL OF MATERIALS

EQUIPMENT	QTY	DESCRIPTION
SOLAR PV MODULE	32	LG ELECTRONICS LG370Q1C-V5
OPTIMIZER	32	SOLAREGE POWER OPTIMIZER P370
INVERTER	1	SOLAREGE SE10000H-US
AC DISCONNECT	1	EATON DG222NRB, PV SYSTEM AC DISCONNECT SWITCH FUSED, 60A W/X FUSES, 120/240V 2P NEMA 3R
JUNCTION BOX	1	JUNCTION BOX, NEMA 3R, UL LISTED
ATTACHMENT	77	SPLICE FOOT X
ATTACHMENT	77	K2 SOLAR SEAL BUTYL PAD
ATTACHMENT	154	MS X 60 LAG SCREWS
ATTACHMENT	77	CAP SCREW, HEX HEAD, 5/16"-18" X 1"
RAILS	16	K2 CROSSRAIL 48-X RAIL (166")
BONDED SPLICE	2	SPLICE KIT
CLAMPS	82	MODULES CLAMPS (MID CLAMPS & END CLAMPS)
GROUNDING LUG	9	GROUNDING LUG

REV/DATE 8/24/21

A B - MODULE STRINGING

REV/DATE 8/24/21

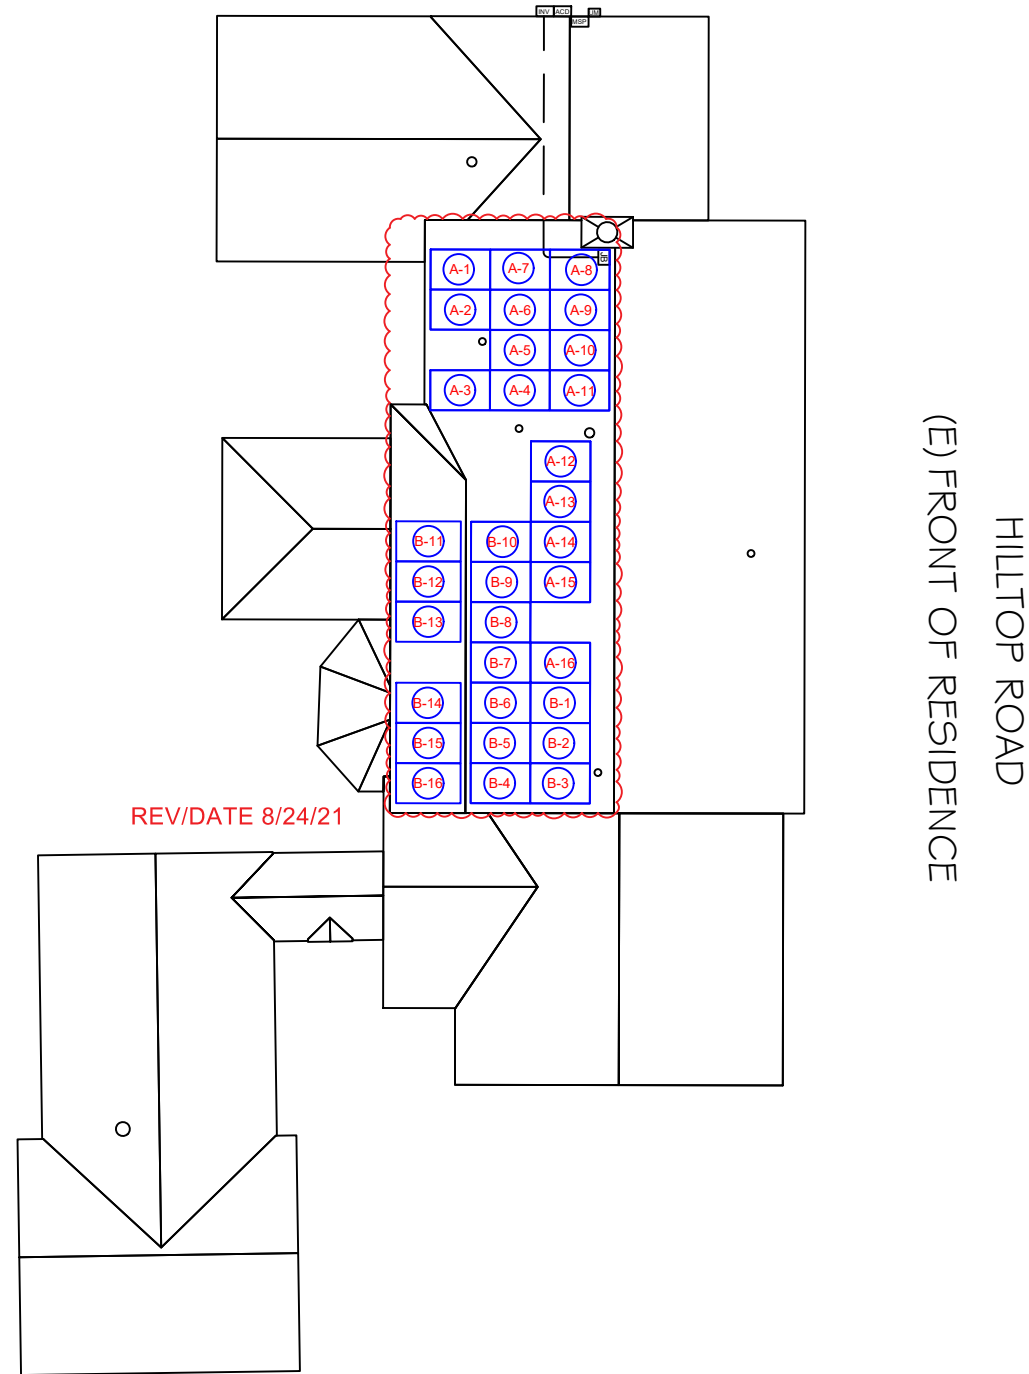

REV/DATE 8/24/21



1 ROOF PLAN WITH STRING LAYOUT & BOM

PV-2A

SCALE: 1/16" = 1'-0"



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DATE: 08/24/2021

PROJECT NAME & ADDRESS

**STEPHEN MILLER
RESIDENCE**
51 HILLTOP ROAD
BILTMORE FOREST, NC 28803
PH NO. 828 712 0672
EMAIL ID: smiller@genspan.

SHEET NAME

**STRING
LAYOUT & BOM**

SHEET SIZE

**ANSI B
11" X 17"**

SHEET NUMBER


PV-2A

LG NeON[®]R



380W | 375W | 370W | 365W

LG NeON[®]R is powerful solar module that provides world-class performance. A new cell structure that eliminates electrodes on the front maximizes the utilization of light and enhances reliability. LG NeON[®]R is a result of LG's efforts to increase customer's values beyond efficiency. LG NeON[®]R features enhanced durability, performance under real-world conditions, an enhanced warranty and aesthetic design suitable for roofs.

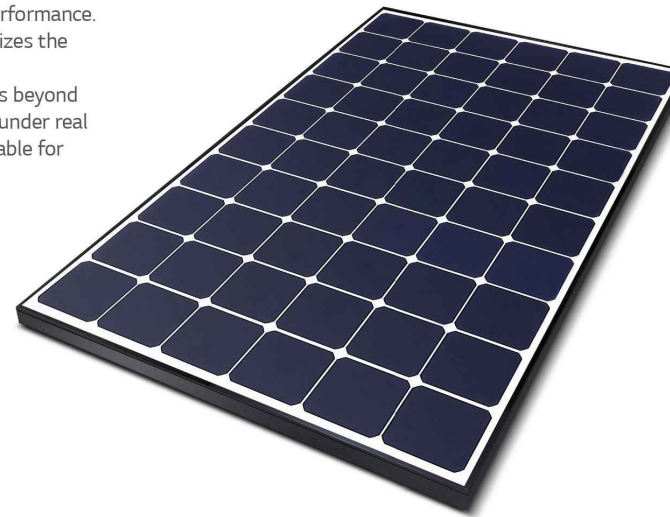

Feature



Aesthetic Roof

LG NeON[®]R has been designed with aesthetics in mind: the lack of any electrodes on the front creates an improved, modern aesthetic.



Extended Product Warranty

LG has extended the product warranty of the LG NeON[®]R to 25 years which is top level of the industry.



Enhanced Performance Warranty

LG NeON[®]R has an enhanced performance warranty. After 25 years, LG NeON[®]R is guaranteed to perform at minimum 90.8% of initial performance.



More generation per square meter

The LG NeON[®]R has been designed to significantly enhance its output, making it efficient even in limited space.

About LG Electronics

LG Electronics is a global big player, committed to expanding its operations with the solar market. The company first embarked on a solar energy source research program in 1985, supported by LG Group's vast experience in the semi-conductor, LCD, chemistry and materials industries. In 2010, LG Solar successfully released its first MonoX[®] series to the market, which is now available in 32 countries. The NeON[®] (previous MonoX[®] NeON), NeON[®]2, NeON[®]2 BiFacial won the "Intersolar AWARD" in 2013, 2015 and 2016, which demonstrates LG Solar's lead, innovation and commitment to the industry.



LG NeON[®]R

LG380Q1C-V5 | LG375Q1C-V5 | LG370Q1C-V5 | LG365Q1C-V5

General Data

Cell Properties(Material / Type)	Monocrystalline / N-type
Cell Maker	LG
Cell Configuration	60 Cells (6 x 10)
Module Dimensions(L x W x H)	1,700mm x 1,016mm x 40mm
Weight	17.5 kg
Glass(Thickness / Material)	2.8mm / Tempered Glass with AR Coating
Backsheet(Color)	White
Frame(Material)	Anodized Aluminium
Junction Box(Protection Degree)	IP68 with 3 Bypass Diodes
Cables(Length)	1,000mm x 2EA
Connector(Type / Maker)	MC4 / MC

Certifications and Warranty

Certifications	IEC 61215-1/-1-1-1/2:2016, IEC 61730-1/2:2016 UL 1703 ISO 9001, ISO 14001, ISO 50001 OHSAS 18001
Salt Mist Corrosion Test	IEC 61701:2012 Severity 6
Ammonia Corrosion Test	IEC 62716:2013
Module Fire Performance	Type 1 (UL 1703)
Fire Rating	Class C (UL 790, ULC/ORD C 1703)
Product Warranty	25 Years
Output Warranty of Pmax	Linear Warranty ¹⁾

¹⁾ First year: 98%, 2) After 1st year: 0.3% annual degradation 3) 90.8% for 25 years
²⁾ LG380Q1C-V5 model has UL 1703 certification only

Temperature Characteristics


NMOT*	[°C]	44 ± 3
Pmax	[%/°C]	-0.30
Voc	[%/°C]	-0.24
Isc	[%/°C]	0.037

* NMOT(Nominal Module Operating Temperature): Irradiance 800 W/m², Ambient temperature 20 °C, Wind speed 1 m/s, Spectrum AM 1.5

Electrical Properties (NMOT)

Model	LG380Q1C-V5	LG375Q1C-V5	LG370Q1C-V5	LG365Q1C-V5	
Maximum Power (Pmax)	[W]	286	282	279	275
MPP Voltage (Vmpp)	[V]	37.3	37.1	36.9	36.6
MPP Current (Impp)	[A]	7.67	7.61	7.55	7.51
Open Circuit Voltage (Voc)	[V]	40.3	40.3	40.3	40.2
Short Circuit Current (Isc)	[A]	8.73	8.72	8.71	8.70

I-V Curves

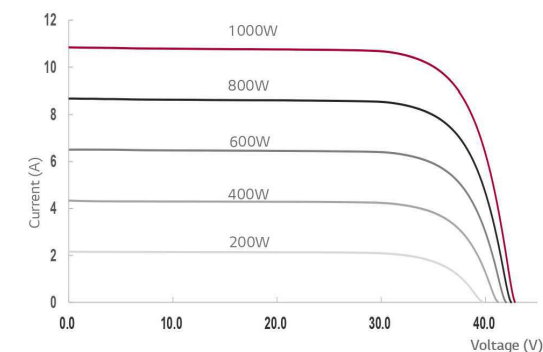

Electrical Properties (STC*)

Model		LG380Q1C-V5	LG375Q1C-V5	LG370Q1C-V5	LG365Q1C-V5
Maximum Power (Pmax)	[W]	380	375	370	365
MPP Voltage (Vmpp)	[V]	37.4	37.2	37.0	36.7
MPP Current (Impp)	[A]	10.17	10.09	10.01	9.95
Open Circuit Voltage (Voc, ±5%)	[V]	42.9	42.8	42.8	42.8
Short Circuit Current (Isc, ±5%)	[A]	10.84	10.83	10.82	10.80
Module Efficiency	[%]	22.0	21.7	21.4	21.1
Power Tolerance	[%]	0 ~ +3			

* STC (Standard Test Condition): Irradiance 1000 W/m², Cell Temperature 25 °C, AM 1.5,

** Measure Tolerance : ± 3%

Operating Conditions


Operating Temperature	[°C]	-40 ~ +90
Maximum System Voltage	[V]	1,000
Maximum Series Fuse Rating	[A]	20
Mechanical Test Load(Front)	[Pa / psf]	5,400 / 113
Mechanical Test Load(Rear)	[Pa / psf]	4,000 / 83.5

* Mechanical Test Load 5,400Pa / 4,000Pa based on IEC 61215-2 : 2016
 (Test Load = Design Load x Safety Factor(1.5))

Packaging Configuration

Number of Modules Per Pallet	[EA]	25
Number of Modules Per 40ft HQ Container	[EA]	650
Packaging Box Dimensions (L x W x H)	[mm]	1,750 x 1,120 x 1,221
Packaging Box Gross Weight	[kg]	473

Dimensions (mm / inch)

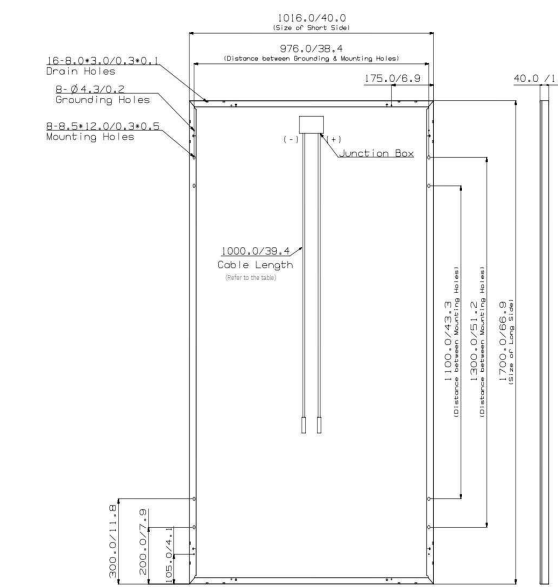

TITAN SOLAR POWER

210 N Sunway Dr,
Gilbert, AZ 85233

www.titansolarpower.com

ELECTRICAL LIC#: U.33714

REVISIONS

DESCRIPTION	DATE	REV
REVISION	08/24/2021	A

Signature with Seal

DATE: 08/24/2021

PROJECT NAME & ADDRESS

STEPHEN MILLER
RESIDENCE
51 HILLTOP ROAD
BILTMORE FOREST, NC 28803
PH NO. 828 712 0672
EMAIL ID: smiller@genspan.

SHEET NAME

EQUIPMENT
SPECIFICATION

SHEET SIZE

ANSI B
11" X 17"

SHEET NUMBER

PV-7



LG Electronics Inc.
Solar Business Division
LG Twin Towers, 128 Yeou-daero, Yeongdeungpo-gu, Seoul
07336, Korea
www.lg-solar.com

Product specifications are subject to change without notice.
DS-V5-60-C-G-F-EN-90812


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Structural Capacity, PC

STRUCTURAL CONSULTING GROUP

North Carolina Firm License Number – C3406



August 22, 2021

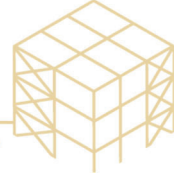Titan Solar Power NC, Inc.
525. W. Baseline Road
Mesa, AZ 85210

Re: Miller, Stephen - TSP93362 (SCPC Project No. - 2021.26.18080)
51 Hilltop Road
Biltmore Forest, NC 28803

Titan Solar Power NC:

At the request of Titan Solar Power NC, Structural Capacity, PC (SCPC) has evaluated the roof structure at the above noted site to determine its adequacy to support the attachment of roof mounted solar arrays. The roof structure is composed of wood sheathing supported by 2x8 wood rafters at 16" o.c. The maximum rafter span does not exceed approximately 17'-1".

Design Criteria:

- Ground Snow Load = 15 psf
- Wind speed = 115 mph
- Risk Category = II / Wind Exposure B
- PV module Dead Load = 3.5psf (max)
- PV Module Count = 32

Each panel will be supported by (2) mounting rails, (1) at each end. The mounting legs of the solar panel railing will be attached directly to the rafters with a 5/16 (min) inch diameter lag screw. The installer shall use best practice construction methods to locate the lag screw in the center of each rafter. All wood members supporting PV modules should consist of sound lumber without significant signs of deterioration.

The mounting legs of the solar panel racking system shall be located at 5'-4" o.c. maximum. The mounting legs should be staggered at the primary framing member spacing (1'-4") at adjacent solar panel rails. The maximum rail cantilever span should be limited to 1'-4".

The existing roof structure at the above referenced site is adequate to support the solar panel loadings, as noted above, per the 2018 North Carolina Residential Code, if installed in accordance with the above stated conditions. The adequacy of the solar panels and

solar racking system are outside the scope of this letter and to be provided by solar panel and racking manufacturer, if required.


If any conditions are found in conflict with those stated above, SCPC should be made aware immediately for re-evaluation and report amendment, as applicable, before proceeding with solar panel installation.

Sincerely,

Structural Capacity, PC



Adrian S. Durham, PE, SE

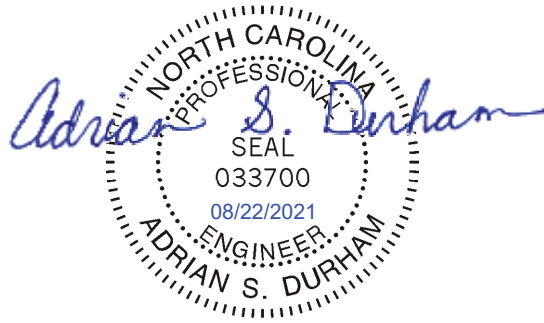

Adrian
Durham

Digitally signed by Adrian
Durham
Date: 2021.08.22 18:00:09
-04'00'

Zoning Compliance Application

Town of Biltmore Forest

Name

Tunc and Nancy Togar

Property Address

3 Stuyvesant Crescent, Biltmore Forest NC

Phone

(828) 242-2044

Email

Togar.tunc31@gmail.com

Parcel ID/PIN Number

96-46-93-0608

ZONING INFORMATION

Current Zoning

R-1

Lot Size

.89 Acres, 38,678 Sq, Ft,

Maximum Roof Coverage

4,682 square feet (Up to 1 acres)

Proposed Roof Coverage Total

4,874

Maximum Impervious Surface Coverage

Up to 1 acre (27.5 percent of lot area)

Proposed Impervious Surface Coverage

10,820

Front Yard Setback

60 feet (R-1 District)

Side Yard Setback

20 feet (R-1 District)

Rear Yard Setback

25 feet (R-1 District)

Building Height

33' x 8"

Description of the Proposed Project

This remodeling project consist of reconfiguration of much of the first floor, including enlarging the existing Kitchen, adding additional area to the existing Garage, adding a complete new First Floor Owners Suite, adding a new Front Entry Open Terrace, adding a new screened Rear Porch and reconfiguring and resurfacing the existing Driveway.

Estimated Start Date

12/1/2021

Estimated Completion Date

12/1/2022

Estimated Cost of Project

\$1,100,000.00

Supporting Documentation (Site Plan, Drawings, Other Information)

03-Left Side Elevation Rendering.pdf

04-Rear Elevation Rendering.pdf

05-Remodeled First Floor Plan.pdf

06-Remodeled Site Plan.pdf


01-Front Elevation Rendering.pdf

02-Right Side Elevation Rendering.pdf

Applicant Signature

Date

8/24/2021

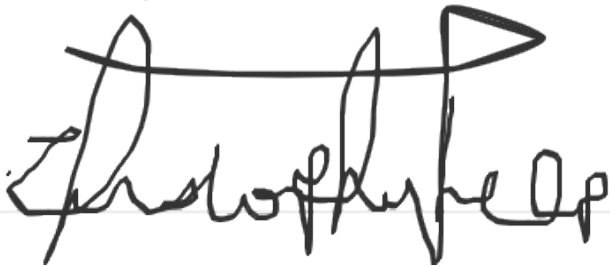A handwritten signature in black ink, appearing to read "Christopher J. Hayes". The signature is written in a cursive style with a horizontal line above the main body of the text.

VARIANCE APPLICATION

Town of Biltmore Forest

Name

Tunc and Nancy Togar

Address

3 Stuyvesant Crescent, Biltmore Forest, NC

Phone

(828) 242-2044

Email

togar.tunc31@gmail.com

Current Zoning/Use

R

Requested Use

APPLICATION REQUIREMENTS: An application to the Board of Adjustment for a variance must be submitted to the Town of Biltmore Forest Town Manager at least 21 days prior to the meeting at which the application will be considered. A pre-application meeting with Town staff is required prior to application submittal to the Board of Adjustment.

What would you like to do with your property?

We would like to add on to the existing home with a new First Floor Owner's Suite, consisting of a new Owner's Bedroom, new Owners Bath, and a new Owner's Wardrobe Closets. We would like to expand our existing Garage to include better sized areas for our automobiles and better garage Storage areas. We would like to expand and renovate our Kitchen. Finally, we would like to add a new Screened Porch.

What does the ordinance require?

The Total Roof requirements are 4,682 Sq. Ft. and we are at 4,874 Sq. Ft. for this project.

BOARD OF ADJUSTMENT: N.C.G.S. 160A-388(D) requires that the Board of Adjustment shall vary the provisions of the Zoning Ordinance only upon a showing of ALL the items below. The Board of Adjustment must follow strict procedure and all determinations must be decided by a concurring vote of four-fifths of the members of the Board. It is important to provide detailed supporting documentation for the Board of Adjustment to review. If necessary, additional sheets may be attached to this application.

REQUIRED FINDINGS: Please provide a thorough response to each.**Unnecessary hardship would result from the strict application of the ordinance.**

We are only going over the stated Roof Covered Area by an insignificant amount, however reducing the size/square footage of the new areas to be added on would result in Room sizes that would not meet the Owner's needs for each new area.

The hardship results from conditions that are peculiar to the property, such as location, size, or topography.

The hardship is not caused or related to size or location of the property.

The hardship did not result from actions taken by the applicant or the property owner.

There is not action that has caused hardship. The Owner's are simply attempting to renovate their existing, dated home and bring the property up to today's real estate expectations, as well as meet their own needs.

The requested variance is consistent with the spirit, purpose, and intent of the ordinance, such that

public safety is secured, and substantial justice is achieved.


The variance requested will allow this extensive renovation to this 40 year old home up to date and greatly improve the exterior of the home, along with creating wonderful new areas to the First Floor. This project will very much so keep the spirit of Biltmore Forest, and provide a safe and well executed final product.


I hereby certify that all of the information set forth above is true and accurate to the best of my knowledge.

Signature

Date

9/1/2021

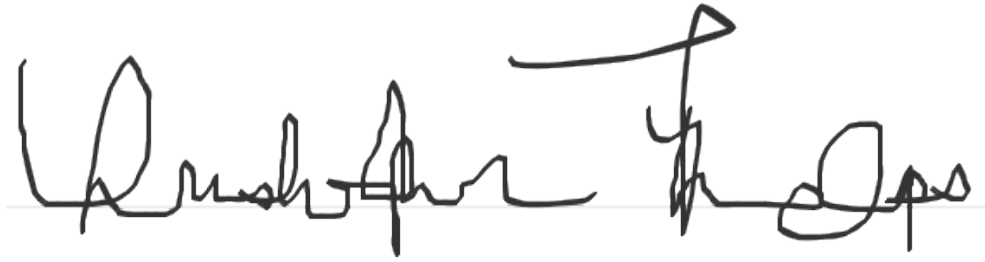A handwritten signature in black ink, appearing to read "Wendell J. [unclear]". The signature is written in a cursive style with a horizontal line underneath it.

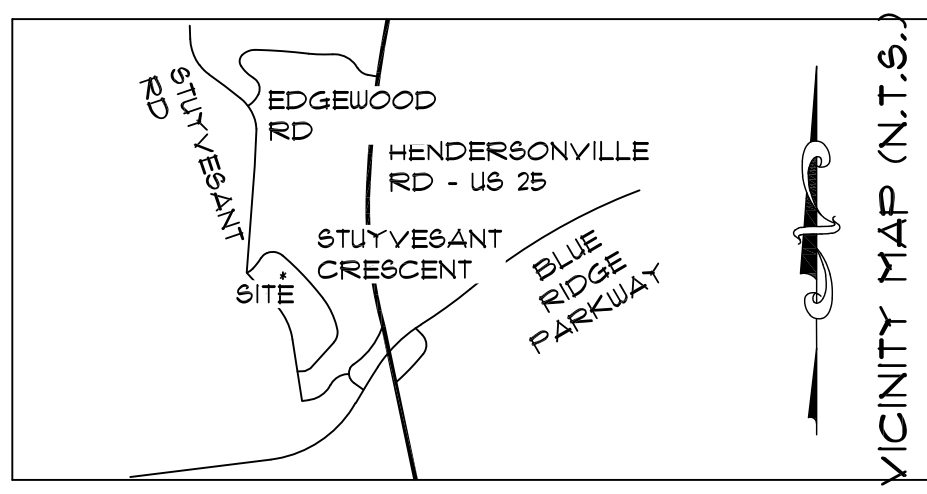

DB 5712 PG 1159
PB 32 PG 18, LOT 2
PIN 9646-83-9462

DB 6000 PG 481
PB 32 PG 18, LOT 1
PIN 9646-83-7651

*5 EIR - ID CAP
"ED HOLMES &
ASSOC."
BETWEEN
FENCELINES

NIR - SET AT
BASE OF UP

EIS
IN TREE
ROOT (SEE
NOTE 10)

ABBREVIATIONS

- DB...DEED BOOK
- PL...PLAT BOOK
- PG...PAGE
- R/W...RIGHT OF WAY
- PIN...PARCEL IDENTIFICATION NUMBER
- NAD 83...NORTH AMERICAN DATUM OF 1983
- NAV83...NORTH AMERICAN VERTICAL DATUM OF 1988
- NRS...NATIONAL SPATIAL REFERENCE SYSTEM
- N.T.S...NOT TO SCALE
- T...TOTAL DISTANCE
- TYP...(TYPICAL)
- S/B...BUILDING SETBACK (SEE NOTE 8)
- F/K/A...FORMERLY KNOWN AS
- L/A...LOCATION APPROXIMATE
- HVAC...HEATING & AIR UNITS

LEGEND


- EXISTING CONCRETE MONUMENT (ECM)
- EXISTING IRON REBAR (EIR)
- ⊙ EXISTING IRON PIPE (EIP)
- ⊕ EXISTING MAGNETIC NAIL (EMN) OR IRON SPIKE (EIS)
- NEW IRON REBAR SET THIS SURVEY (NIR)
- ▲ CONTROL POINT (CP)
- ⊙ UTILITY POLE (UP)
- ⊙ LIGHT POLE
- ⊙ GUY ANCHOR (GA)
- ⊙ COMMUNICATIONS PEDESTAL (CPED)
- ⊙ ELECTRIC TRANSFORMER (TRAN)
- ⊙ SANITARY SEWER MANHOLE (SMH)
- ⊙ SANITARY SEWER CLEANOUT (SCO)
- ⊙ STORM DRAIN JUNCTION BOX (SDJB)
- ⊙ FIRE HYDRANT (FH)
- ⊙ WATER METER (WM)
- SURVEYED BOUNDARY LINE
- RIGHT OF WAY LINE
- ADJOINING DEED LINE (NOT SURVEYED)
- EASEMENT LINE
- BUILDING SETBACK LINE (SEE NOTE 8)
- TIE LINE ONLY
- CHAINLINK FENCELINE
- WILDLIFE (NETTING) FENCELINE
- OTHER FENCELINE AS NOTED
- OVERHEAD UTILITY LINE
- MARKED UNDERGROUND COMMUNICATIONS LINE (SEE NOTE 3)
- MARKED SANITARY SEWER LINE (SEE NOTE 3)
- MARKED WATER LINE (SEE NOTE 3)
- STORM PIPE

HOLLI ALEXANDRA
TOWE & JOHN
DAVID SPAKE
DB 6033 PG 1660
PB 46 PG 180,
LOT 14
PIN 9646-93-1553

VIRGINIA J. & JOSEPH A.
BAKER
DB 5715 PG 497
PB 46 PG 180, LOT 16
PIN 9646-83-8769

- NOTES**
1. SURVEYED AREA IS SUBJECT TO ALL RIGHTS OF WAY, EASEMENTS, RESERVATIONS, RESTRICTIONS, ETC. OF RECORD, INCLUDING, BUT NOT LIMITED TO, THOSE SHOWN THIS SURVEY.
 2. THIS SURVEY PERFORMED WITHOUT THE BENEFIT OF A PROVIDED TITLE SEARCH, AND MAY NOT SHOW ALL EASEMENTS, RESTRICTIONS, RIGHTS OF WAY, OR OTHER ENCUMBRANCES ETC. WHICH MAY BE DISCLOSED BY A FULL AND CURRENT EXAMINATION OF TITLE PERFORMED BY AN ATTORNEY AT LAW. THIS SURVEY SHALL NOT BE CONSIDERED A CERTIFICATION OF OWNERSHIP ZONING, TITLE OR GUARANTEE THAT THE PROPERTY IS FREE FROM ENCUMBRANCES.
 3. ANY UNDERGROUND UTILITIES OR FEATURES SHOWN THIS SURVEY ARE BASED SOLELY UPON APPARENT & CONSPICUOUS ABOVE GROUND FACILITIES OR UTILITY LOCATE MARKINGS UNLESS OTHERWISE NOTED. NO CERTIFICATION TO THE LOCATION OR EXISTENCE OF UNDERGROUND UTILITIES OR FEATURES THIS SURVEY. CONTACT 811 BEFORE DIGGING.
 4. ANY STREAMS, CREEKS, PONDS, LAKES, WETLANDS, ETC. LOCATED WITHIN THE SURVEYED AREA, SHOWN OR NOT SHOWN HEREON, MAY BE SUBJECT TO BUFFER AREAS. IT IS THE OWNER/DEVELOPER'S RESPONSIBILITY TO HAVE THE AREAS DESIGNATED BY PROFESSIONALS AUTHORIZED BY THE PROPER AUTHORITIES TO MAKE THESE DETERMINATIONS.
 5. DISTANCES SHOWN ARE HORIZONTAL GROUND DISTANCES IN US SURVEY FEET UNLESS OTHERWISE NOTED.
 6. AREAS CALCULATED BY COORDINATE METHOD UNLESS OTHERWISE NOTED.
 7. BY GRAPHICAL DETERMINATION, SURVEYED AREA DOES NOT LIE IN A FLOOD HAZARD AREA PER FEMA FLOOD INSURANCE RATE MAP 3100964600J, EFFECTIVE DATE 1/8/2010.
 8. THE SURVEYED AREA IS ZONED R-1 BY TOWN OF BILTMORE FOREST, HAVING SETBACKS AS FOLLOWS: 60' FRONT (FROM STREET), 25' REAR, 4 20' SIDE. SETBACKS SHOWN MAY BE SUBJECT TO INTERPRETATION BY TOWN OF BILTMORE FOREST. REFER TO THE TOWN OF BILTMORE FOREST CODE OF ORDINANCES FOR APPLICABLE REGULATIONS.
 9. ADJOINING PROPERTY OWNERSHIP INFORMATION PER BUNCOMBE COUNTY GIS WEBSITE, AND DEEDS & PLATS OF RECORD.
 10. NOTED EXISTING IRON SPIKE LOCATED IN ROOT OF APPARENT LARGE TREE NOW REMOVED, FOUND AT BASE OF DECORATIVE CEDAR VARIANT THIS SURVEY. PLAT NOT PREPARED FOR RECORDING IN ACCORDANCE WITH G.S. 41-30.

**HIGHLIGHTS
NEW ADDITION**

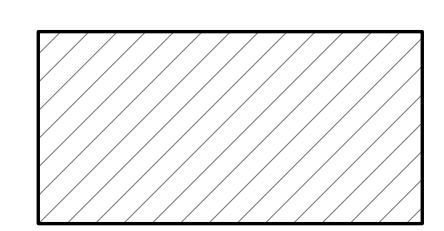

IMPERVIOUS AREA CALCULATIONS	
TOTAL ROOF COVERAGE	4,814
ENTRY TERRACE & STEPS	403
ALL DRIVEWAYS, MOTOR COURTS & SIDEWALKS	4,843
TOTAL IMPERVIOUS AREA	10,126
TOTAL LOT AREA	39,679
TOTAL IMPERVIOUS AREA %	26.18%

AREA OF SURVEY
0.89 ACRES
39,679 SQ. FT.

BEING
DB 5849 PG 652
PB 46 PG 180, LOT 15
PIN 9646-93-0608
NOTE: PROPERTY IS SUBJECT TO RESTRICTIONS IN DB 1286 PG 660 & ANY AMENDMENTS OR REVISIONS THERETO.

EMN (IN CONCRETE
AT CUT IN
ASPHALT CURB)
NC GRID
COORDINATES:
N: 663,671.01' NAD
83/11
E: 949,153.08' NAD
83/11

*5 EIR - ID CAP
"ED HOLMES &
ASSOC."
EAST CORNER
OF
LOT 14, PB 46
PG 180

CP #1 - 60D NAIL
NC GRID
COORDINATES:
N: 663,697.21' NAD
83/11
E: 949,171.72' NAD
83/11
C.F.: 0.99978424
- LOCALIZED POINT

A REMODELING PROJECT
FOR
THE TOGAR RESIDENCE
3 STUYVESANT CRESCENT
BILTMORE FOREST NORTH CAROLINA

ASHEVILLE DAY SCHOOL,
INC. F/K/A ASHEVILLE
COUNTY DAY SCHOOL
DB 1012 PG 161
PIN 9646-94-4038

PRELIMINARY SITE PLAN
SCALE: 1" = 10'-0"

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SEPTEMBER 21, 2021 RDW


Christopher
PHELPS
Inspiring Homes for Life

321 East Blvd., Suite 4, Charlotte, NC 28203
Tel. 704.377.5569
2021-028 TOGAR RESIDENCE REMODEL

BOUNDARY SURVEY FOR:
**NANCY P. & A.
TUNG TOGAR,
TRUSTEES**

PIN 9646-93-0608 • PROJECT #2024
TOWN OF BILTMORE FOREST
LIMESTONE TOWNSHIP, BUNCOMBE COUNTY, NC

PISGAH SURVEYING, PLLC
1503 ORLEANS AVE.
HENDERSONVILLE, NC 28791
(828) 515-1929 • NC FIRM #P-2288

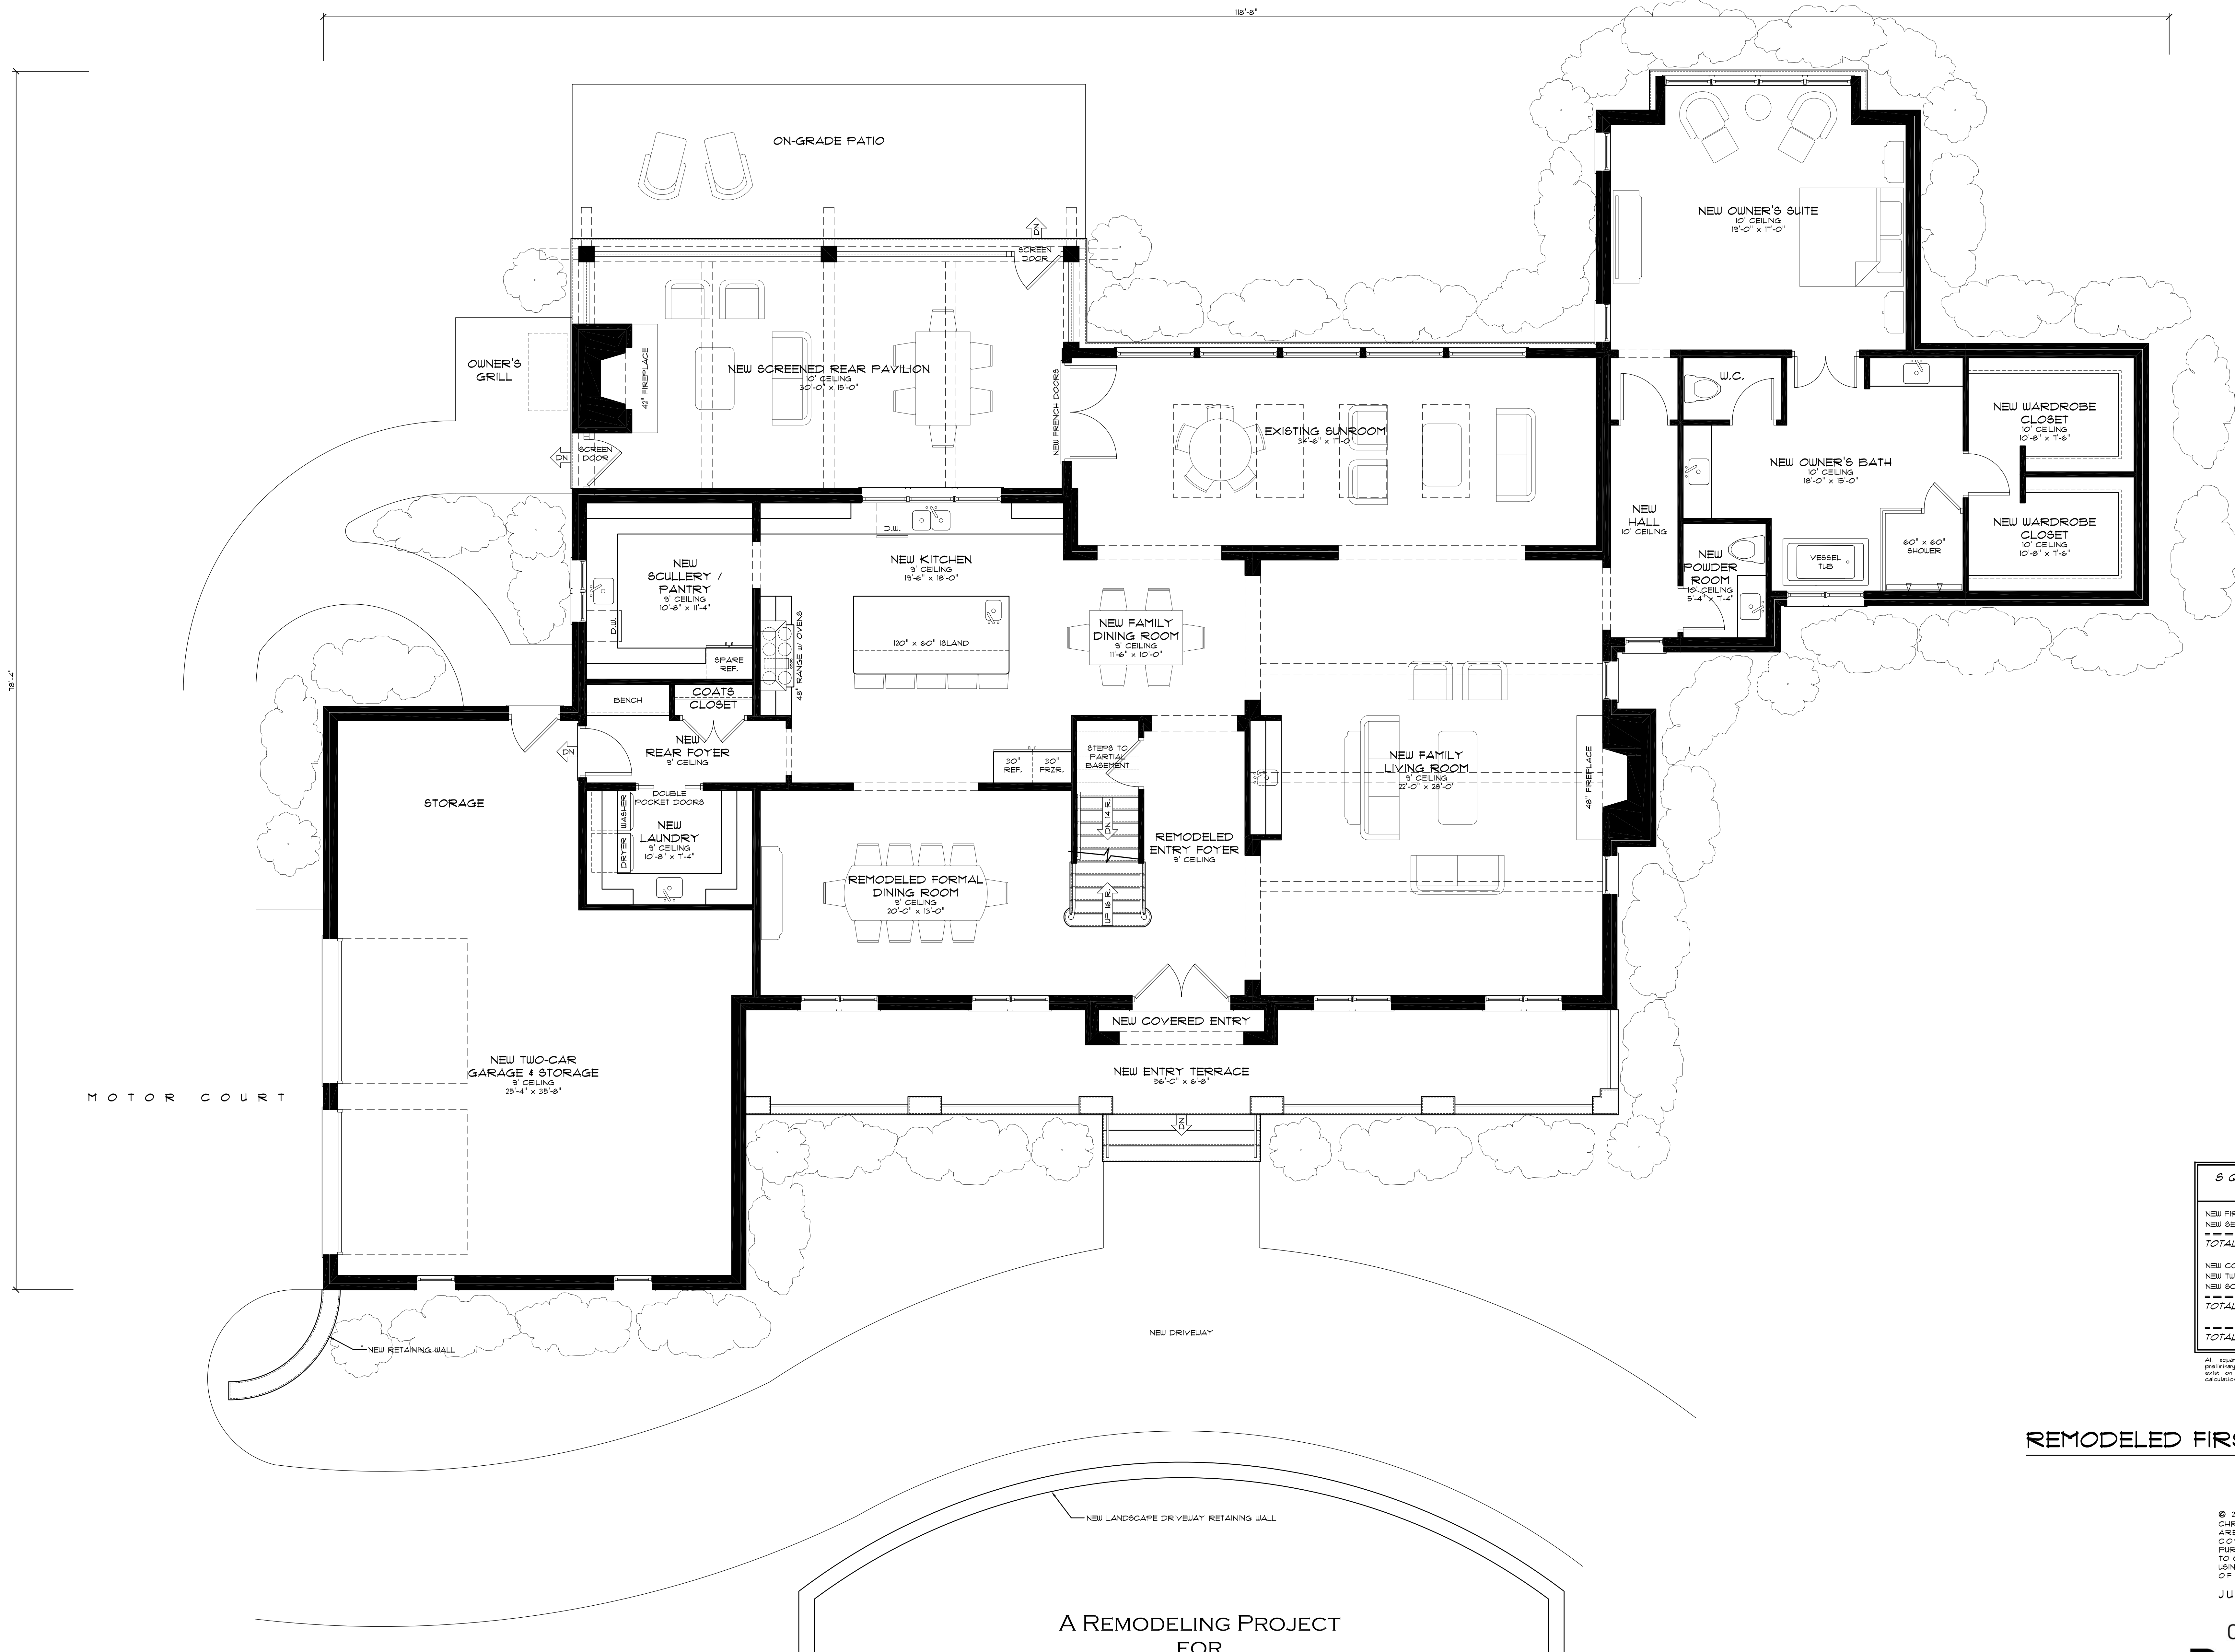


SQUARE FOOTAGE (TO OUTSIDE OF STUD WALL)	
NEW FIRST FLOOR HEATED	3,339
NEW SECOND FLOOR HEATED	N/A
TOTAL HEATED SQ. FT.	3,339
NEW COVERED ENTRY	30
NEW TWO-CAR GARAGE	840
NEW SCREENED REAR PAVILION	509
TOTAL UNHEATED SQ. FT.	1,379
TOTAL UNDER ROOF SQ. FT.	4,714

All square footage calculations have been derived from preliminary design sketches. Without exact dimensions that do not exist on preliminary design sketches, these square footage calculations are considered approximate.

REMODELED FIRST FLOOR PLAN
SCALE: 1/4" = 1'-0"

A REMODELING PROJECT
FOR
THE TOGAR RESIDENCE
3 STUYVESANT CRESCENT
BILTMORE FOREST NORTH CAROLINA

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JULY 13, 2021 RDW
Christopher PHELPS™
Inspiring Homes for Life
1230 West Morehead St., Suite 202, Charlotte, NC 28208
Tel. 704.377.5569
2021-028 TOGAR RESIDENCE REMODEL

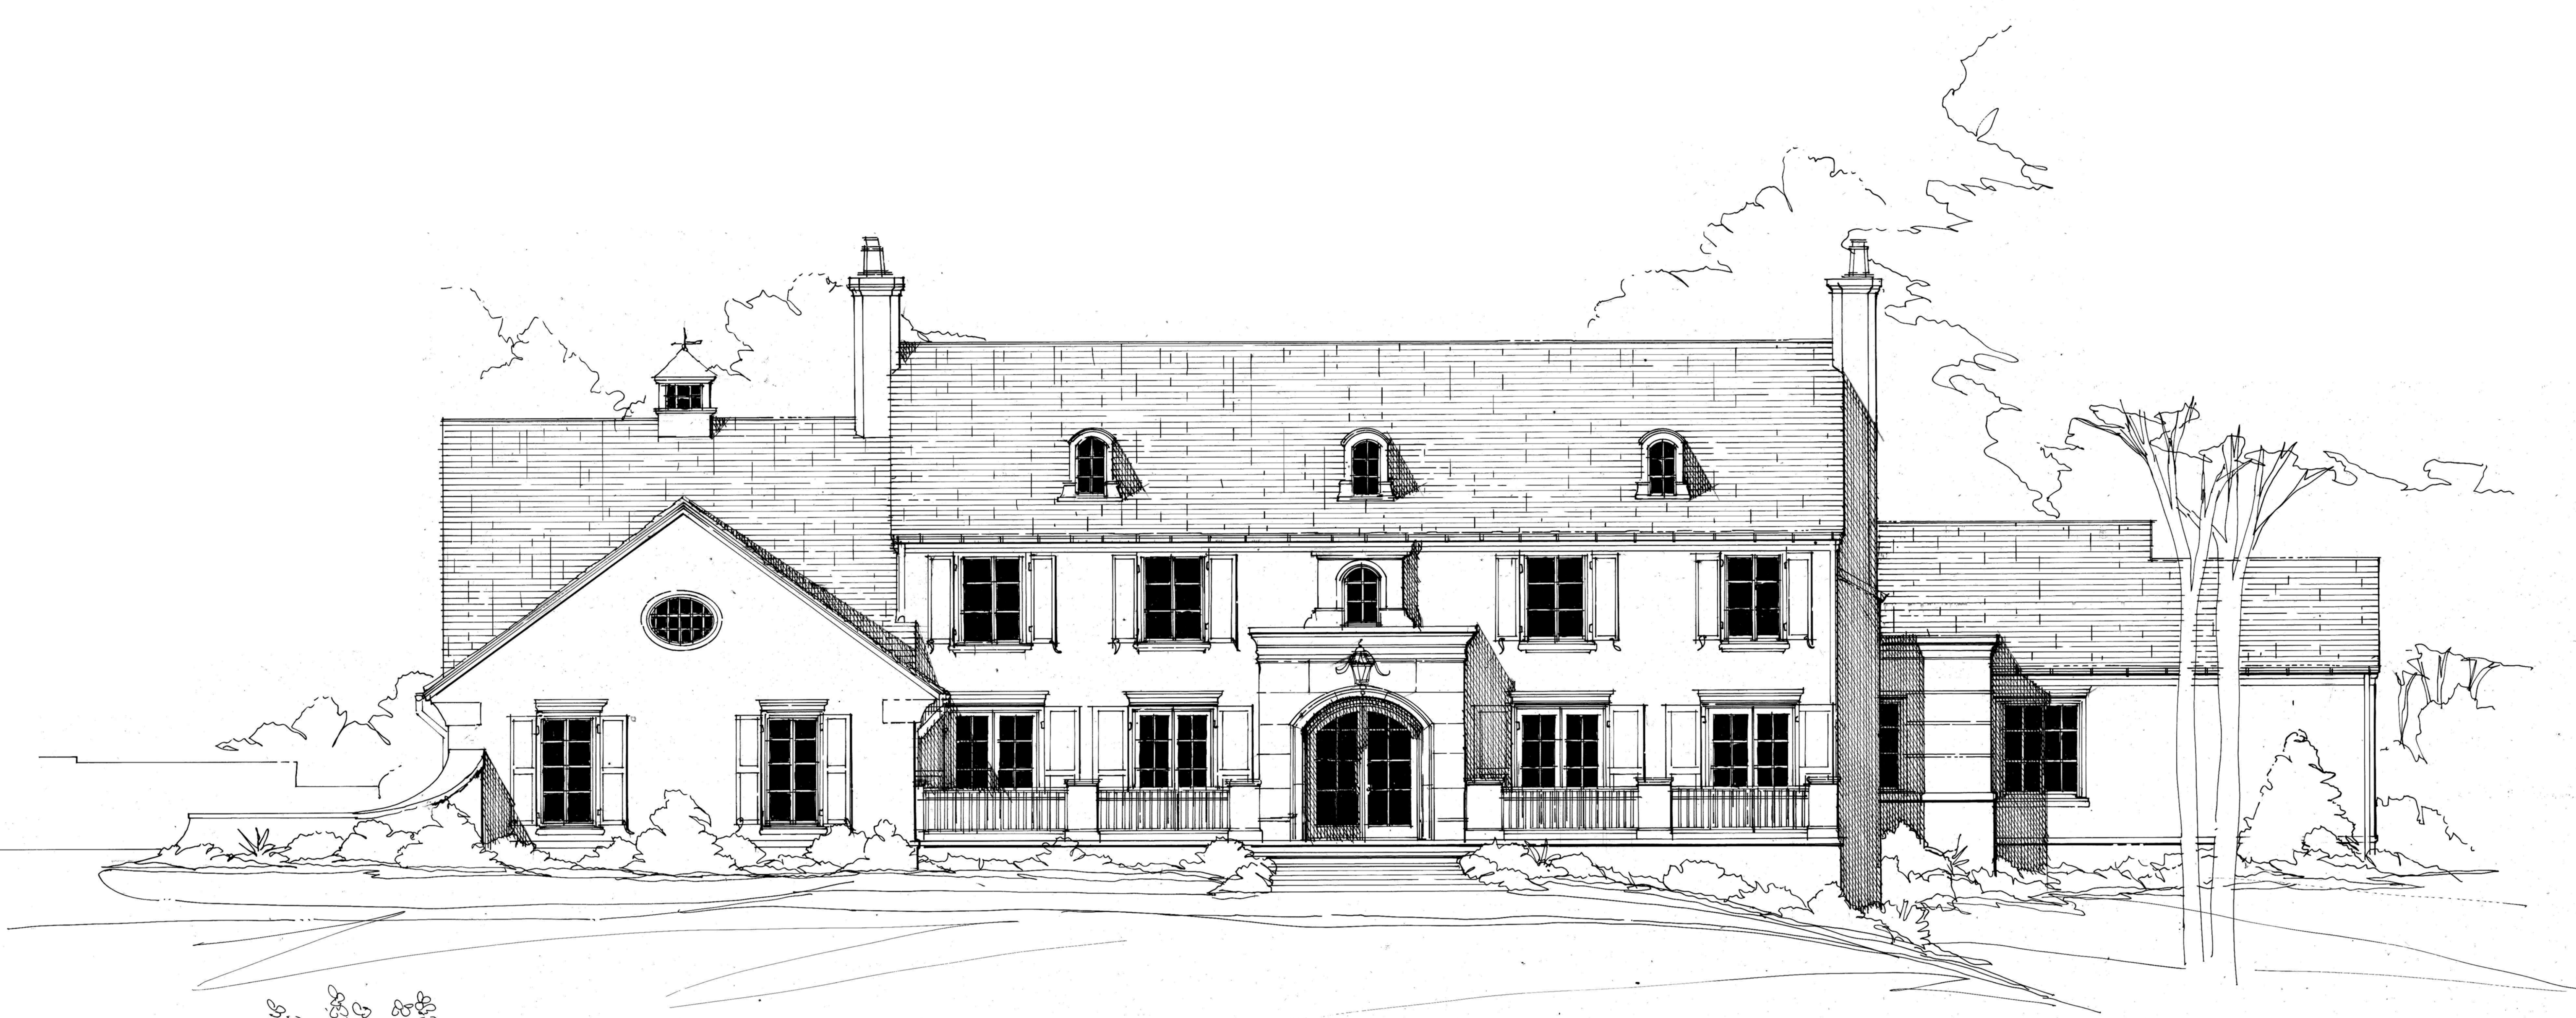


REMODELED FRONT ELEVATION RENDERING
(NORTH)

A REMODELING PROJECT
FOR
THE TOGAR RESIDENCE
3 STUYVESANT CRESCENT
BILTMORE FOREST NORTH CAROLINA

AUGUST 9, 2021

Christopher
PHELPSSM
Inspiring Homes for Life

1230 W. Morehead Street • Suite 202 • Charlotte • NC • 28208
10 Cheshire Drive • Black Mountain • NC • 28711
P: (704) 377-5569 • Christopherphelps.com

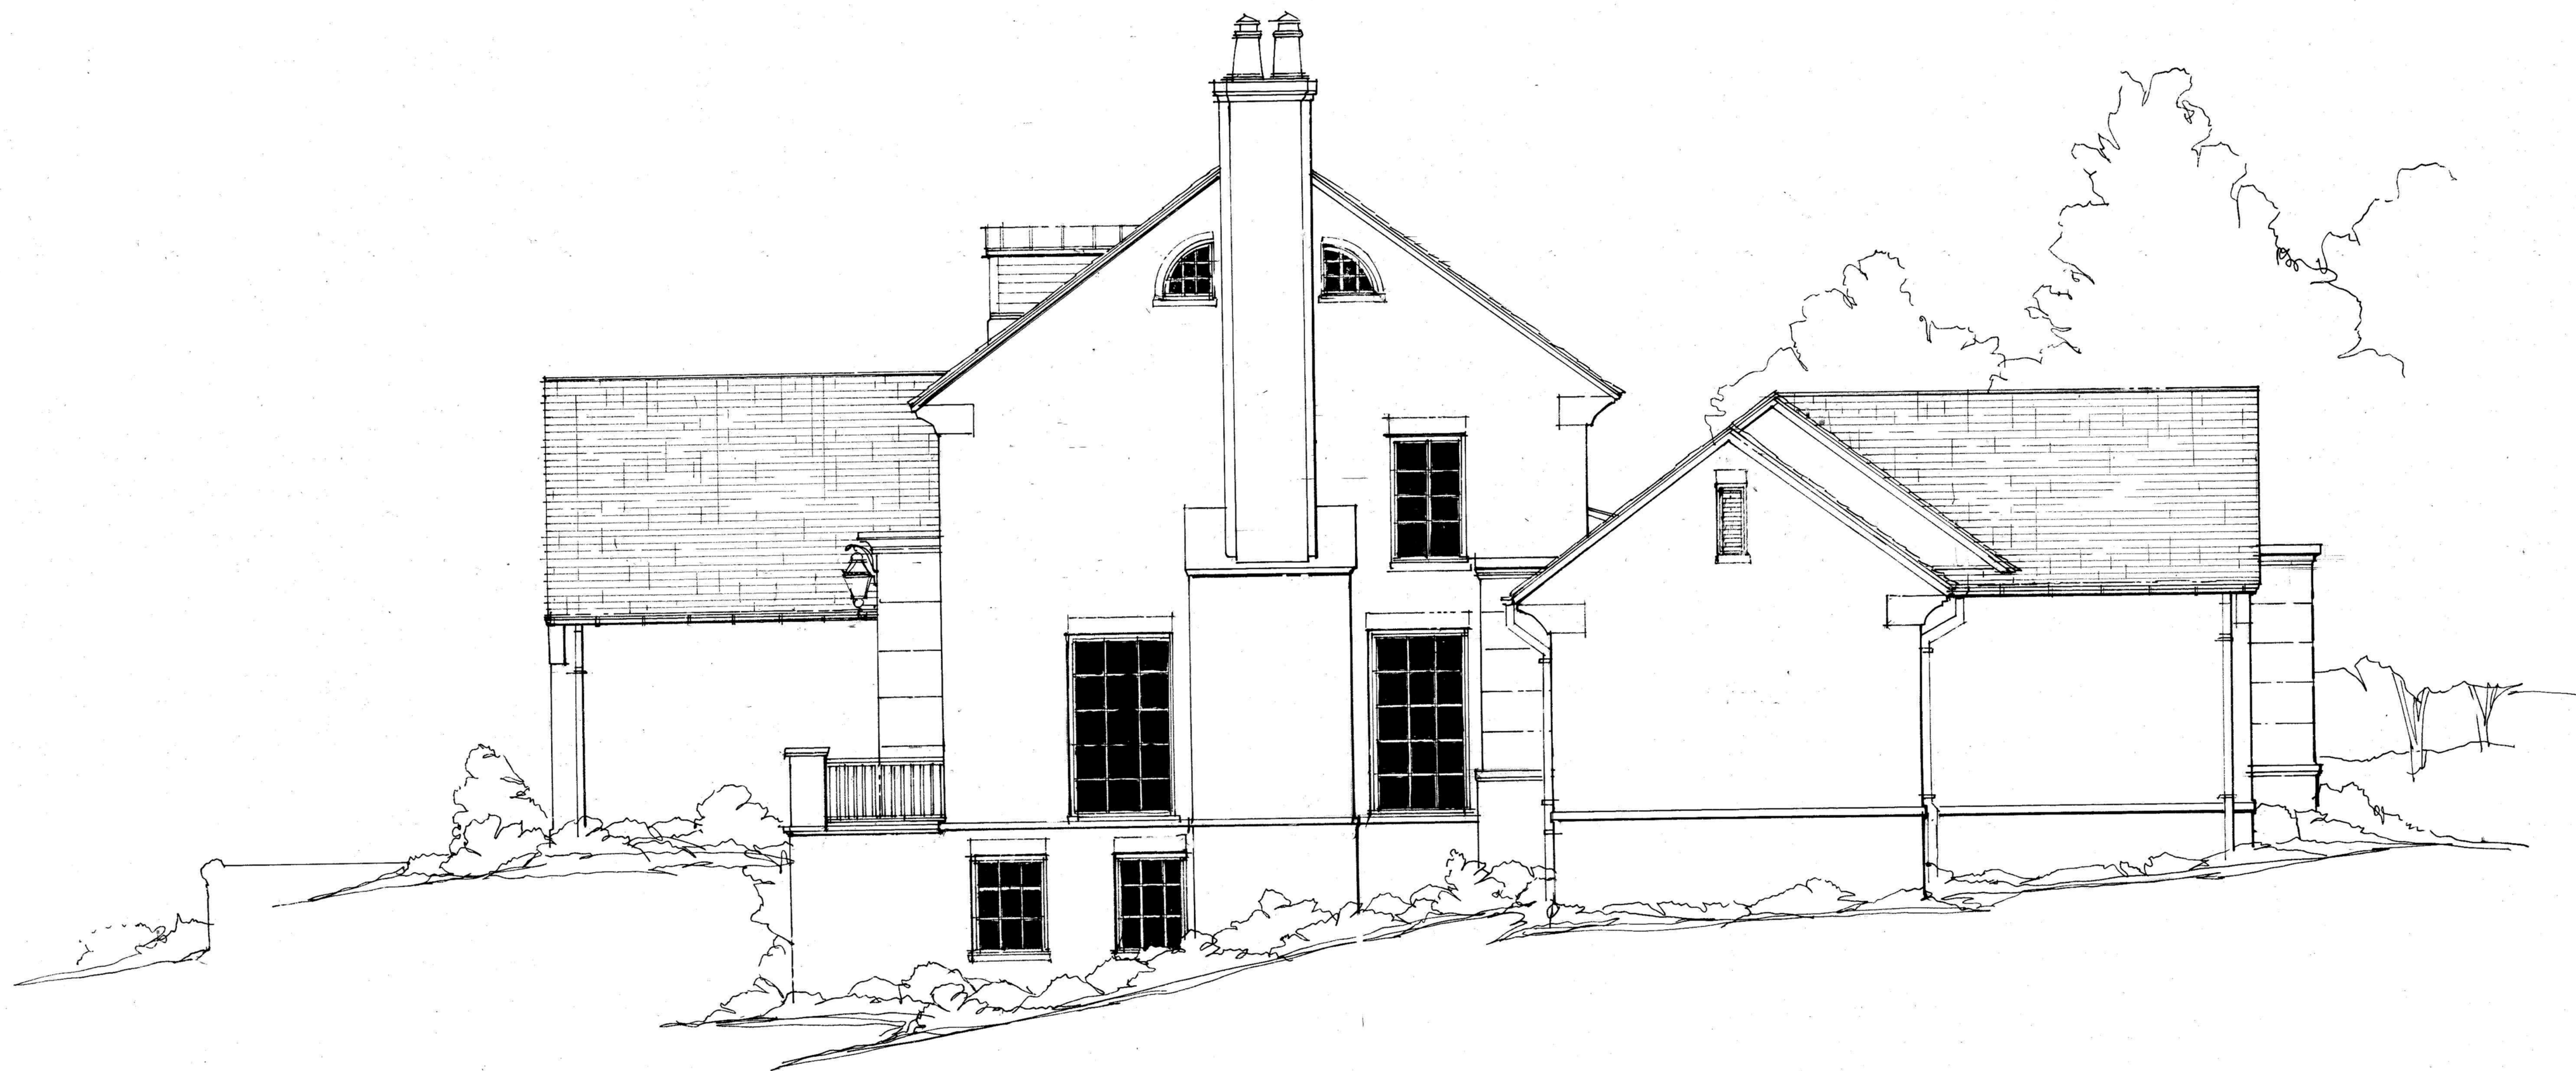


REMODELED RIGHT SIDE ELEVATION RENDERING
(WEST)

A REMODELING PROJECT
FOR
THE TOGAR RESIDENCE
3 STUYVESANT CRESCENT
BILTMORE FOREST NORTH CAROLINA

AUGUST 9, 2021

Christopher
PHELPSSM
Inspiring Homes for Life

1230 W. Morehead Street • Suite 202 • Charlotte • NC • 28208
10 Cheshire Drive • Black Mountain • NC • 28711
P: (704) 377-5569 • Christopherphelps.com

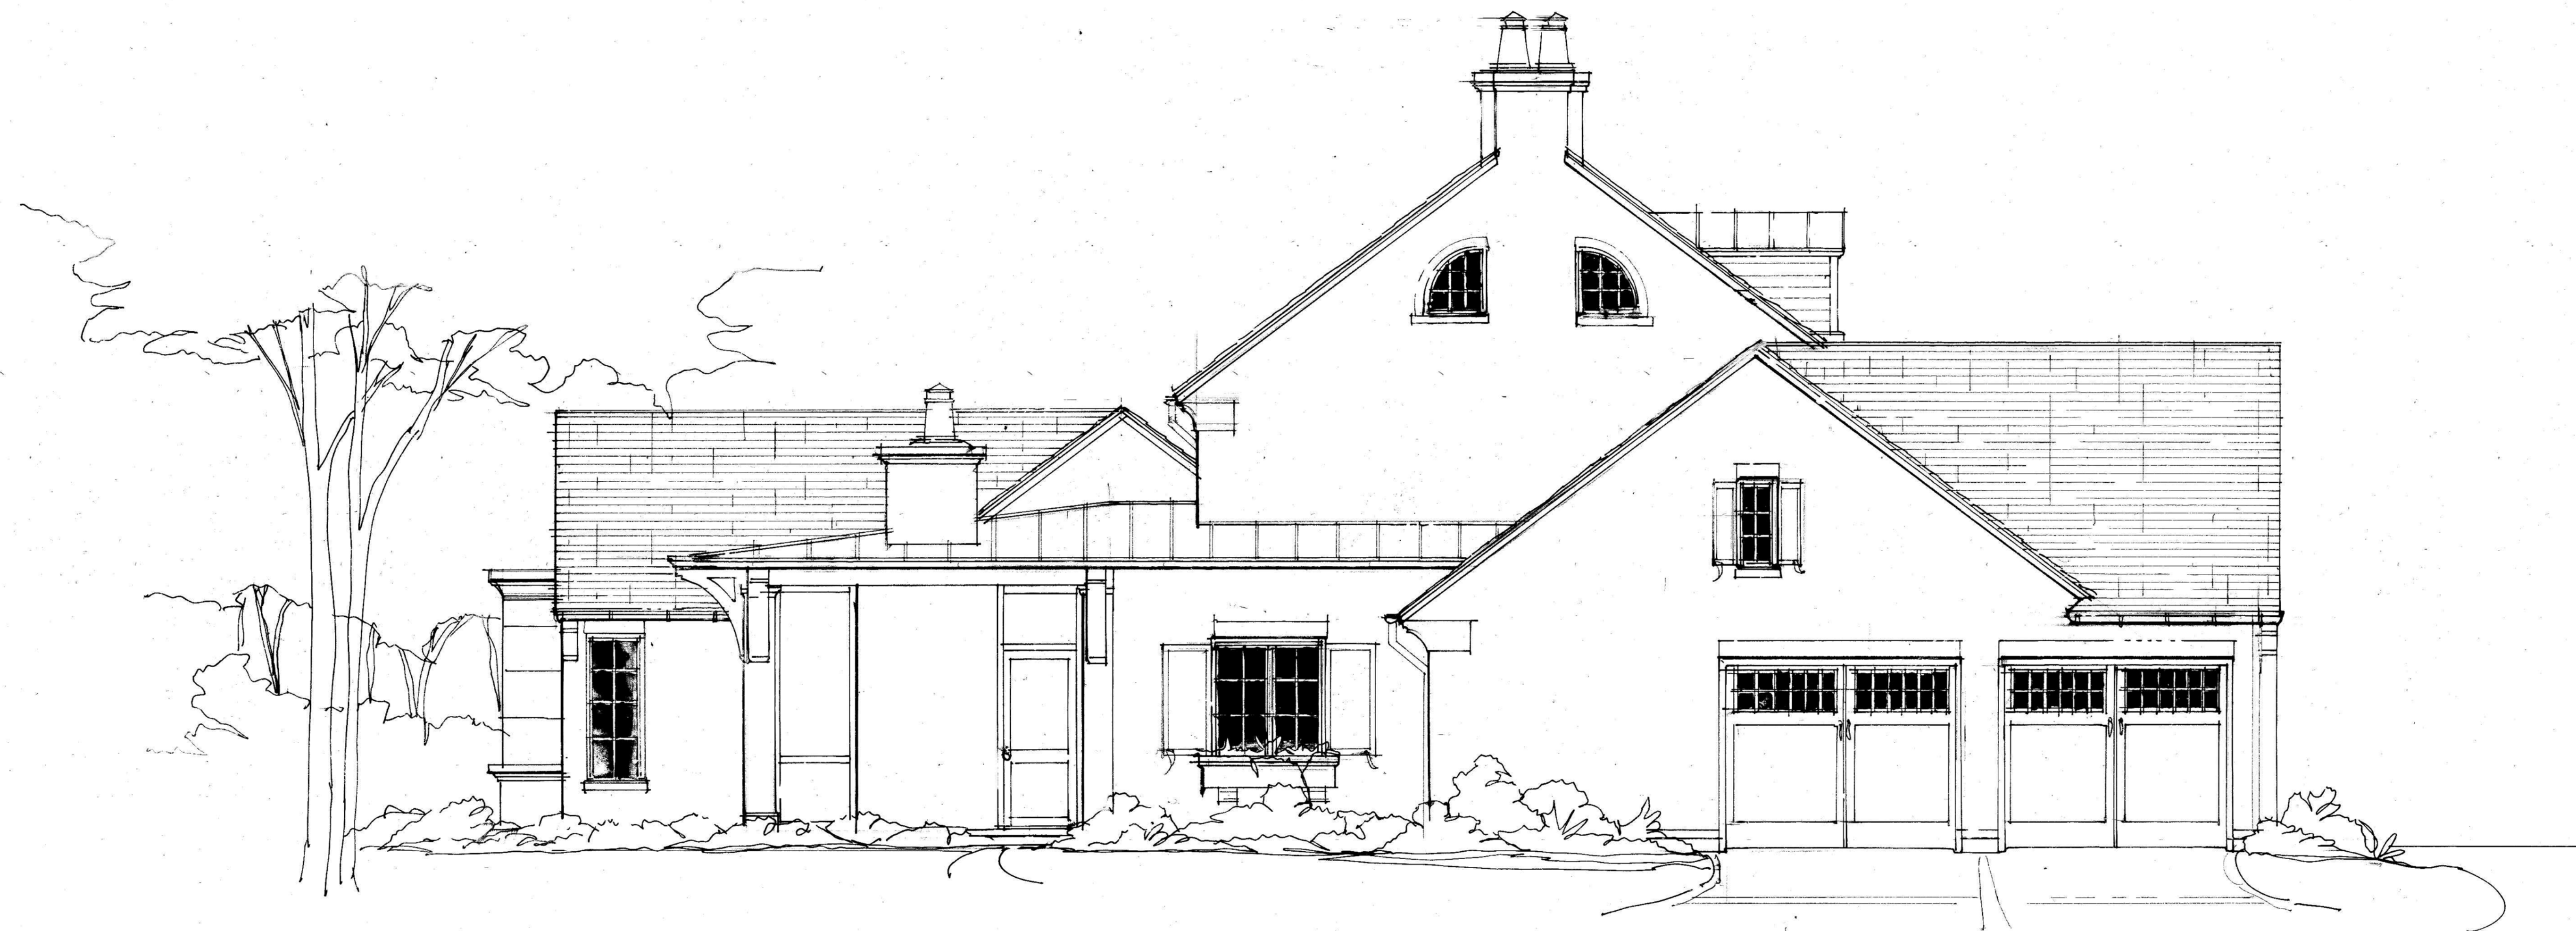


REMODELED LEFT SIDE ELEVATION RENDERING
(EAST)

A REMODELING PROJECT
FOR
THE TOGAR RESIDENCE
3 STUYVESANT CRESCENT
BILTMORE FOREST NORTH CAROLINA

AUGUST 9, 2021

Christopher
PHELPSSM
Inspiring Homes for Life

1230 W. Morehead Street • Suite 202 • Charlotte • NC • 28208
10 Cheshire Drive • Black Mountain • NC • 28711
P: (704) 377-5569 • Christopherphelps.com

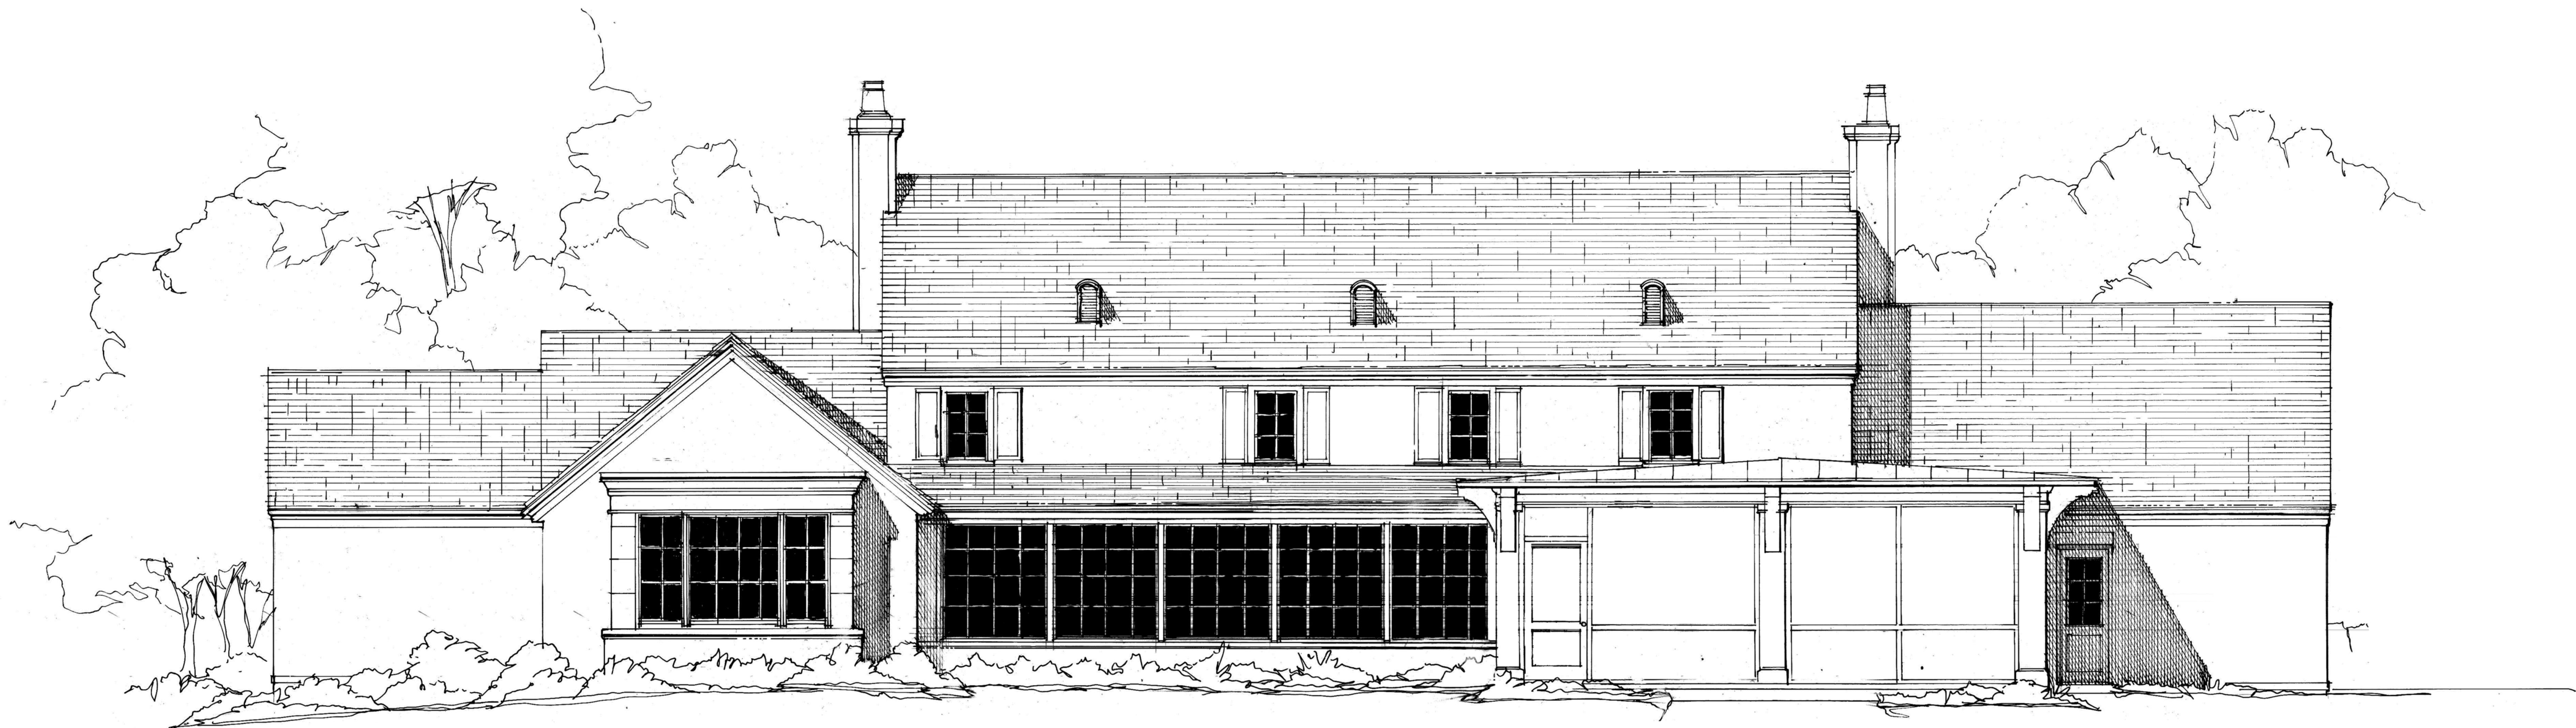

REMODELED REAR ELEVATION RENDERING
(SOUTH)

A REMODELING PROJECT
FOR
THE TOGAR RESIDENCE
3 STUYVESANT CRESCENT
BILTMORE FOREST NORTH CAROLINA

AUGUST 9, 2021

Christopher
PHELPSSM
Inspiring Homes for Life

1230 W. Morehead Street • Suite 202 • Charlotte • NC • 28208
10 Cheshire Drive • Black Mountain • NC • 28711
P: (704) 377-5569 • Christopherphelps.com

Zoning Compliance Application

Town of Biltmore Forest

Name

Derek Weilbaecher

Property Address

414 Vanderbilt Rd, Biltmore Forest, NC 28803

Phone

(404) 221-0422

Email

don@joelkelly.com

Parcel ID/PIN Number

9646-66-1233

ZONING INFORMATION

Current Zoning

R-1

Lot Size

3.01 Acres

Maximum Roof Coverage

8,200 square feet (Up to 3.5 acres)

Proposed Roof Coverage Total

8144

Maximum Impervious Surface Coverage

3-6 acres (20 percent of lot area)

Proposed Impervious Surface Coverage

17.3%

Front Yard Setback

60 feet (R-1 District)

Side Yard Setback

20 feet (R-1 District)

Rear Yard Setback

25 feet (R-1 District)

Building Height

38.5'

Description of the Proposed Project

The scope of work shall include the removal of the existing house, and construction of a new house as outlined in the attached documents.

Estimated Start Date

9/27/2021

Estimated Completion Date

10/31/2023

Estimated Cost of Project

\$7,000,000.00

Supporting Documentation (Site Plan, Drawings, Other Information)

Weilbaecher_Materials_2021-08-30.pdf

01_Weilbaecher Residence-FLA-Site Landscape Set.pdf

Weilbaecher_Zoning-architectural-set_2021-08-30.pdf

Special Use Permit Application

Town of Biltmore Forest

Name

Derek Weilbaecher

Address

414 Vanderbilt Road, Biltmore Forest, NC 28803

Phone

(404) 221-0422 x103

Email

don@joelkelly.com

Please select the type of special use you are applying for:

Accessory Structures

The applicant must show that the proposed use will not materially endanger public health or safety or injure value of adjoining or abutting property. In addition, the proposed use must be in general conformity with the plan of development of the town and be in harmony with scale, bulk, height, coverage, density, and character of the neighborhood.

Please provide a description of the proposed project:


The proposed Accessory Structure for this application is a wood burning fire pit with a gas starter. It will be surrounded by a flagstone patio of approximately 20' diameter, and partially captured by a bench-height site wall on one side, 18-22" high.

Explain why the project would not adversely affect the public interest of those living in the neighborhood:

Proposed fire pit is located in an area where it will be away from the house, not highly visible from the golf course and buffered from the adjacent property with vegetation. The fire pit surround will sit high enough to prevent hot coals and ash from leaving the enclosure. The area will function as a normal patio when not in use.

I hereby certify that all of the information set forth above is true and accurate to the best of my knowledge.

Signature

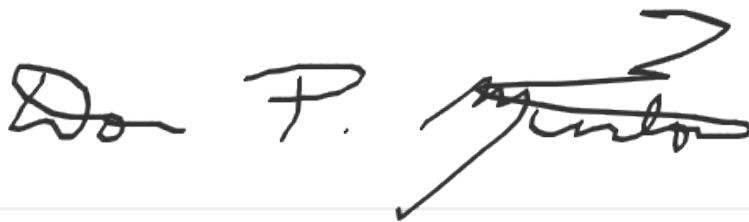Handwritten signature of Derek Weilbaecher in black ink, written over a horizontal line.

Date

9/2/2021

WEILBAECHER RESIDENCE

414 Vanderbilt Road
Biltmore Forest, NC 28803

SHEET INDEX


	EXISTING SITE SURVEY
L1.01	SITE NOTES & SPECIFICATIONS
L1.02	GROUND STABILIZATION & MATERIALS HANDLING
L1.03	SELF-INSPECTION, RECORD-KEEPING, & REPORTING
L2.01	SITE STABILIZATION & CLEARING
L3.01	SITE LAYOUT & MATERIALS
L3.02	SITE GRADING, DRAINAGE, EROSION CONTROL, & STORMWATER CONTROL
L3.03	YARD INLET & PIPE SCHEDULE
L4.01	SITE DETAILS
L4.02	SITE DETAILS
L5.01	LANDSCAPE PLAN
L6.01	LANDSCAPE SCHEDULE, NOTES, SPECS, & DETAILS
L6.02	LANDSCAPE SCHEDULE, NOTES, SPECS, & DETAILS



VICINITY MAP
NOT TO SCALE




LANDSCAPE ARCHITECTURE | CONSERVATION PLANNING | LOW IMPACT DEVELOPMENT
P.O. BOX 8013, ASHEVILLE, NC 28814 | PH: 828.243.6604 | WWW.FUSCOLA.COM
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TREE LIST

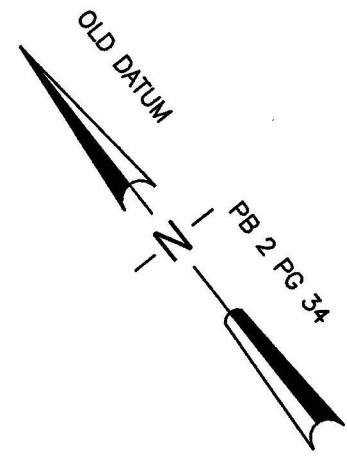PT. NO.	DESCRIPTION	PT. NO.	DESCRIPTION	PT. NO.	DESCRIPTION
12	40" CHERRY	267	36" OAK	436	16" OAK
20	18" HICKORY	272	20" CEDAR	437	40" OAK
24	18" CHESTNUT	275	14" CEDAR	441	30" OAK
32	48" OAK	374	42" OAK	459	08" CEDAR
63	10" HOLLEY	382	18" SPRUCE	460	24" PINE
64	14" BLACKGUMS	386	12" REDWOOD	464	26" OAK
67	10" HOLLEY	388	28" OAK	470	12" HEMLOCK
79	36" OAK	390	20" PINE	471	06" HEMLOCK
87	18" HICKORY	398	28" OAK	473	12" PINE
176	12" HEMLOCKS	403	20" OAK	476	12" PINE
177	10" HEMLOCKS	406	14" HEMLOCK	530	08" PINE
178	10" HEMLOCK	407	26" PINE	531	30" OAK
179	10" HEMLOCK	411	14" HEMLOCK	532	16" HEMLOCK
180	12" HEMLOCK	412	24" PINE	533	28" PINE
181	12" HEMLOCK	414	10" HEMLOCK	534	16" PINE
182	12" HEMLOCK	416	12" HEMLOCK	536	28" PINE
183	18" HEMLOCK	417	08" HEMLOCK	537	30" PINE
184	18" HEMLOCK	419	36" PINE	540	10" HICKORY
185	12" HEMLOCK	420	12" HEMLOCK	542	30" OAK
186	08" HEMLOCKS	421	12" HEMLOCK	544	24" OAK
187	20" HEMLOCK	422	16" HEMLOCK	545	12" HEMLOCK
188	12" HEMLOCK	423	26" PINE	546	08" HEMLOCK
189	14" HEMLOCK	424	28" PINE	547	14" HEMLOCK
193	36" POPLAR	425	12" HEMLOCK	548	12" HEMLOCK
207	08" HEMLOCK	426	28" PINE	549	10" HEMLOCK
209	30" POPLAR	427	24" PINE	552	10" PINE
210	16" OAK	428	08" PINE	554	12" OAK
211	24" PINE	211	14" PINE	555	12" PINE
214	12" HOLLEY	430	08" HEMLOCK	556	24" PINE
256	16" SPRUCE	431	18" PINE	558	08" PINE
257	16" SPRUCE	432	16" PINE	559	10" HEMLOCK
258	14" SPRUCE	433	10" HEMLOCK	560	26" OAK
259	18" SPRUCE	434	36" PINE	561	16" OAK
261	16" SPRUCE	435	16" HEMLOCK	567	24" POPLAR
				568	08" PINE


(26)
P.I.N. NO.
9646-66-2477.00000
DB 1898 PG 694
PB 2 PG 34



- LEGEND:
- IRON PIN SET - 5/8" REBAR
 - IRON PIN FOUND (TYPE NOTED)
 - ⊕ NAIL & CAP SET
 - ◆ NAIL & CAP FOUND
 - MAGNETIC NAIL SET
 - ⊕ STONE FOUND
 - PT NOT FOUND OR SET
 - RAILROAD SPIKE

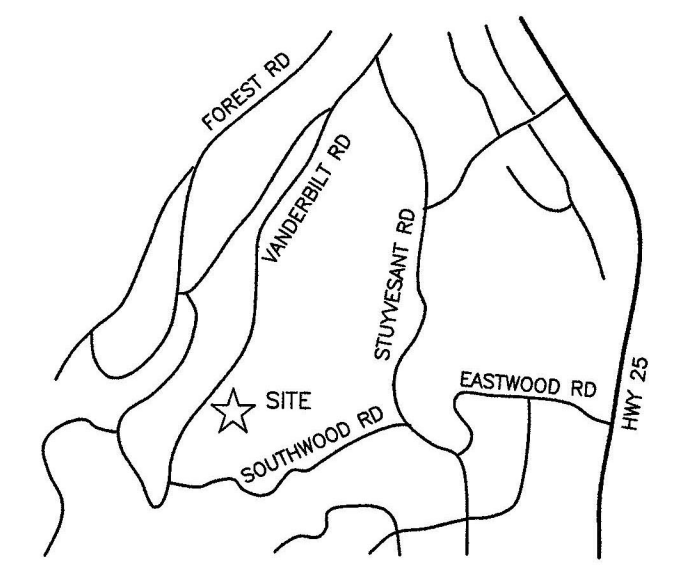CERTIFICATE OF ACCURACY
I, W.C. LINDSEY Jr. certify that this plat was drawn under my supervision from an actual survey made under my supervision, deed description recorded in Book 4947 Page 294, that the ratio of precision as calculated is 1/10000; that this plat was prepared in accordance with G.S. 47-30 as amended. Witness my original signature, registration number and seal this Seventh day of November, A.D., 2013.

W.C. Lindsey Jr.
SURVEYOR
REGISTRATION NUMBER
13646

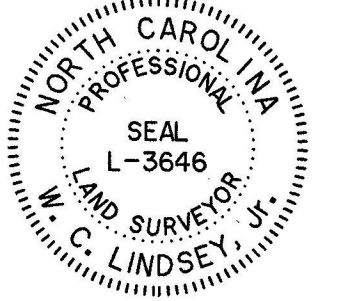

P.I.N. NO.
9646-76-2927.00000
DB 1780 PG 102
PB 9 PG 14


VANDERBILT ROAD

LOT 28 & PART OF LOT 27
P.I.N. NO.
9646-66-1233.00000
DB 4947 PG 294
PB 2 PG 34

TOPOGRAPHIC SURVEY OF
**PART OF LOT 27 & LOT 28
BILTMORE FOREST**

SURVEY FOR
JOSEPH & ASHLEY SEGRAVE


BUNCOMBE COUNTY NORTH CAROLINA

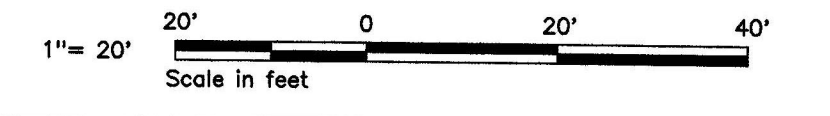

DRAWN B.M.B.	CHECK W.C.L.	DATE NOVEMBER 7, 2013	JOB NO. 5819	F.B. D/C
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LINDSEY & ASSOCIATES, INC.
P.O. BOX 9 TIGERVILLE, S.C. 29688
LAND & HYDROGRAPHIC SURVEYORS
Ph 895-1285 Fax 895-4141

(29)
P.I.N. NO.
9646-56-9097.00000
DB 1418 PG 112
PB 2 PG 34

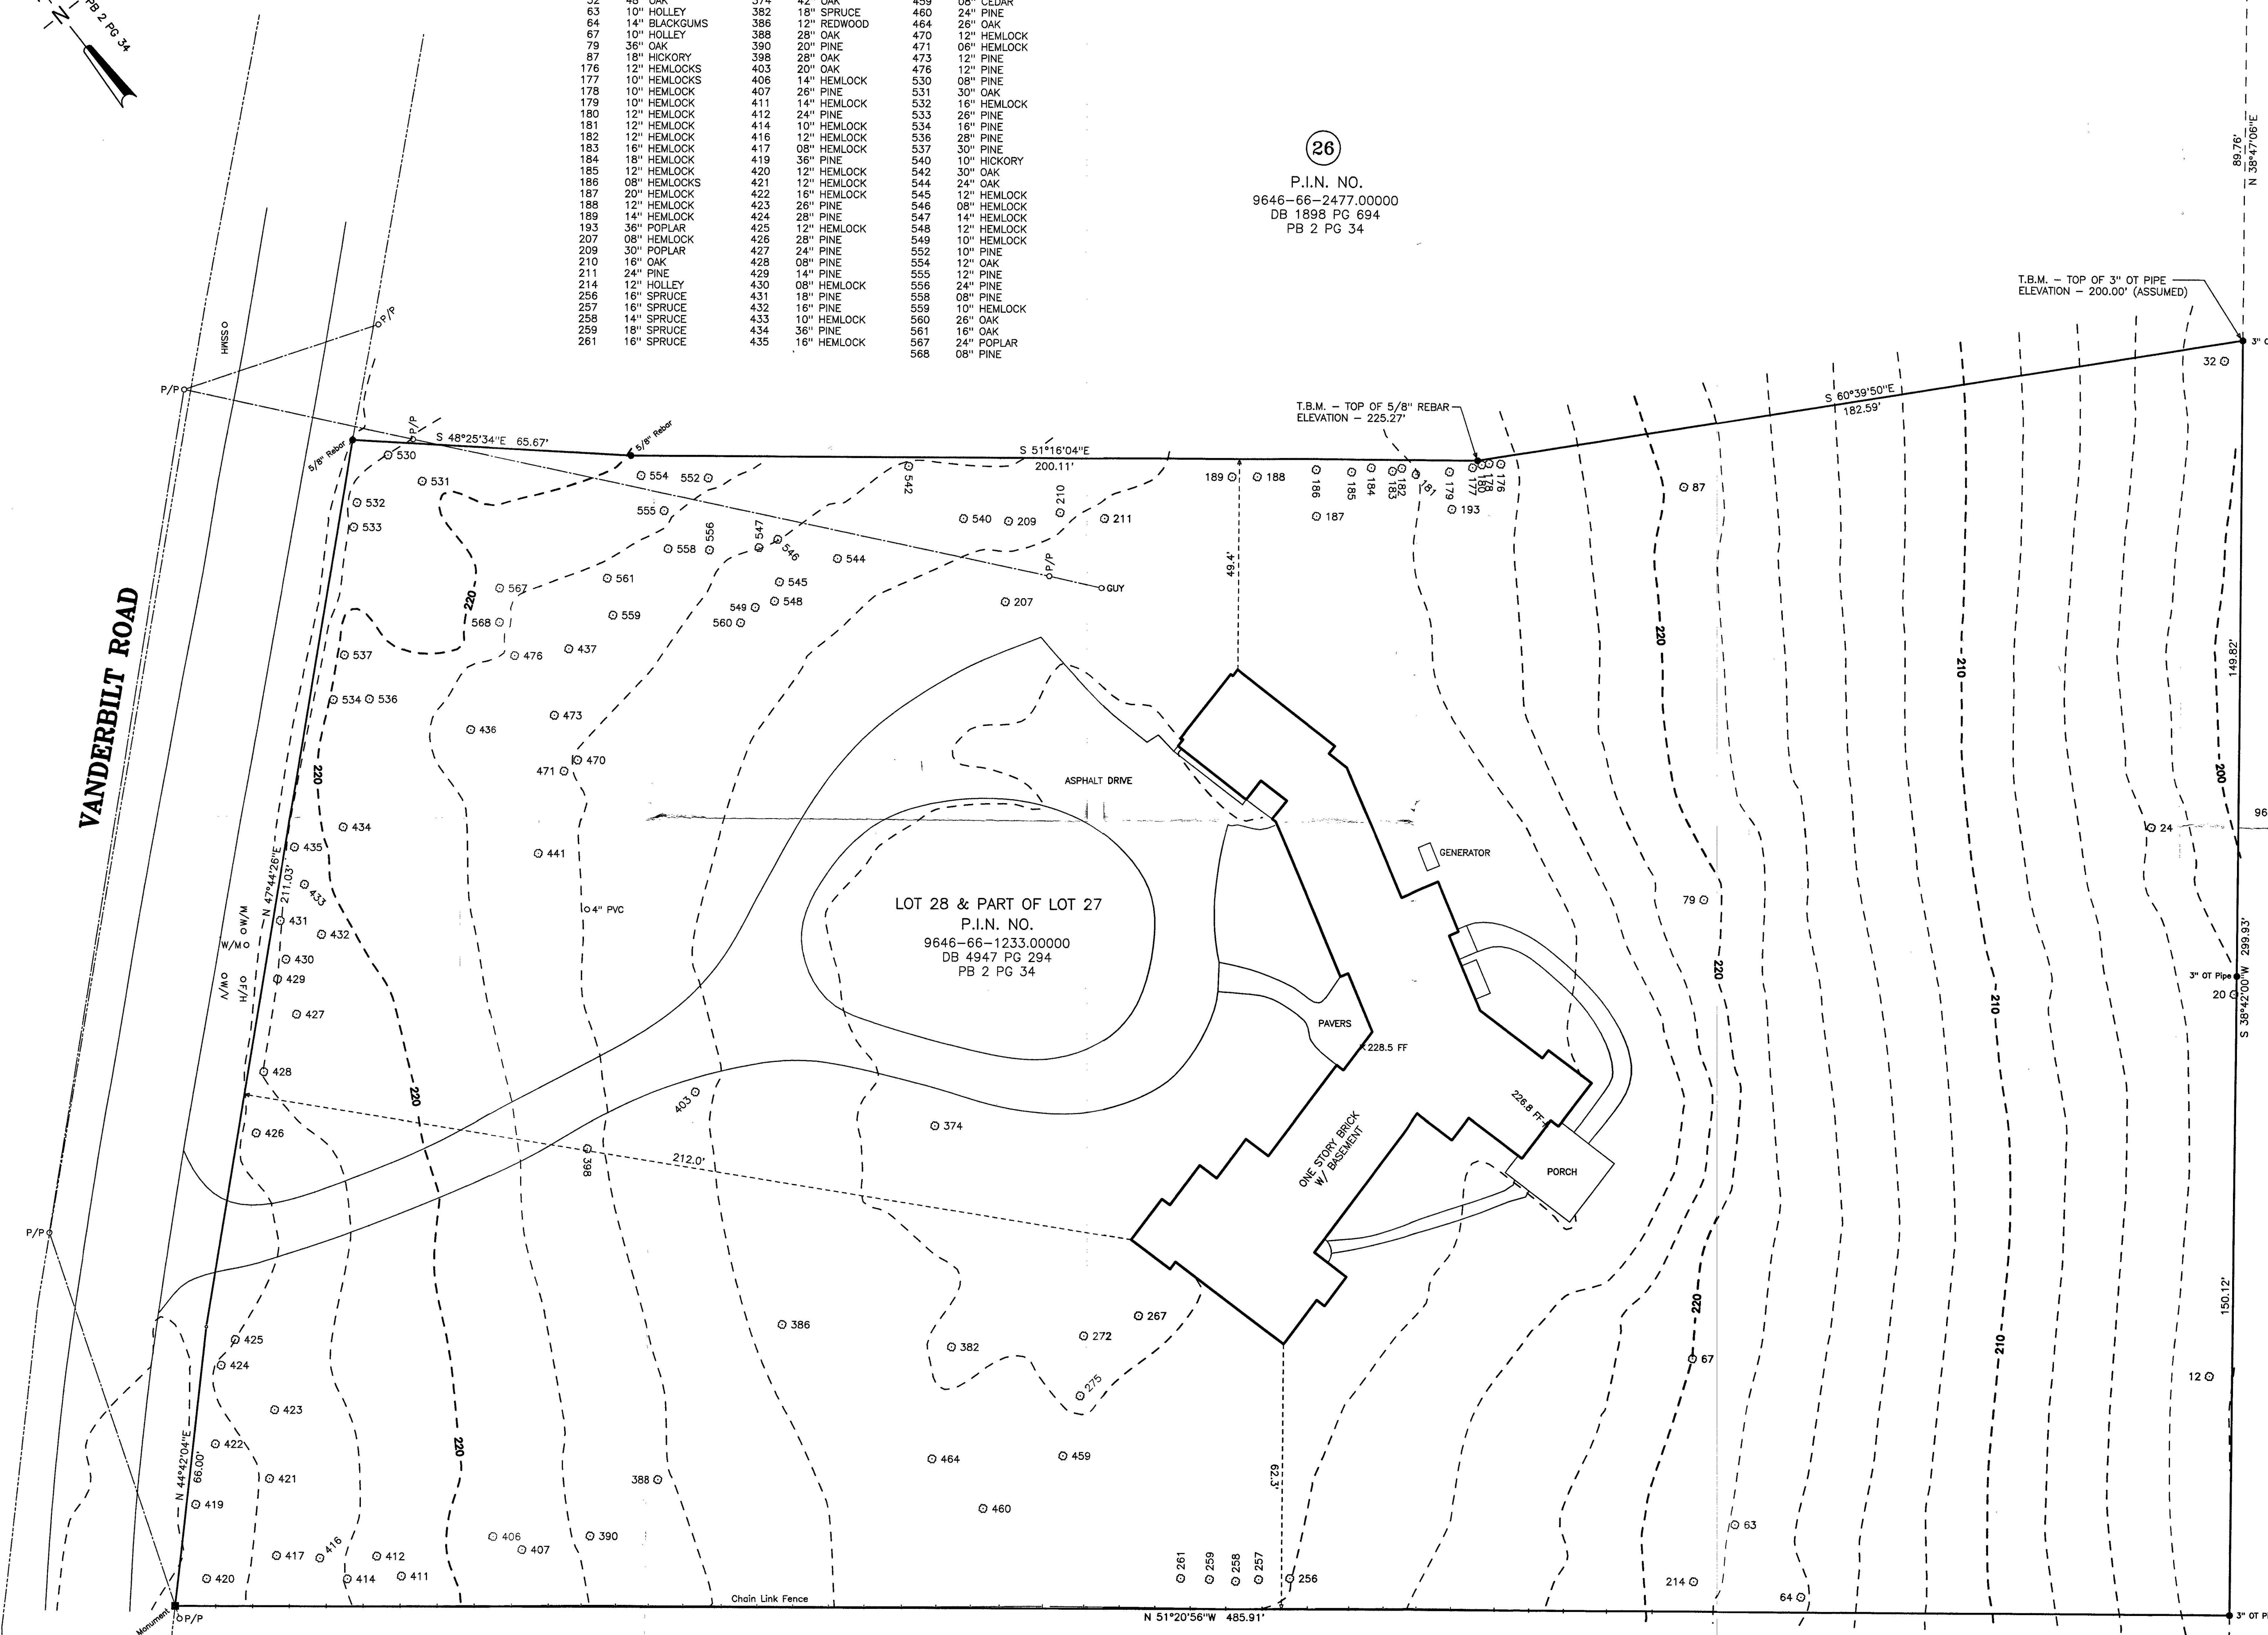

SITE PREPARATION AND DEMOLITION NOTES

- ESTABLISH, PROTECT AND MAINTAIN BENCHMARKS AND SURVEY CONTROL POINTS FROM DISTURBANCE DURING CONSTRUCTION.
- CONTRACTOR TO ENSURE ALL REQUIRED PERMITS FROM REGULATORY AND REVIEW AGENCIES HAVE BEEN OBTAINED.
- ALL PROJECT ACTIVITY SHALL BE CONFINED TO THE AREA WITHIN THE LIMITS OF DISTURBANCE.
- THERE SHALL BE NO LAY-DOWN ACTIVITIES, MATERIALS STORAGE, FOOT TRAFFIC, VEHICULAR TRAFFIC AND STORAGE OF MATERIALS OR EQUIPMENT OUTSIDE OF THE LIMITS OF DISTURBANCE.
- COORDINATE LOCATION OF CONSTRUCTION TRAILER, REST ROOM FACILITIES, PERMIT DISPLAYS AND ANY OTHER PROJECT ACCESSORIES NOT SPECIFICALLY LOCATED ON THE CONSTRUCTION DRAWINGS WITH THE OWNER.
- THE CONTRACTOR SHALL BE RESPONSIBLE FOR LOCATING AND PROTECTING EXISTING UTILITIES AND STRUCTURES UNTIL PROJECT INSTALLATION IS COMPLETE. THE CONTRACTOR SHALL REPAIR OR PAY FOR ALL DAMAGES MADE TO EXISTING FACILITIES AND STRUCTURES.
- NOTIFY OWNER IMMEDIATELY IF ANY PROPOSED OR EXISTING CONDITIONS CONFLICT WITH UTILITIES.
- INSTALL EROSION CONTROLS AS INDICATED IN THE EROSION CONTROL NOTES AND SEQUENCE OF CONSTRUCTION FOR EROSION AND SEDIMENT CONTROL.
- MARK TREES AND OTHER PLANT MATERIAL TO BE REMOVED WITH A SINGLE AND UNIQUE COLOR OF SURVEY FLAGGING AND OBTAIN APPROVAL OF OWNER OR LANDSCAPE ARCHITECT PRIOR TO PROCEEDING.
- REMOVE OBSTRUCTIONS, TREES, SHRUBS, GRASS AND OTHER VEGETATION WITHIN THE LIMITS OF DISTURBANCE TO PERMIT INSTALLATION OF NEW CONSTRUCTION UNLESS OTHERWISE NOTED. REMOVE INCLUDES DIGGING OUT STUMPS AND OBSTRUCTIONS AND GRUBBING ROOTS TO A DEPTH OF 18".
- STRIP TOPSOIL TO WHATEVER DEPTHS ARE ENCOUNTERED IN A MANNER TO PREVENT INTERMINGLING WITH UNDERLYING SUBSOIL OR OTHER WASTE MATERIALS.
- WIRES, SIGNS, PERMITS OR ANY OTHER OBJECT SHALL NOT BE FASTENED TO TREES.
- ALL CLEARING, GRUBBING, REMOVAL OF TOPSOIL OR ANY OTHER DISTURBANCE WITHIN THE DRIPLINE OF EXISTING TREES TO REMAIN SHALL BE DONE WITH HAND TOOLS UNDER THE DIRECTION OF LANDSCAPE ARCHITECT.
- REMOVE SURPLUS SOIL MATERIAL, UNSUITABLE TOPSOIL, OBSTRUCTIONS, DEMOLISHED MATERIALS, AND WASTE MATERIALS, INCLUDING TRASH AND DEBRIS, AND LEGALLY DISPOSE OF THEM OFF OWNER'S PROPERTY.

EROSION CONTROL NOTES

- CONTRACTOR IS RESPONSIBLE FOR AND SHALL ADHERE TO ALL PROVISIONS AND REQUIREMENTS OF ALL APPLICABLE EROSION CONTROL REQUIREMENTS.
- EROSION CONTROL MEASURES SHALL BE INSTALLED FOLLOWING THE EROSION CONTROL SEQUENCE.
- EROSION CONTROL MEASURES ARE GENERAL IN NATURE. CONTRACTOR IS RESPONSIBLE FOR ADDITIONAL MEASURES AS REQUIRED TO PREVENT ON- OR OFF-SITE RUNOFF AND EROSION.
- ALL INLETS SHALL HAVE TEMPORARY INLET PROTECTION INSTALLED IMMEDIATELY AFTER INLET HAS BEEN CONSTRUCTED.
- CONTRACTOR IS RESPONSIBLE FOR REGULAR INSPECTION AND MAINTENANCE OF EROSION CONTROL MEASURES TO ENSURE THAT MEASURES CONTINUOUSLY FUNCTION AS INTENDED.
- ESTABLISH PERMANENT COVER ON DISTURBED AREAS IMMEDIATELY AFTER FINAL GRADING IS COMPLETE OR IF DISTURBED AREAS ARE TO REMAIN UNALTERED FOR MORE THAN 5 CONSECUTIVE DAYS.
- REMOVE ALL TEMPORARY EROSION CONTROLS AFTER DISTURBED AREAS HAVE BEEN STABILIZED AND COMPLETED.
- CONTRACTOR IS RESPONSIBLE FOR EROSION CONTROL OF OFF-SITE BORROW PITS AND DISPOSAL AREAS.
- CONTRACTOR SHALL WATER SITE TO CONTROL DUST DURING PERIODS OF DRY WEATHER.
- EQUIPMENT UTILIZED DURING THE CONSTRUCTION ACTIVITY ON SITE MUST BE OPERATED AND MAINTAINED IN SUCH A MANNER AS TO PREVENT THE POTENTIAL OR ACTUAL POLLUTION OF THE SURFACE OR GROUND WATERS OF THE STATE. FUELS, LUBRICANTS, COOLANTS, AND HYDRAULIC FLUIDS, OR ANY OTHER PETROLEUM PRODUCTS, SHALL NOT BE DISCHARGED INTO THE GROUND OR INTO SURFACE WATERS. SPENT FLUIDS SHALL BE DISPOSED OF IN A MANNER SO AS NOT TO ENTER THE WATERS, SURFACE OR GROUND, OF THE STATE AND IN ACCORDANCE WITH APPLICABLE STATE AND FEDERAL DISPOSAL REGULATIONS. ANY SPILLED FLUIDS SHALL BE CLEANED UP TO THE EXTENT PRACTICABLE AND DISPOSED OF IN A MANNER SO AS NOT TO ALLOW THEIR ENTRY INTO THE WATERS, SURFACE OR GROUND, OF THE STATE.
- HERBICIDE, PESTICIDE AND FERTILIZER USAGE DURING THE CONSTRUCTION ACTIVITY SHALL BE CONSISTENT WITH THE FEDERAL INSECTICIDE, FUNGICIDE AND RODENTICIDE ACT AND SHALL BE IN ACCORDANCE WITH LABEL RESTRICTIONS.
- ALL WASTES COMPOSED OF BUILDING MATERIALS SHALL BE DISPOSED OF IN ACCORDANCE WITH STATE GENERAL STATUTES.

SEQUENCE OF CONSTRUCTION FOR EROSION & SEDIMENT CONTROL

- OBTAIN PLAN APPROVAL AND OTHER APPLICABLE PERMITS.
- FLAG THE LIMITS OF DISTURBANCE AND MARK THE TREES TO BE REMOVED AND OBTAIN APPROVAL PRIOR TO PROCEEDING.
- HOLD PRE-CONSTRUCTION CONFERENCE AS REQUIRED.
- INSTALL TEMPORARY SILT FENCE AND OTHER EROSION CONTROL MEASURES AS SHOWN WHERE FEASIBLE.
- UPON INSTALLATION OF EROSION CONTROL MEASURES, REQUEST ON-SITE INSPECTION AND APPROVAL AS REQUIRED.
- CLEAR AND GRUB SITE.
- BEGIN ROUGH GRADING OF SITE.
- INSTALL ALL CATCH BASINS, INLET PROTECTION, CULVERTS AND OUTLET PROTECTION AS GRADING PERMITS.
- INSTALL STONE BASE AS GRADING PERMITS.
- INSTALL TEMPORARY OR PERMANENT SEEDING OR GROUND COVER ON ALL ROUGH GRADED SLOPES.
- BEGIN FINE GRADING.
- UPON COMPLETION OF FINE GRADING, IMMEDIATELY INSTALL PERMANENT GROUND COVER.
- UPON COMPLETION OF CONSTRUCTION, STABILIZATION OF SITE, AND APPROVAL BY REVIEWING GOVERNMENT AGENCY OR DESIGN REVIEW COMMITTEE. REMOVE ALL TEMPORARY MEASURES AND COMPLETE PERMANENT GROUND COVER.

MAINTENANCE PLAN:

- ALL EROSION AND SEDIMENT CONTROL PRACTICES SHALL BE CHECKED AND MAINTAINED FOR STABILITY AND OPERATION AT OPTIMUM EFFICIENCY FOLLOWING EVERY RUNOFF-PRODUCING RAINFALL BUT IN NO CASE LESS THAN ONCE EVERY WEEK. ANY NEEDED REPAIRS WILL BE MADE IMMEDIATELY TO MAINTAIN ALL PRACTICES AS DESIGNED.
- SEDIMENT WILL BE REMOVED FROM BEHIND THE SILT FENCE WHEN IT BECOMES ABOUT 6" DEEP AT THE FENCE. THE SEDIMENT FENCE WILL BE REPAIRED AS NECESSARY TO MAINTAIN A BARRIER.
- ALL SEEDING AREAS WILL BE FERTILIZED, RESEED AS NECESSARY, AND MULCHED ACCORDING TO SPECIFICATIONS IN THE VEGETATIVE PLAN TO MAINTAIN A VIGOROUS, DENSE VEGETATIVE COVER.

GRADING NOTES

- STAKE GRADES BY A REGISTERED LAND SURVEYOR AND OBTAIN APPROVAL OF LANDSCAPE ARCHITECT OR OWNER PRIOR TO PROCEEDING.
- CONTRACTOR SHALL REVIEW PROPOSED ACTIVITIES ON-SITE WITH LANDSCAPE ARCHITECT OR OWNER PRIOR TO INSTALLATION.
- ALL PROPOSED STORM DRAIN LINES SHALL HAVE A MIN. OF 2' COVER UNLESS OTHERWISE NOTED.
- MATERIAL REMAINING FROM PROJECT EXCAVATION SHALL BE LEGALLY DISPOSED OF OFF-SITE BY THE CONTRACTOR.
- EXCAVATION LIKELY TO DISLOCATE, DAMAGE, OR IMPAIR THE STRENGTH OF EXISTING STRUCTURES SHALL BE CONDUCTED ONLY AFTER ADEQUATE PROTECTION HAS BEEN PROVIDED FOR THE EXISTING STRUCTURES. THE CONTRACTOR SHALL BE RESPONSIBLE FOR REPAIRS TO OR REPLACEMENT OF STRUCTURES DAMAGED BY PROJECT ACTIVITIES.
- MATCH EXISTING GRADES SMOOTHLY WHERE PROPOSED FEATURES MEET EXISTING FEATURES.
- THE CONTRACTOR SHALL ENSURE POSITIVE DRAINAGE AT A MINIMUM OF 2% SLOPE AWAY FROM ALL BUILDINGS.
- ALL CUT SLOPES GREATER THAN 2:1 & FILL SLOPES GREATER THAN 1.5:1 SHALL BE CERTIFIED BY A REGISTERED GEOTECHNICAL ENGINEER PRIOR TO AND DURING CONSTRUCTION.
- ALL PVC SLEEVES TO BE SCHEDULE 80. COORDINATE WITH LANDSCAPE ARCHITECT FOR NUMBER AND LOCATION, EVEN IF SHOWN ON THE PLAN.
- ABBREVIATIONS

TW:	ELEVATION AT TOP OF WALL	TC:	ELEVATION AT TOP OF CURB
BW:	FINISHED GRADE ELEVATION AT BOTTOM OF WALL	BC:	ELEVATION AT BOTTOM OF CURB
SWCP:	SMOOTH WALL CORRUGATED PLASTIC PIPE	TS:	ELEVATION AT TOP OF STEPS
RIM:	FINISHED ELEVATION AT RIM INLET OF DRAINAGE STRUCTURES	BS:	ELEVATION AT BOTTOM OF STEPS
INV:	PIPE INVERT	MIN:	MINIMUM
TYP:	TYPICAL	MAX:	MAXIMUM
- PRUNE TREE ROOTS EXPOSED DURING GRADE LOWERING. DO NOT CUT MAIN LATERAL ROOTS OR TAP ROOTS; CUT ONLY SMALLER ROOTS. CUT ROOTS WITH SHARP PRUNING INSTRUMENTS; DO NOT BREAK OR CHOP.
- WHERE EXISTING GRADE IS 6 INCHES OR LESS BELOW ELEVATION OF FINISH GRADE, FILL WITH TOPSOIL. PLACE TOPSOIL IN A SINGLE UNCOMPACTED LAYER, HAND GRADE AND LIGHTLY TAMP TO REQUIRED FINISH ELEVATIONS.
- PROVIDE BORROW SOIL MATERIALS WHEN SUFFICIENT SATISFACTORY SOIL MATERIALS ARE NOT AVAILABLE.
- SATISFACTORY SOILS SHALL BE DEFINED AS FOLLOWS: ASTM D 2487 SOIL CLASSIFICATION GROUPS SC, ML, CL, SP, GM AND SM OR A COMBINATION OF THESE GROUP SYMBOLS; FREE OF ROCK OR GRAVEL LARGER THAN 3" IN ANY DIMENSION, DEBRIS, WASTE, FROZEN MATERIALS, VEGETATION, AND OTHER DELETERIOUS MATTER.
- UNSATISFACTORY SOILS SHALL BE DEFINED AS FOLLOWS: ASTM D 2487 SOIL CLASSIFICATION GROUPS GC, GW, GP, MH, CH, CL, OH, SW AND PT OR A COMBINATION OF THESE GROUP SYMBOLS.
- UNSATISFACTORY SOILS ALSO INCLUDE SATISFACTORY SOILS NOT MAINTAINED WITHIN 2 PERCENT OF OPTIMUM MOISTURE CONTENT AT TIME OF COMPACTION.
- BACKFILL AND FILL SHALL BE SATISFACTORY SOILS.
- SUBMIT MATERIAL TEST REPORTS FROM A QUALIFIED TESTING AGENCY INDICATING AND INTERPRETING TEST RESULTS FOR COMPLIANCE WITH THE FOLLOWING REQUIREMENTS:
 - CLASSIFICATION ACCORDING TO ASTM D 2487 OF EACH ON-SITE OR BORROW SOIL MATERIAL PROPOSED FOR FILL AND BACKFILL
 - LABORATORY COMPACTION CURVE ACCORDING TO ASTM D 698 FOR EACH ON-SITE OR BORROW SOIL MATERIAL PROPOSED FOR FILL AND BACKFILL.
- GEOTECHNICAL TESTING AGENCY QUALIFICATIONS: AN INDEPENDENT TESTING AGENCY QUALIFIED ACCORDING TO ASTM 329 TO CONDUCT SOIL MATERIALS AND ROCK-DEFINITION TESTING, AS DOCUMENTED ACCORDING TO ASTM D 3740 AND ASTM E 548.
- NOTIFY AND OBTAIN APPROVAL FROM LANDSCAPE ARCHITECT PRIOR TO PROCEEDING WHEN EXCAVATIONS HAVE REACHED REQUIRED SUBGRADE.
- PROOF ROLL SUBGRADE WITH SUITABLE EQUIPMENT TO IDENTIFY SOFT POCKETS AND AREAS OF EXCESS YIELDING. DO NOT PROOF ROLL WET OR SATURATED SUBGRADES.
- RECONSTRUCT SUBGRADES DAMAGED BY FREEZING TEMPERATURES, FROST, RAIN, ACCUMULATED WATER, OR CONSTRUCTION ACTIVITIES AS DIRECTED BY GEOTECHNICAL ENGINEER.
- PLACE AND COMPACT BACKFILL IN EXCAVATIONS PROMPTLY BUT NOT BEFORE REMOVING TRASH AND DEBRIS.
- WHEN INSTALLING FILL:
 - REMOVE VEGETATION, TOPSOIL, DEBRIS, UNSATISFACTORY SOIL MATERIALS, OBSTRUCTION, AND DELETERIOUS MATERIALS FROM GROUND SURFACE BEFORE PLACING FILLS
 - PLOW, SCARIFY, BENCH OR BREAK UP SLOPED SURFACES STEEPER THAN 4:1 SO FILL MATERIAL WILL BOND WITH EXISTING MATERIAL.
 - PLACE AND COMPACT FILL MATERIAL IN LAYERS TO REQUIRED ELEVATIONS AND COMPACTION.
- UNIFORMLY MOISTEN OR AERATE SUBGRADE AND EACH SUBSEQUENT FILL OR BACKFILL LAYER BEFORE COMPACTION TO WITHIN 2% OF OPTIMUM MOISTURE CONTENT.
- DO NOT PLACE BACKFILL OR FILL ON SURFACES THAT ARE MUDDY, FROZEN, OR CONTAIN FROST OR ICE.
- REMOVE, REPLACE, OR SCARIFY OR AIR-DRY, OTHERWISE SATISFACTORY SOIL MATERIAL THAT EXCEEDS OPTIMUM MOISTURE CONTENT BY 2% AND IS TOO WET TO COMPACTION TO SPECIFIED DRY UNIT WEIGHT.
- PLACE BACKFILL AND FILL MATERIALS IN LAYERS NOT MORE THAN 8" IN LOOSE DEPTH FOR MATERIAL COMPACTED BY HEAVY COMPACTION EQUIPMENT, AND NOT MORE THAN 4" IN LOOSE DEPTH FOR MATERIAL COMPACTED BY HAND-OPERATED TAMPERS.
- PLACE BACKFILL AND FILL MATERIALS EVENLY ON ALL SIDES OF STRUCTURES TO REQUIRED ELEVATIONS, AND UNIFORMLY ALONG THE FULL LENGTH OF EACH STRUCTURE.
- COMPACT SOIL TO NOT LESS THAN THE FOLLOWING PERCENTAGES OF MAXIMUM DRY UNIT WEIGHT ACCORDING TO ASTM D 698:
 - UNDER STRUCTURES AND PAVEMENTS, COMPACT TOP 12" OF EXISTING SUBGRADE AND EACH LAYER OF BACKFILL OR FILL MATERIAL AT 98%
 - UNDER UNPAVED AREAS, COMPACT TOP 6" BELOW SUBGRADE AND COMPACT EACH LAYER OF BACKFILL OR FILL MATERIAL AT 85%.
- FINISH SUBGRADES TO REQUIRED ELEVATIONS WITHIN THE FOLLOWING TOLERANCES:
 - LAWN OR UNPAVED AREAS: PLUS OR MINUS 1"
 - PAVEMENTS: PLUS OR MINUS 1/10"
- CONTRACTOR WILL ENGAGE A QUALIFIED INDEPENDENT GEOTECHNICAL ENGINEERING TESTING AGENCY TO PERFORM FIELD QUALITY-CONTROL TESTING. SUBMIT TEST REPORTS TO LANDSCAPE ARCHITECT OR OWNER.
- ALLOW TESTING AGENCY TO INSPECT AND TEST SUBGRADES AND EACH FILL AND BACKFILL LAYER. PROCEED WITH SUBSEQUENT EARTHWORK ONLY AFTER TEST RESULTS FOR PREVIOUSLY COMPLETED WORK COMPLY WITH REQUIREMENTS.
- TESTING AGENCY WILL TEST COMPACTION OF SOILS IN PLACE ACCORDING TO ASTM D 1556, ASTM D 2167, ASTM D 2922, AND ASTM D 2937 AS APPLICABLE.
- WHEN TESTING AGENCY REPORTS THAT SUBGRADES, FILLS, OR BACKFILLS HAVE NOT ACHIEVED DEGREE OF COMPACTION SPECIFIED, SCARIFY AND MOISTEN OR AERATE, OR REMOVE AND REPLACE SOIL TO DEPTH REQUIRED, RECOMPACT AND RETEST UNTIL SPECIFIED COMPACTION IS OBTAINED.
- PREVENT WATER AND SUBSURFACE OR GROUND WATER FROM ENTERING EXCAVATIONS, FROM PONDING ON PREPARED SUBGRADES EXCAVATE UTILITY TRENCHES TO INDICATED SLOPES, LINES DEPTHS AND INVERT ELEVATIONS OF UNIFORM WIDTHS TO PROVIDE A MAXIMUM 12 INCHES OF WORKING CLEARANCE ON EACH SIDE OF PIPE OR CONDUIT. EXCAVATE TRENCH WALLS VERTICALLY FROM TRENCH BOTTOM TO 12 INCHES HIGHER THAN THE TOP OF PIPE OR CONDUIT.

GRADING NOTES CONT.

- EXCAVATE AND SHAPE TRENCH SUBGRADE TO PROVIDE UNIFORM BEARING AND CONTINUOUS SUPPORT FOR PIPE AND CONDUIT. WHERE ENCOUNTERING ROCK OR OTHER UNYIELDING BEARING SURFACE, CARRY TRENCH EXCAVATION 6 INCHES BELOW INVERT ELEVATION TO RECEIVE BEDDING COURSE.
- FILL UNAUTHORIZED EXCAVATION UNDER FOUNDATIONS OR WALL FOOTINGS BY EXTENDING INDICATED BOTTOM ELEVATION OF CONCRETE FOUNDATION OR FOOTING TO EXCAVATION BOTTOM, WITHOUT ALTERING REQUIRED TOP ELEVATION. FILL UNAUTHORIZED EXCAVATIONS UNDER CONSTRUCTION AS DIRECTED BY GEOTECHNICAL ENGINEER.
- UTILITY TRENCH BACKFILL: PLACE, COMPACT AND SHAPE BEDDING COURSE TO PROVIDE CONTINUOUS SUPPORT FOR PIPES AND CONDUITS OVER ROCK AND OTHER UNYIELDING BEARING SURFACES AND TO FILL UNAUTHORIZED EXCAVATIONS.
- INSTALL UNDERGROUND UTILITY WARNING TAPE DIRECTLY ABOVE UTILITIES, 12 INCHES BELOW FINISHED GRADE AND IN THE SAME TRENCH FOR OPEN AREAS. INSTALL 6 INCHES BELOW SUBGRADE UNDER PAVEMENTS AND SLABS OR AS REQUIRED.
- FOUNDATION DRAINS TO BE INSTALLED INDEPENDENT OF ANY OTHER DRAINS SHOWN ON SITE PLAN.


LAYOUT AND MATERIALS NOTES

- DO NOT SCALE FROM DRAWINGS.
- OBTAIN DIGITAL CAD FILES FROM LANDSCAPE ARCHITECT FOR STAKING BY REGISTERED LAND SURVEYOR.
- CONTRACTOR TO HAVE A REGISTERED LAND SURVEYOR STAKE SITE ELEMENTS. OBTAIN APPROVAL BY LANDSCAPE ARCHITECT PRIOR TO PROCEEDING.
- ALL DIMENSIONS ARE TO FACE OF WALL, FACE OF CURB OR EDGE OF PAVING UNLESS OTHERWISE NOTED.
- CONTACT LANDSCAPE ARCHITECT IMMEDIATELY IF LAYOUT CONFLICTS OR AMBIGUITIES ARISE.
- STORE AND PROTECT MATERIALS PER MANUFACTURER'S RECOMMENDATIONS.
- CONTRACTOR WILL ENGAGE A QUALIFIED INDEPENDENT GEOTECHNICAL ENGINEERING TESTING AGENCY TO PERFORM FIELD QUALITY-CONTROL TESTING ON MATERIALS AND INSTALLATION WHERE SPECIFIED.
- PROVIDE TEST RESULTS FOR COMPACTION OF AGGREGATE BASE COURSE IN ACCORDANCE WITH ASTM D 1556 OR ASTM D 2167 WHICHEVER IS MOST APPLICABLE.
- CONCRETE FORMS SHALL BE STEEL, WOOD OR OTHER SUITABLE MATERIAL OF SIZE AND STRENGTH TO RESIST MOVEMENT DURING CONCRETE PLACEMENT AND TO RETAIN HORIZONTAL AND VERTICAL ALIGNMENT UNTIL REMOVAL. USE FLEXIBLE SPRING STEEL FORMS OR LAMINATED BOARDS TO FORM RADIUS BENDS AS REQUIRED.
- DO NOT BUILD ON FROZEN SUBGRADE OR SETTING BEDS. REMOVE AND REPLACE MASONRY WORK DAMAGED BY FROST OR FREEZING.
- HVAC UNITS, PROPANE TANKS, GENERATORS, OR OTHER UTILITY STRUCTURES MAY OR MAY NOT BE SHOWN ON SITE PLAN. CONTRACTOR SHALL COORDINATE LOCATION OF THESE UNITS WITH LANDSCAPE ARCHITECT AND HVAC CONTRACTOR INCOORDINATION WITH ARCHITECT OR BUILDING DESIGNER.

TEMPORARY SEEDING SCHEDULE																					
FALL	<table border="1" style="width: 100%; border-collapse: collapse;"> <tr> <th style="text-align: left;">Seeding mixture:</th> <th style="text-align: left;">RATE (lb/acre)</th> </tr> <tr> <td>Species</td> <td></td> </tr> <tr> <td>Rye (grain)</td> <td>120</td> </tr> <tr> <th style="text-align: left;">Seeding dates:</th> <td></td> </tr> <tr> <td>Mountains:</td> <td>Aug. 15 - Dec. 15</td> </tr> <tr> <td>Coastal Plain & Piedmont:</td> <td>Aug. 15 - Dec. 30</td> </tr> </table>	Seeding mixture:	RATE (lb/acre)	Species		Rye (grain)	120	Seeding dates:		Mountains:	Aug. 15 - Dec. 15	Coastal Plain & Piedmont:	Aug. 15 - Dec. 30								
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Coastal Plain:	April 15 - Aug 15																				
Soil Amendments: Follow recommendation of soil tests or apply 2,000 lb/acre ground agricultural limestone and 750 lb/acre 10-10-10 fertilizer. For Fall applications modify 10-10-10 fertilizer to 1000 lb/acre.																					
Mulch: Apply 4,000 lb/acre straw. Anchor straw by tacking with asphalt, netting, or a mulch anchoring tool. A disk with blades set nearly straight can be used as a mulch anchoring tool.																					
Maintenance: Refertilize if growth is not fully adequate. Reseed, referertilize, and mulch immediately following erosion or other damage.																					

PERMANENT SEEDING SCHEDULE (GRASSED AREAS FROM 3:1 TO 2:1 SLOPE)							
Seeding mixture: Species Tall Fescue (KY-31) Andropogon tenuis - Splitbeard Bluestem Chamaecrista fasciculata - Partridge Pea Redtop Kentucky Bluegrass	<table border="1" style="width: 100%; border-collapse: collapse;"> <tr> <th style="text-align: left;">Rate (lb/acre)</th> </tr> <tr> <td>100</td> </tr> <tr> <td>20</td> </tr> <tr> <td>10</td> </tr> <tr> <td>5</td> </tr> <tr> <td>5</td> </tr> </table>	Rate (lb/acre)	100	20	10	5	5
Rate (lb/acre)							
100							
20							
10							
5							
5							
Nurse plants: Between May 1 and Aug. 15 add 10 lb/acre German millet or 15 lb/acre Sudangrass. Prior to May 1 or Aug. 15, add 40 lb/acre rye (grain).							
Seeding dates: Below 2500 ft: Aug. 15 - Sept. 1 Above 2500 ft: July 25 - Aug. 15 Complete seeding earlier in fall and start later in spring on north- and east-facing slopes.							
Soil Amendments: Apply lime and fertilizer according to soil tests or apply 4,000 lb/acre ground agricultural limestone and 1,000 lb/acre 5-10-10 fertilizer.							
Mulch: Apply 4,000-5,000 lb/acre grain straw or equivalent cover of another suitable mulching material. Anchor mulch by tacking with asphalt, roving, or netting. Netting or hydroseed with adequate mulch shall be the required anchoring method on steep slopes (greater than 2:1). North American Green SC150BN netting or North American Green Hydromax CM mulch may be used. Alternatives may be approved on a case by case basis.							
Maintenance: Mow no more than once a year. Re-fertilize in the second year unless growth is fully adequate. Reseed, fertilize, and mulch damaged areas immediately.							

PERMANENT SEEDING SCHEDULE (GRASSED AREAS UP TO 3:1 SLOPE)			
Seeding mixture: Species Tall fescue blend (equal parts KY-31 & Rebel 2)	<table border="1" style="width: 100%; border-collapse: collapse;"> <tr> <th style="text-align: left;">Rate (lb/acre)</th> </tr> <tr> <td>200-250</td> </tr> </table>	Rate (lb/acre)	200-250
Rate (lb/acre)			
200-250			
Seeding dates: Below 2500 ft: Aug. 15 - Sept. 1 Above 2500 ft: July 25 - Aug. 15			
Soil Amendments: Apply lime and fertilizer according to soil tests or apply 4,000 lb/acre ground agricultural limestone and 1,200 lb/acre 10-10-10 fertilizer.			
Mulch: Apply 3,000-4,000 lb/acre grain straw or equivalent cover of another suitable mulch. Anchor mulch by tacking with asphalt, roving, or netting. Netting is the preferred anchoring method on steep slopes.			
Maintenance: The bunch-type habit of tall fescue restricts its spread into damaged areas. Reseed bare spots in the fall. Re-fertilize annually in late winter and again in fall. Reseed, fertilize, and mulch damaged areas immediately.			

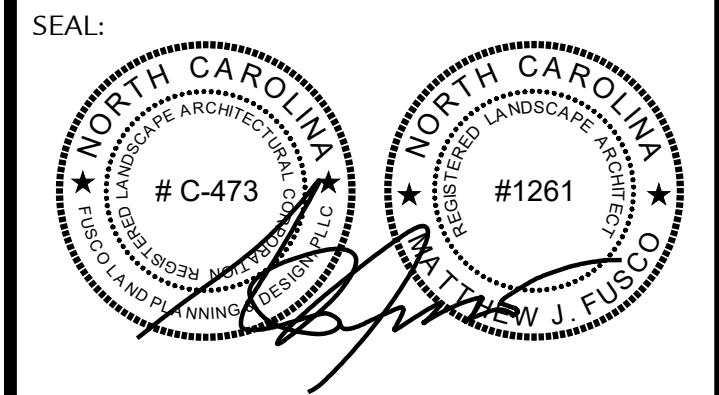

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ISSUE DATE: 09/09/2021		
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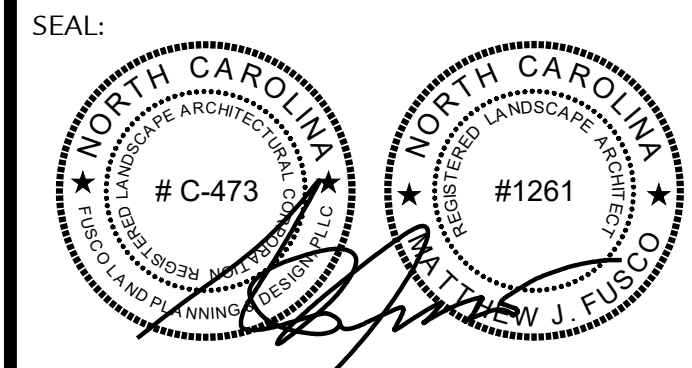
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SHEET TITLE:

Notes & Specifications

SHEET NO:

L1.01



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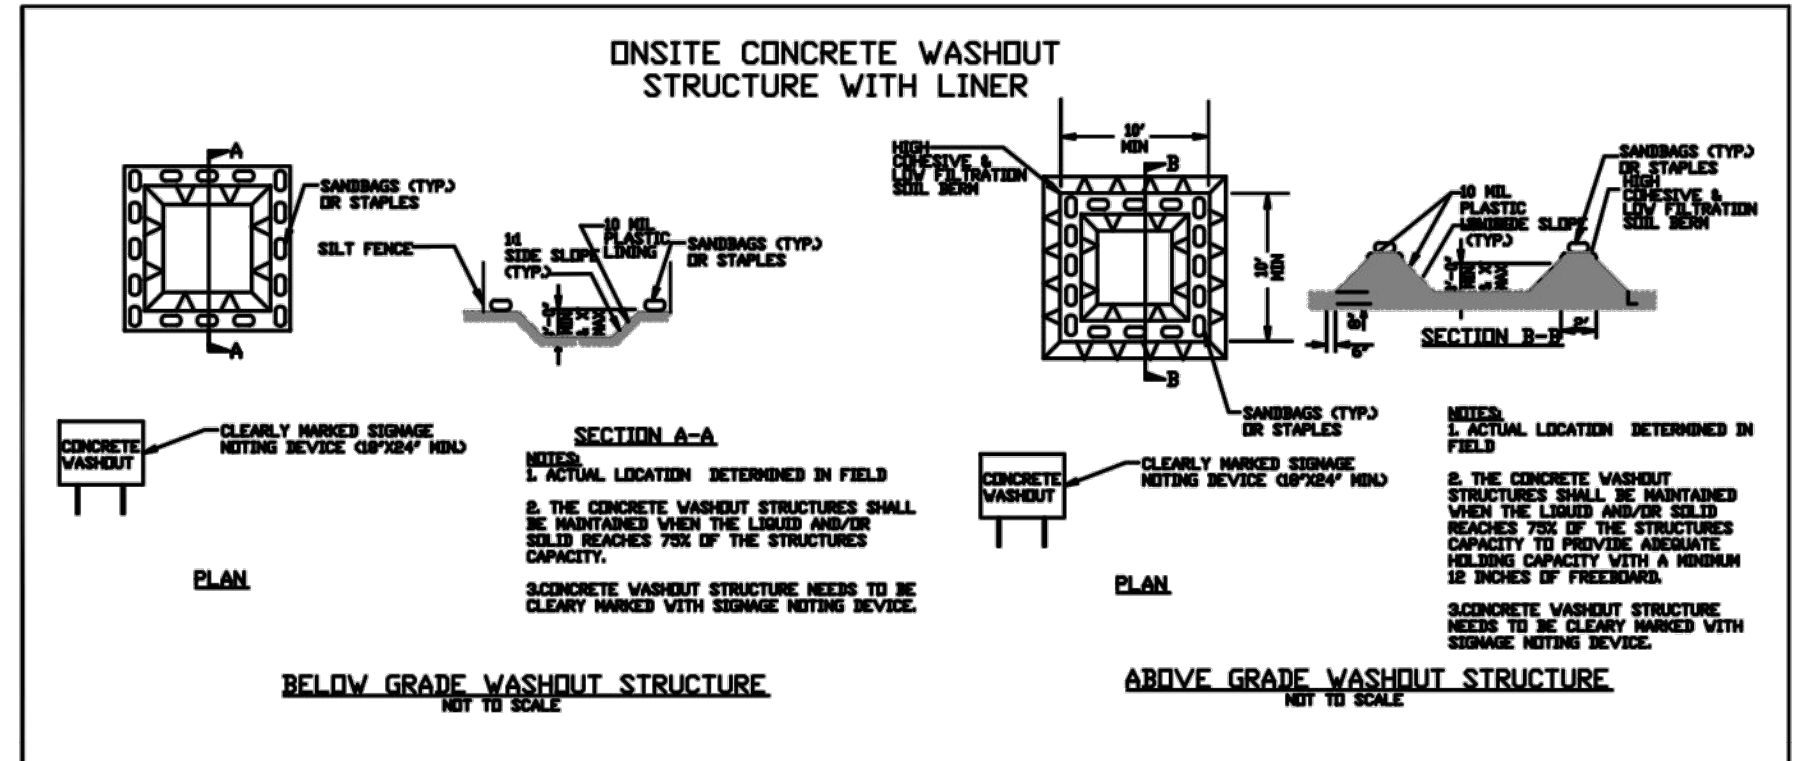
ISSUE DATE: 09/09/2021

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SHEET TITLE:
Ground Stabilization & Materials Handling

SHEET NO:
L1.02



CONCRETE WASHOUTS

- Do not discharge concrete or cement slurry from the site.
- Dispose of, or recycle settled, hardened concrete residue in accordance with local and state solid waste regulations and at an approved facility.
- Manage washout from mortar mixers in accordance with the above item and in addition place the mixer and associated materials on impervious barrier and within lot perimeter silt fence.
- Install temporary concrete washouts per local requirements, where applicable. If an alternate method or product is to be used, contact your approval authority for review and approval. If local standard details are not available, use one of the two types of temporary concrete washouts provided on this detail.
- Do not use concrete washouts for dewatering or storing defective curb or sidewalk sections. Stormwater accumulated within the washout may not be pumped into or discharged to the storm drain system or receiving surface waters. Liquid waste must be pumped out and removed from project.
- Locate washouts at least 50 feet from storm drain inlets and surface waters unless it can be shown that no other alternatives are reasonably available. At a minimum, install protection of storm drain inlet(s) closest to the washout which could receive spills or overflow.
- Locate washouts in an easily accessible area, on level ground and install a stone entrance pad in front of the washout. Additional controls may be required by the approving authority.
- Install at least one sign directing concrete trucks to the washout within the project limits. Post signage on the washout itself to identify this location.
- Remove leavings from the washout when at approximately 75% capacity to limit overflow events. Replace the tarp, sand bags or other temporary structural components when no longer functional. When utilizing alternative or proprietary products, follow manufacturer's instructions.
- At the completion of the concrete work, remove remaining leavings and dispose of in an approved disposal facility. Fill pit, if applicable, and stabilize any disturbance caused by removal of washout.

HERBICIDES, PESTICIDES AND RODENTICIDES

- Store and apply herbicides, pesticides and rodenticides in accordance with label restrictions.
- Store herbicides, pesticides and rodenticides in their original containers with the label, which lists directions for use, ingredients and first aid steps in case of accidental poisoning.
- Do not store herbicides, pesticides and rodenticides in areas where flooding is possible or where they may spill or leak into wells, stormwater drains, ground water or surface water. If a spill occurs, clean area immediately.
- Do not stockpile these materials onsite.

HAZARDOUS AND TOXIC WASTE

- Create designated hazardous waste collection areas on-site.
- Place hazardous waste containers under cover or in secondary containment.
- Do not store hazardous chemicals, drums or bagged materials directly on the ground.

EQUIPMENT AND VEHICLE MAINTENANCE

- Maintain vehicles and equipment to prevent discharge of fluids.
- Provide drip pans under any stored equipment.
- Identify leaks and repair as soon as feasible, or remove leaking equipment from the project.
- Collect all spent fluids, store in separate containers and properly dispose as hazardous waste (recycle when possible).
- Remove leaking vehicles and construction equipment from service until the problem has been corrected.
- Bring used fuels, lubricants, coolants, hydraulic fluids and other petroleum products to a recycling or disposal center that handles these materials.

LITTER, BUILDING MATERIAL AND LAND CLEARING WASTE

- Never bury or burn waste. Place litter and debris in approved waste containers.
- Provide a sufficient number and size of waste containers (e.g dumpster, trash receptacle) on site to contain construction and domestic wastes.
- Locate waste containers at least 50 feet away from storm drain inlets and surface waters unless no other alternatives are reasonably available.
- Locate waste containers on areas that do not receive substantial amounts of runoff from upland areas and does not drain directly to a storm drain, stream or wetland.
- Cover waste containers at the end of each workday and before storm events or provide secondary containment. Repair or replace damaged waste containers.
- Anchor all lightweight items in waste containers during times of high winds.
- Empty waste containers as needed to prevent overflow. Clean up immediately if containers overflow.
- Dispose waste off-site at an approved disposal facility.
- On business days, clean up and dispose of waste in designated waste containers.

PAINT AND OTHER LIQUID WASTE

- Do not dump paint and other liquid waste into storm drains, streams or wetlands.
- Locate paint washouts at least 50 feet away from storm drain inlets and surface waters unless no other alternatives are reasonably available.
- Contain liquid wastes in a controlled area.
- Containment must be labeled, sized and placed appropriately for the needs of site.
- Prevent the discharge of soaps, solvents, detergents and other liquid wastes from construction sites.

PORTABLE TOILETS

- Install portable toilets on level ground, at least 50 feet away from storm drains, streams or wetlands unless there is no alternative reasonably available. If 50 foot offset is not attainable, provide relocation of portable toilet behind silt fence or place on a gravel pad and surround with sand bags.
- Provide staking or anchoring of portable toilets during periods of high winds or in high foot traffic areas.
- Monitor portable toilets for leaking and properly dispose of any leaked material. Utilize a licensed sanitary waste hauler to remove leaking portable toilets and replace with properly operating unit.

EARTHEN STOCKPILE MANAGEMENT

- Show stockpile locations on plans. Locate earthen-material stockpile areas at least 50 feet away from storm drain inlets, sediment basins, perimeter sediment controls and surface waters unless it can be shown no other alternatives are reasonably available.
- Protect stockpile with silt fence installed along toe of slope with a minimum offset of five feet from the toe of stockpile.
- Provide stable stone access point when feasible.
- Stabilize stockpile within the timeframes provided on this sheet and in accordance with the approved plan and any additional requirements. Soil stabilization is defined as vegetative, physical or chemical coverage techniques that will restrain accelerated erosion on disturbed soils for temporary or permanent control needs.



GROUND STABILIZATION AND MATERIALS HANDLING PRACTICES FOR COMPLIANCE WITH THE NCG01 CONSTRUCTION GENERAL PERMIT

Implementing the details and specifications on this plan sheet will result in the construction activity being considered compliant with the Ground Stabilization and Materials Handling sections of the NCG01 Construction General Permit (Sections E and F, respectively). The permittee shall comply with the Erosion and Sediment Control plan approved by the delegated authority having jurisdiction. All details and specifications shown on this sheet may not apply depending on site conditions and the delegated authority having jurisdiction.

SECTION E: GROUND STABILIZATION

Required Ground Stabilization Timeframes		
Site Area Description	Stabilize within this many calendar days after ceasing land disturbance	Timeframe variations
(a) Perimeter dikes, swales, ditches, and perimeter slopes	7	None
(b) High Quality Water (HQW) Zones	7	None
(c) Slopes steeper than 3:1	7	If slopes are 10' or less in length and are not steeper than 2:1, 14 days are allowed
(d) Slopes 3:1 to 4:1	14	-7 days for slopes greater than 50' in length and with slopes steeper than 4:1 -7 days for perimeter dikes, swales, ditches, perimeter slopes and HQW Zones -10 days for Falls Lake Watershed
(e) Areas with slopes flatter than 4:1	14	-7 days for perimeter dikes, swales, ditches, perimeter slopes and HQW Zones -10 days for Falls Lake Watershed unless there is zero slope

Note: After the permanent cessation of construction activities, any areas with temporary ground stabilization shall be converted to permanent ground stabilization as soon as practicable but in no case longer than 90 calendar days after the last land disturbing activity. Temporary ground stabilization shall be maintained in a manner to render the surface stable against accelerated erosion until permanent ground stabilization is achieved.


GROUND STABILIZATION SPECIFICATION

Stabilize the ground sufficiently so that rain will not dislodge the soil. Use one of the techniques in the table below:


Temporary Stabilization	Permanent Stabilization
<ul style="list-style-type: none"> Temporary grass seed covered with straw or other mulches and tackifiers Hydroseeding Rolled erosion control products with or without temporary grass seed Appropriately applied straw or other mulch Plastic sheeting 	<ul style="list-style-type: none"> Permanent grass seed covered with straw or other mulches and tackifiers Geotextile fabrics such as permanent soil reinforcement matting Hydroseeding Shrubs or other permanent plantings covered with mulch Uniform and evenly distributed ground cover sufficient to restrain erosion Structural methods such as concrete, asphalt or retaining walls Rolled erosion control products with grass seed

POLYACRYLAMIDES (PAMS) AND FLOCCULANTS

- Select flocculants that are appropriate for the soils being exposed during construction, selecting from the *NC DWR List of Approved PAMS/Flocculants*.
- Apply flocculants at or before the inlets to Erosion and Sediment Control Measures.
- Apply flocculants at the concentrations specified in the *NC DWR List of Approved PAMS/Flocculants* and in accordance with the manufacturer's instructions.
- Provide ponding area for containment of treated Stormwater before discharging offsite.
- Store flocculants in leak-proof containers that are kept under storm-resistant cover or surrounded by secondary containment structures.

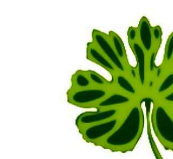

SEAL:

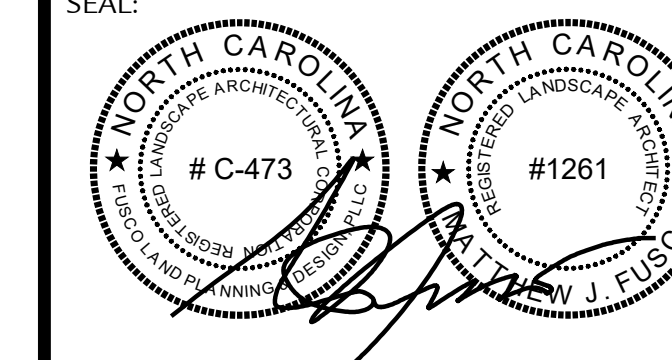

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SHEET TITLE:

**Self-Inspection,
Recordkeeping, &
Reporting**

SHEET NO:

L1.03

**PART III
SELF-INSPECTION, RECORDKEEPING AND REPORTING**

SECTION C: REPORTING

1. Occurrences that Must be Reported

- Permittees shall report the following occurrences:
- (a) Visible sediment deposition in a stream or wetland.
 - (b) Oil spills if:
 - They are 25 gallons or more,
 - They are less than 25 gallons but cannot be cleaned up within 24 hours,
 - They cause sheen on surface waters (regardless of volume), or
 - They are within 100 feet of surface waters (regardless of volume).
 - (c) Releases of hazardous substances in excess of reportable quantities under Section 311 of the Clean Water Act (Ref: 40 CFR 110.3 and 40 CFR 117.3) or Section 102 of CERCLA (Ref: 40 CFR 302.4) or G.S. 143-215.85.
 - (d) Anticipated bypasses and unanticipated bypasses.
 - (e) Noncompliance with the conditions of this permit that may endanger health or the environment.

2. Reporting Timeframes and Other Requirements

After a permittee becomes aware of an occurrence that must be reported, he shall contact the appropriate Division regional office within the timeframes and in accordance with the other requirements listed below. Occurrences outside normal business hours may also be reported to the Department's Environmental Emergency Center personnel at (800) 858-0368.

Occurrence	Reporting Timeframes (After Discovery) and Other Requirements
(a) Visible sediment deposition in a stream or wetland	<ul style="list-style-type: none"> • Within 24 hours, an oral or electronic notification. • Within 7 calendar days, a report that contains a description of the sediment and actions taken to address the cause of the deposition. Division staff may waive the requirement for a written report on a case-by-case basis. • If the stream is named on the NC 303(d) list as impaired for sediment-related causes, the permittee may be required to perform additional monitoring, inspections or apply more stringent practices if staff determine that additional requirements are needed to assure compliance with the federal or state impaired-waters conditions.
(b) Oil spills and release of hazardous substances per Item 1(b)-(c) above	<ul style="list-style-type: none"> • Within 24 hours, an oral or electronic notification. The notification shall include information about the date, time, nature, volume and location of the spill or release.
(c) Anticipated bypasses [40 CFR 122.41(m)(3)]	<ul style="list-style-type: none"> • A report at least ten days before the date of the bypass, if possible. The report shall include an evaluation of the anticipated quality and effect of the bypass.
(d) Unanticipated bypasses [40 CFR 122.41(m)(3)]	<ul style="list-style-type: none"> • Within 24 hours, an oral or electronic notification. • Within 7 calendar days, a report that includes an evaluation of the quality and effect of the bypass.
(e) Noncompliance with the conditions of this permit that may endanger health or the environment [40 CFR 122.41(l)(7)]	<ul style="list-style-type: none"> • Within 24 hours, an oral or electronic notification. • Within 7 calendar days, a report that contains a description of the noncompliance, and its causes; the period of noncompliance, including exact dates and times, and if the noncompliance has not been corrected, the anticipated time noncompliance is expected to continue; and steps taken or planned to reduce, eliminate, and prevent reoccurrence of the noncompliance. [40 CFR 122.41(l)(6)]. • Division staff may waive the requirement for a written report on a case-by-case basis.



**PART III
SELF-INSPECTION, RECORDKEEPING AND REPORTING**

SECTION B: RECORDKEEPING

1. E&SC Plan Documentation

The approved E&SC plan as well as any approved deviation shall be kept on the site. The approved E&SC plan must be kept up-to-date throughout the coverage under this permit. The following items pertaining to the E&SC plan shall be kept on site and available for inspection at all times during normal business hours.

Item to Document	Documentation Requirements
(a) Each E&SC measure has been installed and does not significantly deviate from the locations, dimensions and relative elevations shown on the approved E&SC plan.	Initial and date each E&SC measure on a copy of the approved E&SC plan or complete, date and sign an inspection report that lists each E&SC measure shown on the approved E&SC plan. This documentation is required upon the initial installation of the E&SC measures or if the E&SC measures are modified after initial installation.
(b) A phase of grading has been completed.	Initial and date a copy of the approved E&SC plan or complete, date and sign an inspection report to indicate completion of the construction phase.
(c) Ground cover is located and installed in accordance with the approved E&SC plan.	Initial and date a copy of the approved E&SC plan or complete, date and sign an inspection report to indicate compliance with approved ground cover specifications.
(d) The maintenance and repair requirements for all E&SC measures have been performed.	Complete, date and sign an inspection report.
(e) Corrective actions have been taken to E&SC measures.	Initial and date a copy of the approved E&SC plan or complete, date and sign an inspection report to indicate the completion of the corrective action.

2. Additional Documentation to be Kept on Site

In addition to the E&SC plan documents above, the following items shall be kept on the site and available for inspectors at all times during normal business hours, unless the Division provides a site-specific exemption based on unique site conditions that make this requirement not practical:

- (a) This General Permit as well as the Certificate of Coverage, after it is received.
- (b) Records of inspections made during the previous twelve months. The permittee shall record the required observations on the Inspection Record Form provided by the Division or a similar inspection form that includes all the required elements. Use of electronically-available records in lieu of the required paper copies will be allowed if shown to provide equal access and utility as the hard-copy records.

3. Documentation to be Retained for Three Years

All data used to complete the e-NOI and all inspection records shall be maintained for a period of three years after project completion and made available upon request. [40 CFR 122.41]

**PART III
SELF-INSPECTION, RECORDKEEPING AND REPORTING**

SECTION A: SELF-INSPECTION

Self-inspections are required during normal business hours in accordance with the table below. When adverse weather or site conditions would cause the safety of the inspection personnel to be in jeopardy, the inspection may be delayed until the next business day on which it is safe to perform the inspection. In addition, when a storm event of equal to or greater than 1.0 inch occurs outside of normal business hours, the self-inspection shall be performed upon the commencement of the next business day. Any time when inspections were delayed shall be noted in the Inspection Record.

Inspect	Frequency (during normal business hours)	Inspection records must include:
(1) Rain gauge maintained in good working order	Daily	Daily rainfall amounts. If no daily rain gauge observations are made during weekend or holiday periods, and no individual-day rainfall information is available, record the cumulative rain measurement for those unattended days (and this will determine if a site inspection is needed). Days on which no rainfall occurred shall be recorded as "zero." The permittee may use another rain-monitoring device approved by the Division.
(2) E&SC Measures	At least once per 7 calendar days and within 24 hours of a rain event ≥ 1.0 inch in 24 hours	<ol style="list-style-type: none"> 1. Identification of the measures inspected, 2. Date and time of the inspection, 3. Name of the person performing the inspection, 4. Indication of whether the measures were operating properly, 5. Description of maintenance needs for the measure, 6. Description, evidence, and date of corrective actions taken.
(3) Stormwater discharge outfalls (SDCs)	At least once per 7 calendar days and within 24 hours of a rain event ≥ 1.0 inch in 24 hours	<ol style="list-style-type: none"> 1. Identification of the discharge outfalls inspected, 2. Date and time of the inspection, 3. Name of the person performing the inspection, 4. Evidence of indicators of stormwater pollution such as oil sheen, floating or suspended solids or discoloration, 5. Indication of visible sediment leaving the site, 6. Description, evidence, and date of corrective actions taken.
(4) Perimeter of site	At least once per 7 calendar days and within 24 hours of a rain event ≥ 1.0 inch in 24 hours	If visible sedimentation is found outside site limits, then a record of the following shall be made: <ol style="list-style-type: none"> 1. Actions taken to clean up or stabilize the sediment that has left the site limits, 2. Description, evidence, and date of corrective actions taken, and 3. An explanation as to the actions taken to control future releases.
(5) Streams or wetlands onsite or offsite (where accessible)	At least once per 7 calendar days and within 24 hours of a rain event ≥ 1.0 inch in 24 hours	If the stream or wetland has increased visible sedimentation or a stream has visible increased turbidity from the construction activity, then a record of the following shall be made: <ol style="list-style-type: none"> 1. Description, evidence and date of corrective actions taken, and 2. Records of the required reports to the appropriate Division Regional Office per Part III, Section C, Item (2)(a) of this permit.
(6) Ground stabilization measures	After each phase of grading	<ol style="list-style-type: none"> 1. The phase of grading (installation of perimeter E&SC measures, clearing and grubbing, installation of storm drainage facilities, completion of all land-disturbing activity, construction or redevelopment, permanent ground cover). 2. Documentation that the required ground stabilization measures have been provided within the required timeframe or an assurance that they will be provided as soon as possible.

NOTE: The rain inspection resets the required 7 calendar day inspection requirement.

**PART II, SECTION G, ITEM (4)
DRAW DOWN OF SEDIMENT BASINS FOR MAINTENANCE OR CLOSE OUT**

Sediment basins and traps that receive runoff from drainage areas of one acre or more shall use outlet structures that withdraw water from the surface when these devices need to be drawn down for maintenance or close out unless this is infeasible. The circumstances in which it is not feasible to withdraw water from the surface shall be rare (for example, times with extended cold weather). Non-surface withdrawals from sediment basins shall be allowed only when all of the following criteria have been met:

- (a) The E&SC plan authority has been provided with documentation of the non-surface withdrawal and the specific time periods or conditions in which it will occur. The non-surface withdrawal shall not commence until the E&SC plan authority has approved these items,
- (b) The non-surface withdrawal has been reported as an anticipated bypass in accordance with Part III, Section C, Item (2)(c) and (d) of this permit,
- (c) Dewatering discharges are treated with controls to minimize discharges of pollutants from stormwater that is removed from the sediment basin. Examples of appropriate controls include properly sited, designed and maintained dewatering tanks, weir tanks, and filtration systems,
- (d) Vegetated, upland areas of the sites or a properly designed stone pad is used to the extent feasible at the outlet of the dewatering treatment devices described in Item (c) above,
- (e) Velocity dissipation devices such as check dams, sediment traps, and riprap are provided at the discharge points of all dewatering devices, and
- (f) Sediment removed from the dewatering treatment devices described in Item (c) above is disposed of in a manner that does not cause deposition of sediment into waters of the United States.

NCG01 SELF-INSPECTION, RECORDKEEPING AND REPORTING

EFFECTIVE: 04/01/19

PROJECT DATA:	
OWNER:	ANGELA & DEREK WEILBAECHER
ADDRESS:	414 VANDERBILT ROAD BILTMORE FOREST, NC 28803
PIN(s):	9646-66-1233
DEED REFERENCE:	5948/0296
PLAT:	2-34
ZONING:	R-1
ADJOINER ZONING:	R-1
SETBACKS:	FRONT: 60' - SIDE: 20' - REAR: 25'
SETBACK REQUIREMENTS DUE TO BUILDING HEIGHT***:	SIDE: 41' - REAR: 46'
RIVER BASIN*:	FRENCH BROAD
TOTAL ACREAGE:	3.01 AC PER TAX RECORDS
DISTURBED AREA:	1.38 AC
EXISTING IMPERVIOUS AREA:	13,554 S.F. (0.31 AC) (10.35%)
PROPOSED IMPERVIOUS AREA:	18,817 S.F. (0.53 AC) (14.35%)
PERCENT IMPERVIOUS AREA CHANGE:	ADD 4.0%
ALLOWABLE IMPERVIOUS SURFACE AREA (20% OF LOT AREA)**:	26,223 S.F. (0.60 AC)


* THERE ARE NO POTENTIALLY JURISDICTIONAL WATERS OF THE STATE OR UNITED STATES ON THIS PROJECT SITE.
 ** PER TOWN OF BILTMORE FOREST ORDINANCE.
 *** ADDITIONAL SETBACK REQUIREMENTS (BUILDING HEIGHT = 38'-6") - ADD 1.5' PER FOOT ABOVE 25' TO SIDE AND REAR SETBACKS.

TREE LIST (WITHIN LIMITS OF DISTURBANCE)

TREES TO REMAIN		TREES TO BE REMOVED	
PT NO.	DESCRIPTION	PT NO.	DESCRIPTION
67	10" HOLLEY	267	36" OAK
275	14" CEDAR	272	20" CEDAR
382	18" SPRUCE	374	42" OAK
386	12" REDWOOD	459	08" CEDAR
398	28" OAK	460	24" PINE
403	20" OAK	464	26" OAK

LEGEND:

- PROPERTY BOUNDARY
- ADJOINING PROPERTY
- TEMPORARY SILT FENCE
- CONSTRUCTION ENTRANCE
- LIMITS OF DISTURBANCE
- INDEX CONTOUR
- INTERMEDIATE CONTOUR
- TREE PROTECTION
- TREES TO BE REMOVED

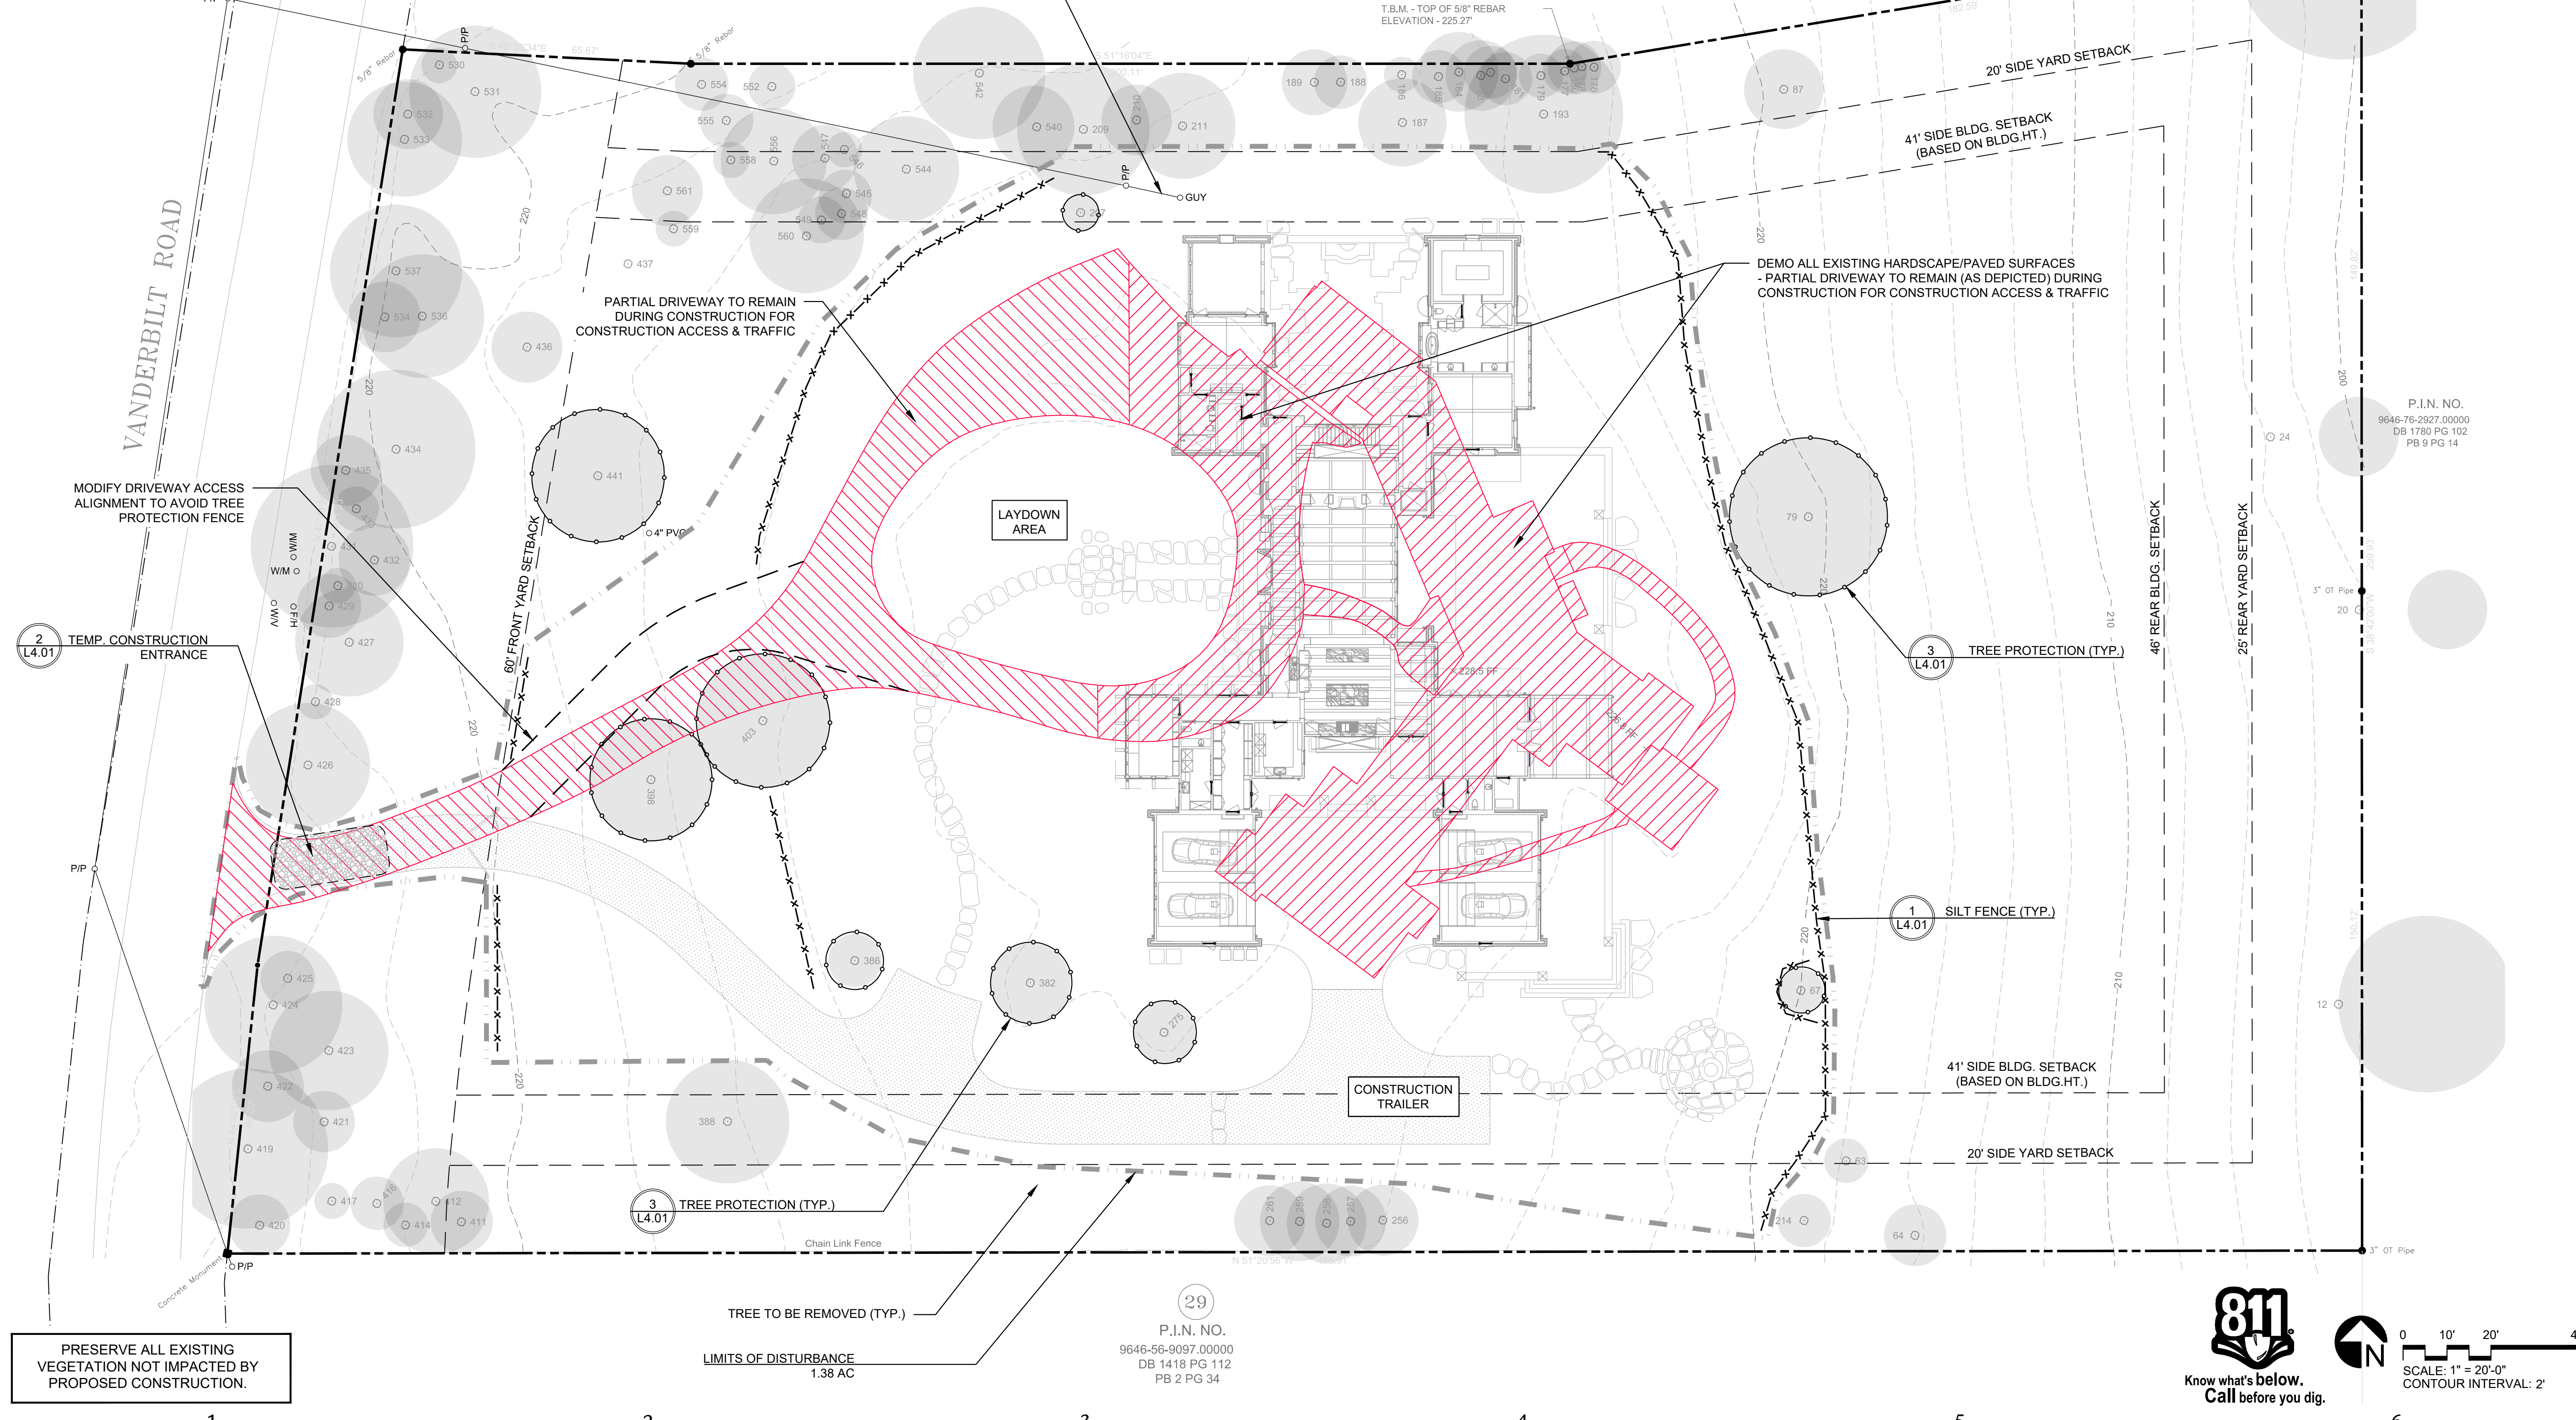

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Westmore
Design, PA

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ISSUE DATE: 09/09/2021

No.	Revision / Issue	Date

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SHEET TITLE:
Site Stabilization & Clearing


SHEET NO:
L2.01

PROJECT DATA:	
OWNER:	ANGELA & DEREK WEILBAECHER
ADDRESS:	414 VANDERBILT ROAD BILTMORE FOREST, NC 28803
PIN(s):	9646-66-1233
DEED REFERENCE:	5948/0296
PLAT:	2-34
ZONING:	R-1
ADJOINER ZONING:	R-1
SETBACKS:	FRONT: 60' - SIDE: 20' - REAR: 25'
SETBACK REQUIREMENTS DUE TO BUILDING HEIGHT***:	SIDE: 41' - REAR: 46'
RIVER BASIN*:	FRENCH BROAD
TOTAL ACREAGE:	3.01 AC PER TAX RECORDS
DISTURBED AREA:	1.38 AC
EXISTING IMPERVIOUS AREA:	13,554 S.F. (0.31 AC) (10.35%)
PROPOSED IMPERVIOUS AREA:	18,817 S.F. (0.53 AC) (14.35%)
PERCENT IMPERVIOUS AREA CHANGE:	ADD 4.0%
ALLOWABLE IMPERVIOUS SURFACE AREA (20% OF LOT AREA)**:	26,223 S.F. (0.60 AC)

* THERE ARE NO POTENTIALLY JURISDICTIONAL WATERS OF THE STATE OR UNITED STATES ON THIS PROJECT SITE.
 ** PER TOWN OF BILTMORE FOREST ORDINANCE.
 *** ADDITIONAL SETBACK REQUIREMENTS (BUILDING HEIGHT = 38'-6") - ADD 1.5' PER FOOT ABOVE 25' TO SIDE AND REAR SETBACKS.

LEGEND

INDEX CONTOUR	---	PROPOSED SPOT ELEVATION	97.5
INTERMEDIATE CONTOUR	---	TYPICAL	TYP.
PROPERTY LINE	---	HIGH POINT OF SWALE	HPS
ADJOINING PROPERTY LINE	---	TOP OF WALL	TW
PROPOSED INDEX CONTOUR	---	BOTTOM OF WALL	BW
PROPOSED INTERMEDIATE CONTOUR	---	DOWNSPOUT	DS
SILT FENCE	-x-x-x-x-x-	HEAT PUMP	HP
LIMITS OF DISTURBANCE	---	GENERATOR	GEN
SWALE	---	DRAIN INLET	DI
TREE PROTECTION	○	YARD INLET (SEE DETAIL 4/L4.01)	YI

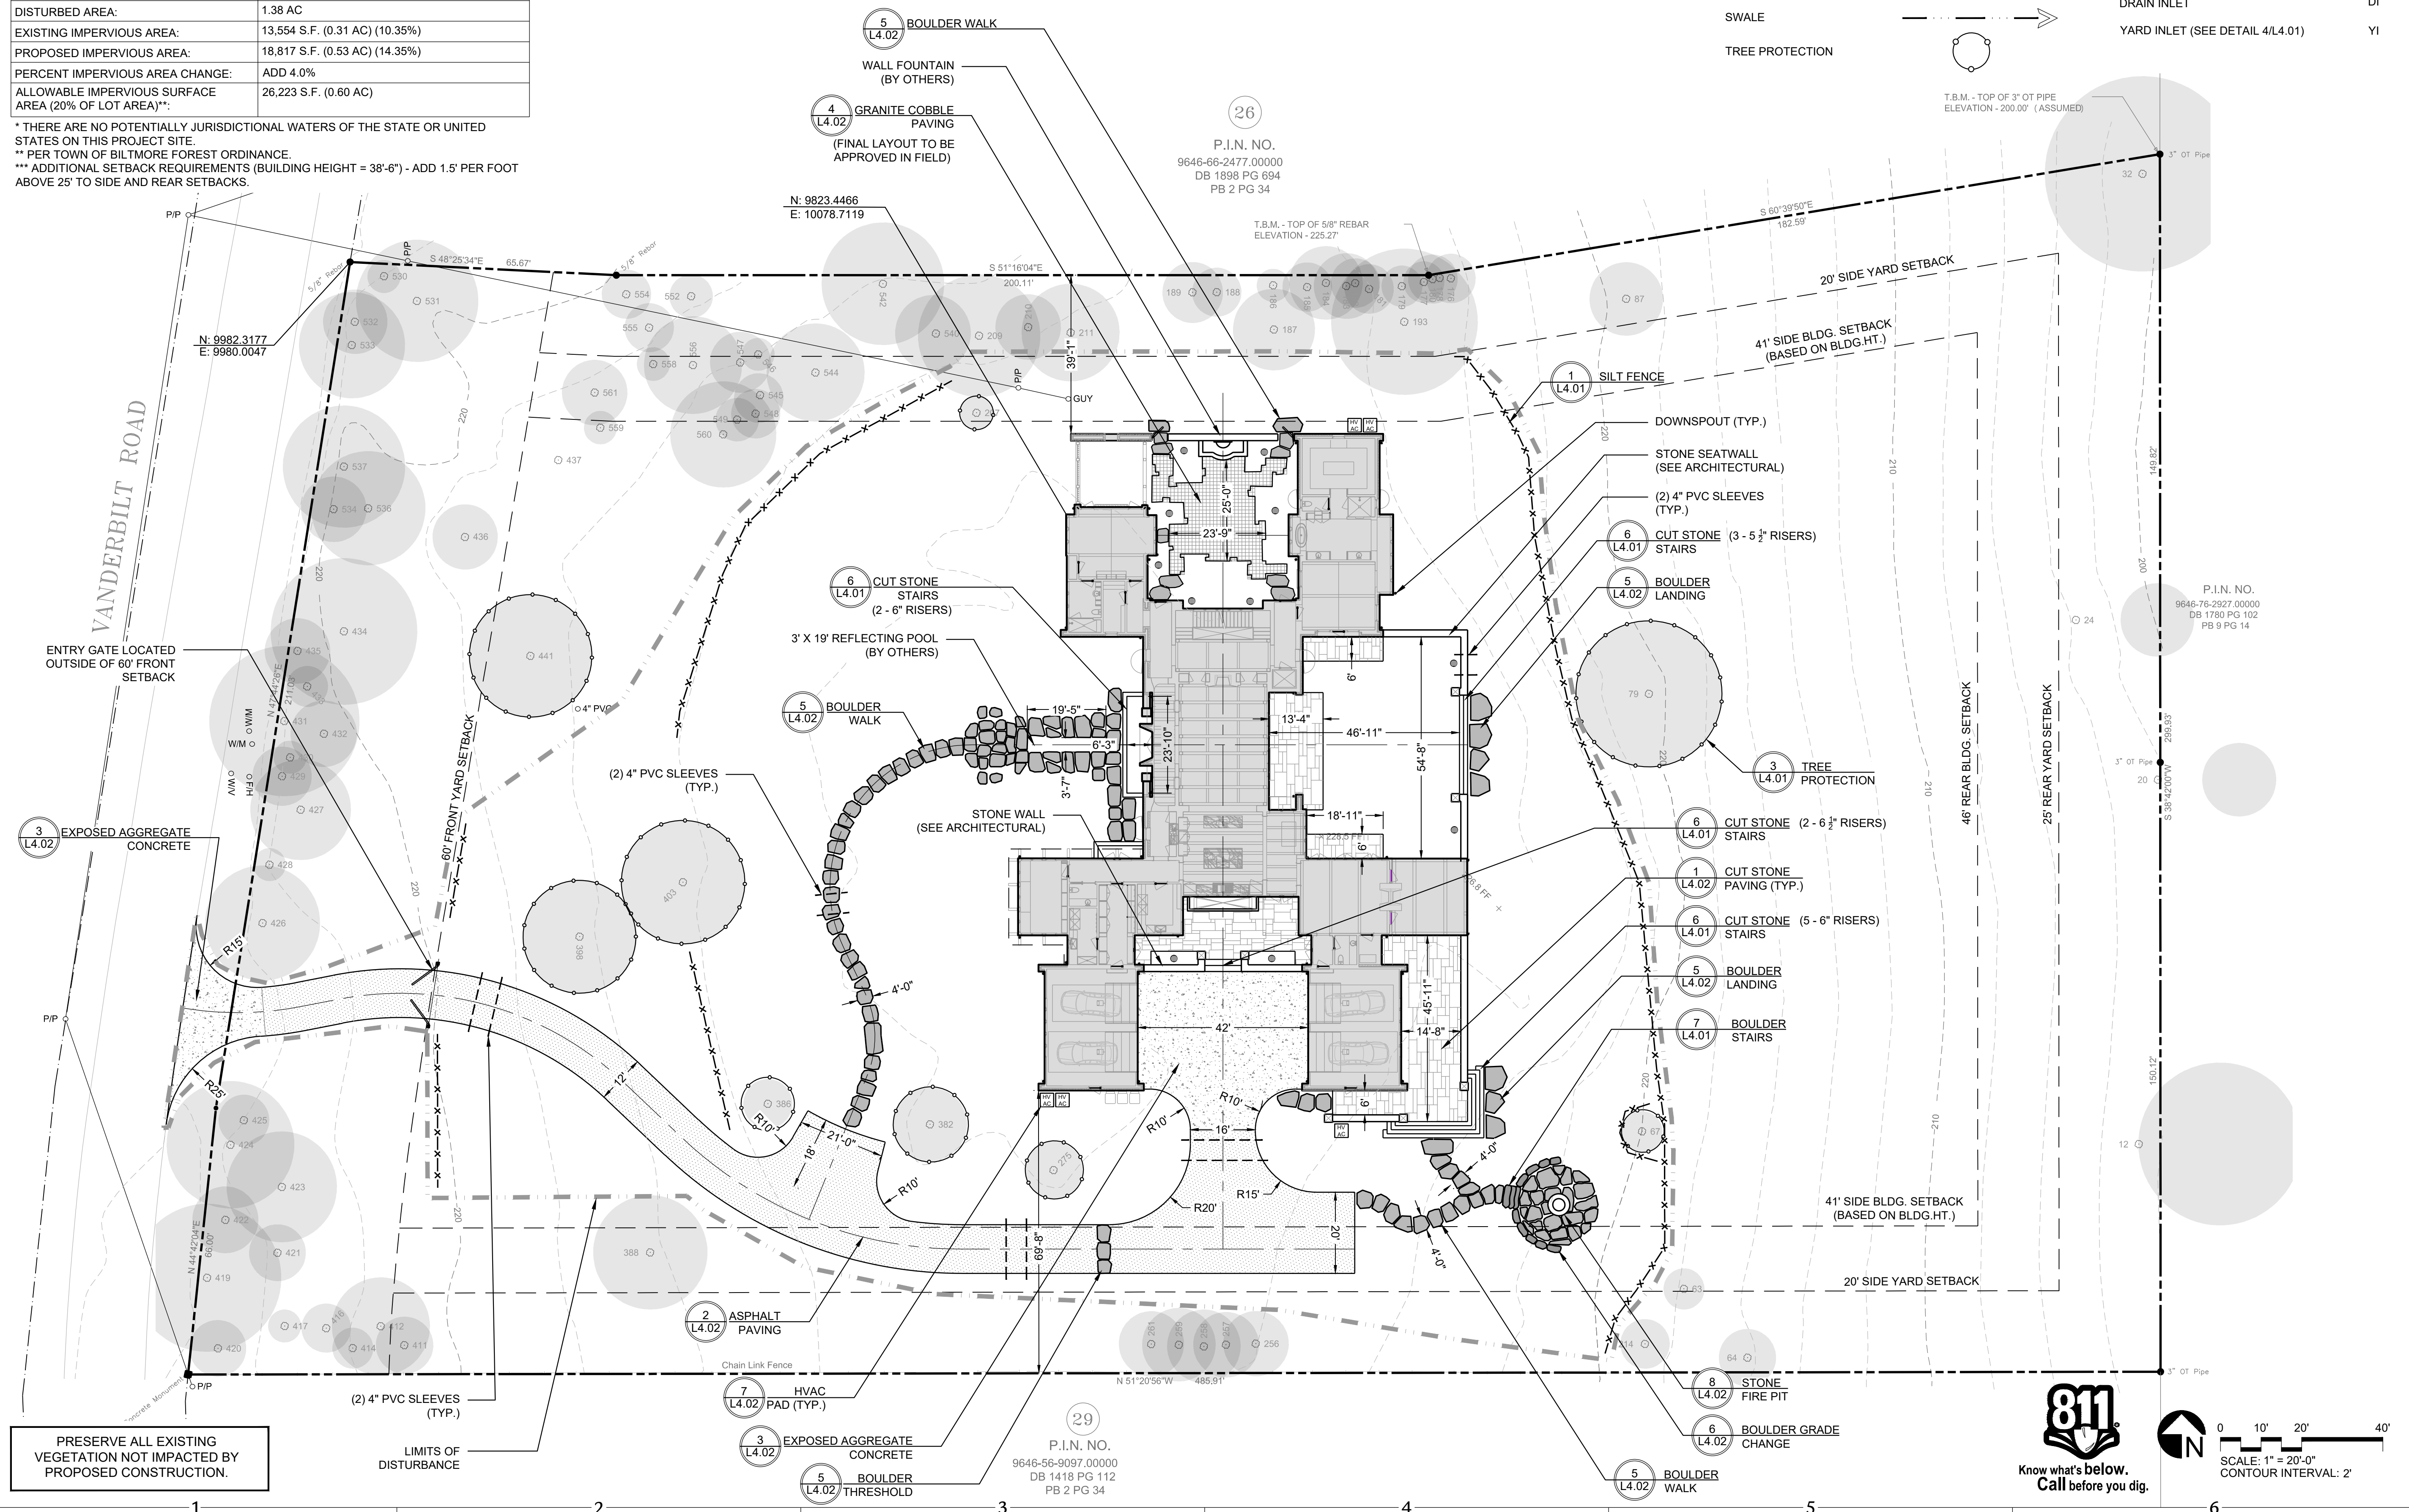

SEAL:

DRAWN BY: NAT
CHECKED BY: MJF

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ISSUE DATE: 09/09/2021

No.	Revision / Issue	Date

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SHEET TITLE:
Site Layout & Materials

SHEET NO:
L3.01

Scale: 1" = 20'-0" CONTOUR INTERVAL: 2'

PROJECT DATA:	
OWNER:	ANGELA & DEREK WEILBAECHER
ADDRESS:	414 VANDERBILT ROAD BILTMORE FOREST, NC 28803
PIN(s):	9646-66-1233
DEED REFERENCE:	5948/0296
PLAT:	2-34
ZONING:	R-1
ADJOINER ZONING:	R-1
SETBACKS:	FRONT: 60' - SIDE: 20' - REAR: 25'
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PROPOSED IMPERVIOUS AREA:	18,817 S.F. (0.53 AC) (14.35%)
PERCENT IMPERVIOUS AREA CHANGE:	ADD 4.0%
ALLOWABLE IMPERVIOUS SURFACE AREA (20% OF LOT AREA)**:	26,223 S.F. (0.60 AC)

DITCH REINFORCEMENT																	
Ditch	Total Acres "A"	"C" % Runoff	TOC	Rain "T" 10 yr	Design Q=CIA (CFS)	Slope	Bottom Width (ft) (b)	Side Slopes (Z)	Channel Depth (ft) (d)	n	Velocity	Area (sq. ft.) (A)	Hyd. Rad. (ft.)	Permissible Q (CFS)	Material/Staple Pattern	Permissible shear stress	Calculated shear stress
D1	0.23	0.40	5.00	7.760	0.71	0.0250	1	3	.25	0.022	3.28	0.44	0.17	1.43	Straw w/ Net	1.45	0.39
D2	0.13	0.40	5.00	7.760	0.40	0.0300	1	3	.25	0.022	3.59	0.44	0.17	1.57	Straw w/ Net	1.45	0.47
D3	0.09	0.40	5.00	7.760	0.28	0.0326	1	3	.25	0.022	3.74	0.44	0.17	1.64	Straw w/ Net	1.45	0.51
D4	0.18	0.40	5.00	7.760	0.56	0.0833	1	3	.25	0.022	5.98	0.44	0.17	2.62	Straw w/ Net	1.45	1.30

LEGEND

INDEX CONTOUR: - - - - -

INTERMEDIATE CONTOUR: - - - - -

PROPERTY LINE: - - - - -

ADJOINING PROPERTY LINE: - - - - -

PROPOSED INDEX CONTOUR: 3900

PROPOSED INTERMEDIATE CONTOUR: - - - - -

SILT FENCE: -x-x-x-x-x-

LIMITS OF DISTURBANCE: - - - - -

SWALE: - - - - -

TREE PROTECTION: (Symbol)

PROPOSED SPOT ELEVATION: +97.5

TYPICAL: TYP.

HIGH POINT OF SWALE: HPS

TOP OF WALL: TW

BOTTOM OF WALL: BW

DOWNSPOUT: DS

HEAT PUMP: HP

GENERATOR: GEN


DRAIN INLET: DI

YARD INLET (SEE DETAIL 4/L4.01): Y1

DITCH: (Symbol)

PIPE: (Symbol)

* THERE ARE NO POTENTIALLY JURISDICTIONAL WATERS OF THE STATE OR UNITED STATES ON THIS PROJECT SITE.
 ** PER TOWN OF BILTMORE FOREST ORDINANCE.
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Westmore
Design, PA

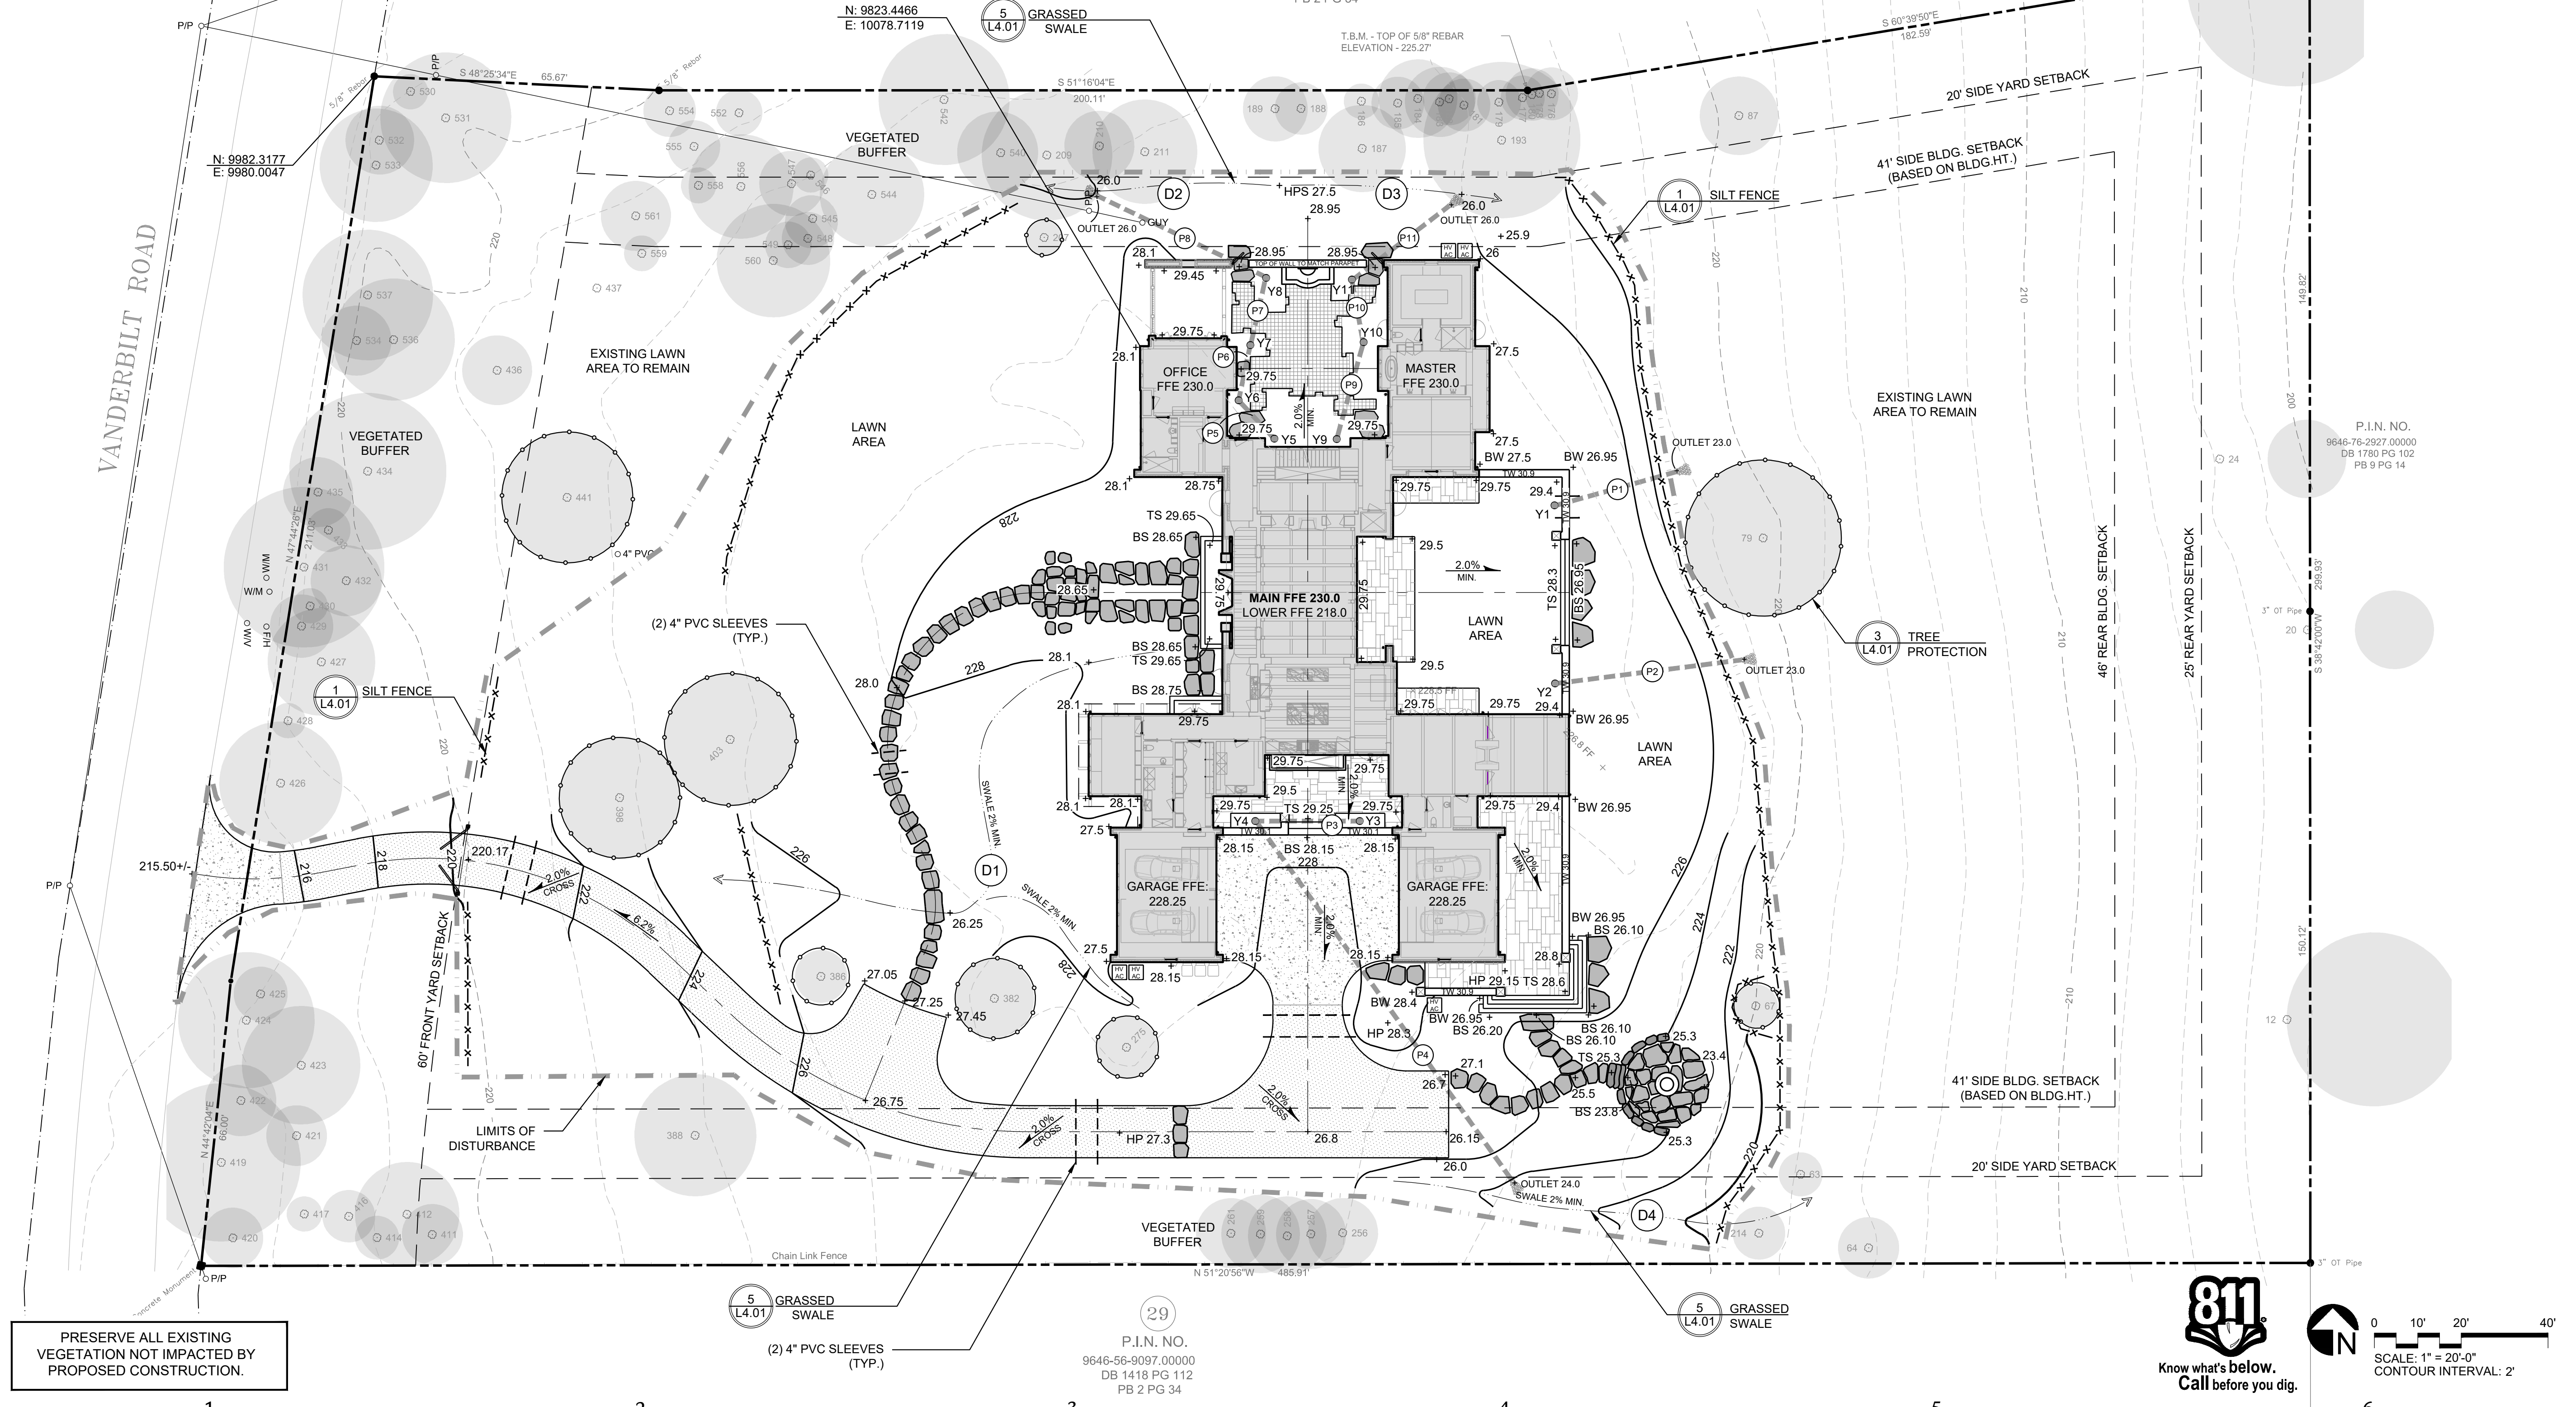SEAL: (Professional Engineer Seal #C-473, Professional Engineer Seal #1261)

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 CHECKED BY: MJF

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ISSUE DATE: 09/09/2021

No.	Revision / Issue	Date

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SHEET TITLE:
Site Grading, Drainage, EC & Stormwater Control

SHEET NO:
L3.02

811
Know what's below.
Call before you dig.

SCALE: 1" = 20'-0"
CONTOUR INTERVAL: 2'

PRESERVE ALL EXISTING VEGETATION NOT IMPACTED BY PROPOSED CONSTRUCTION.

YARD INLET SCHEDULE				RUNOFF & PIPE CAPACITY										Runoff: Q=CIA					
				Pipe Capacity: $Q=1.486/n^2R^{2/3}S^{0.5}A$															
				Approx.										Total					
				Manning's										25Year					
Yard	RIM Elevation	Invert In	Invert Out	Pipe	Pipe Size	Pipe Length	Pipe	"n"	Slope	Invert In	Invert Out	Area to Pipe	Runoff C-Factor	Tc	Rainfall Intensity	Runoff to Pipe	Pipe Capacity	Full Flow Velocity	Sized for the
Inlet	(FT)			Segment	(IN)	(FT)	Mat'l	Factor				(ACRES)	(C)	(Min)	(In/Hr)	(CFS)	(CFS)	(F/Sec)	design storm
Y1	29.30		24.00	P1	12	31.35	HDPE	0.013	3.19%	24.00	23.00	0.10	0.40	5	7.760	0.31	6.4	8.1	OK
Y2	29.30		24.00	P2	12	46.15	HDPE	0.013	2.17%	24.00	23.00	0.10	0.40	5	7.760	0.31	5.2	6.7	OK
Y3	28.75		26.20	P3	12	22.50	HDPE	0.013	2.00%	26.20	25.75	0.03	0.40	5	7.760	0.08	5.0	6.4	OK
Y4	28.75	25.75	25.50	P4	12	100.00	HDPE	0.013	1.50%	25.50	24.00	0.03	0.40	5	7.760	0.08	4.4	5.6	OK
Y5	29.25		27.25	P5	12	10.50	HDPE	0.013	1.43%	27.25	27.10	0.09	0.40	5	7.760	0.27	4.3	5.4	OK
Y6	29.25	27.00	27.00	P6	12	11.50	HDPE	0.013	1.30%	27.00	26.85	0.09	0.40	5	7.760	0.27	4.1	5.2	OK
Y7	29.25	26.85	26.85	P7	12	14.15	HDPE	0.013	1.77%	26.75	26.50	0.09	0.40	5	7.760	0.27	4.7	6.0	OK
Y8	28.50	26.50	26.50	P8	12	44.50	HDPE	0.013	1.35%	26.40	25.80	0.09	0.40	5	7.760	0.27	4.1	5.3	OK
Y9	29.25	27.25	27.25	P9	12	26.00	HDPE	0.013	1.92%	27.25	26.75	0.09	0.40	5	7.760	0.27	4.9	6.3	OK
Y10	29.00	26.75	26.75	P10	12	13.15	HDPE	0.013	1.90%	26.75	26.50	0.09	0.40	5	7.760	0.27	4.9	6.3	OK
Y11	28.50	26.50	26.50	P11	12	21.50	HDPE	0.013	2.33%	26.50	26.00	0.09	0.40	5	7.760	0.27	5.4	6.9	OK


* If pipe size shown is not available increase to next available pipe size. Ensure 2' cover over all pipes.

** TOC was determined using chart 8.03.04 of the erosion control manual. All TOC's less than 5, were rounded up to 5.


*** Pipes 5-11 sized for entire courtyard area to provide for redundancy against flooding.



Westmore Design, PA

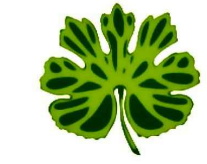

SEAL:

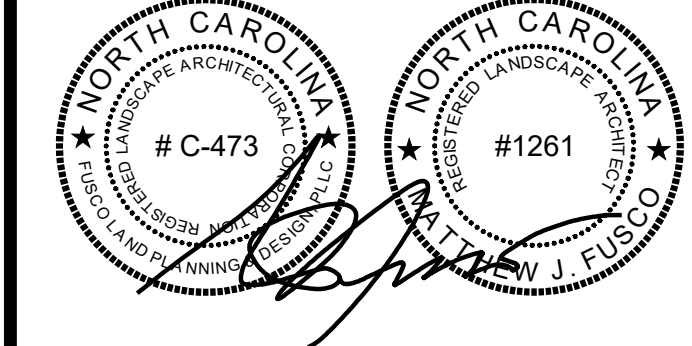

DRAWN BY: NAT

CHECKED BY: MJF

WEILBAECHER RESIDENCE
 414 VANDERBILT ROAD, BILTMORE FOREST, NC 28803 - BUNCOMBE COUNTY

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ISSUE DATE: 09/09/2021

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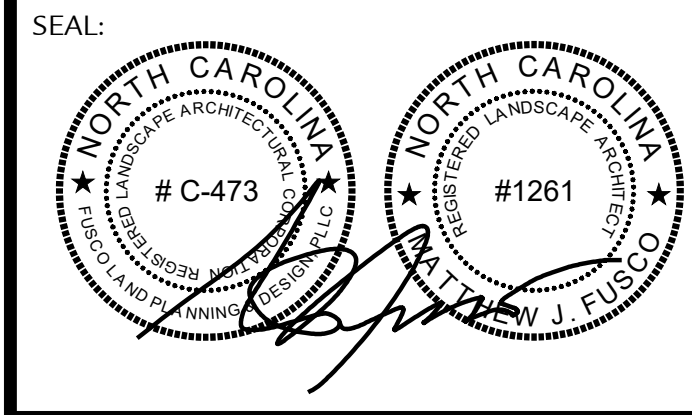
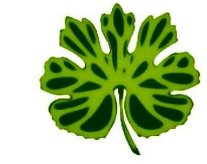
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SHEET TITLE:

Yard Inlet & Pipe Schedule

SHEET NO:

L3.03



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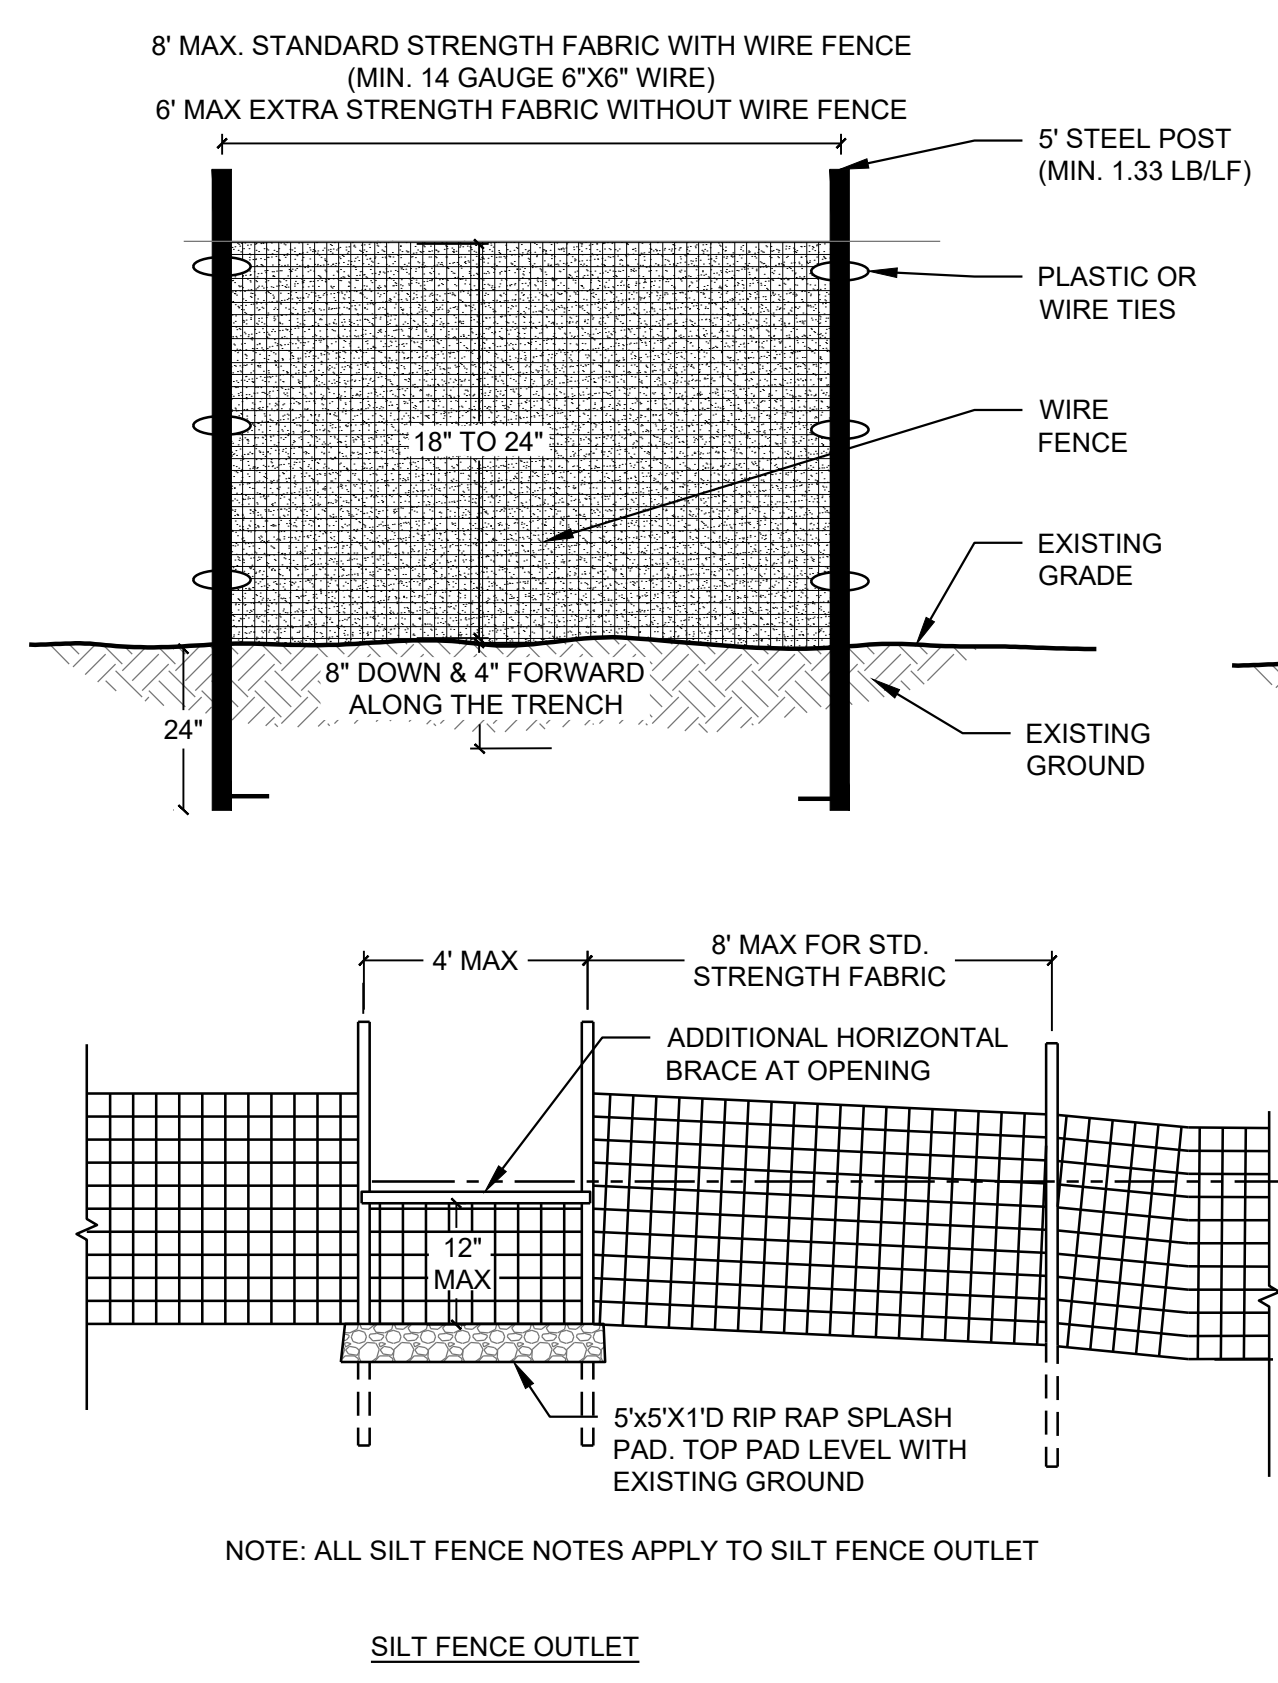
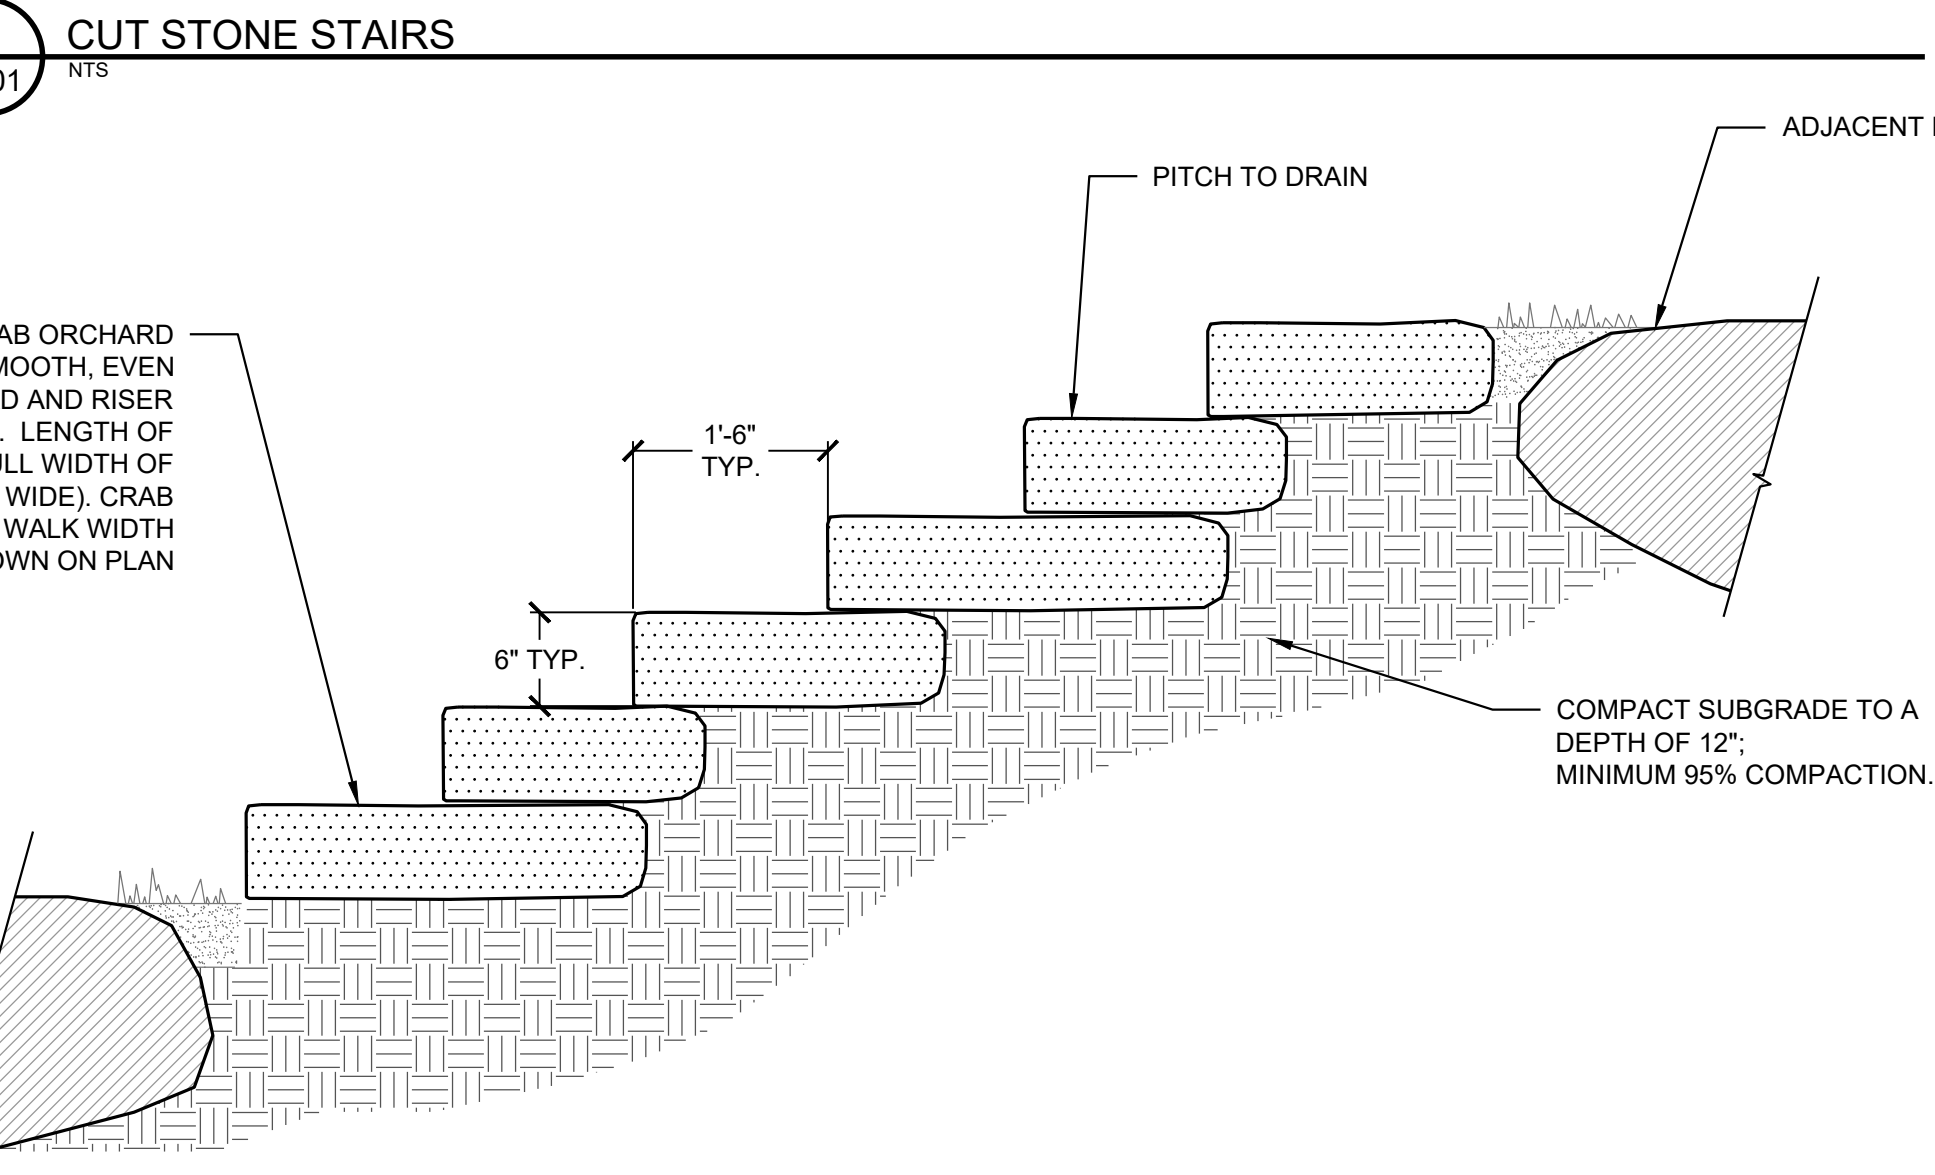
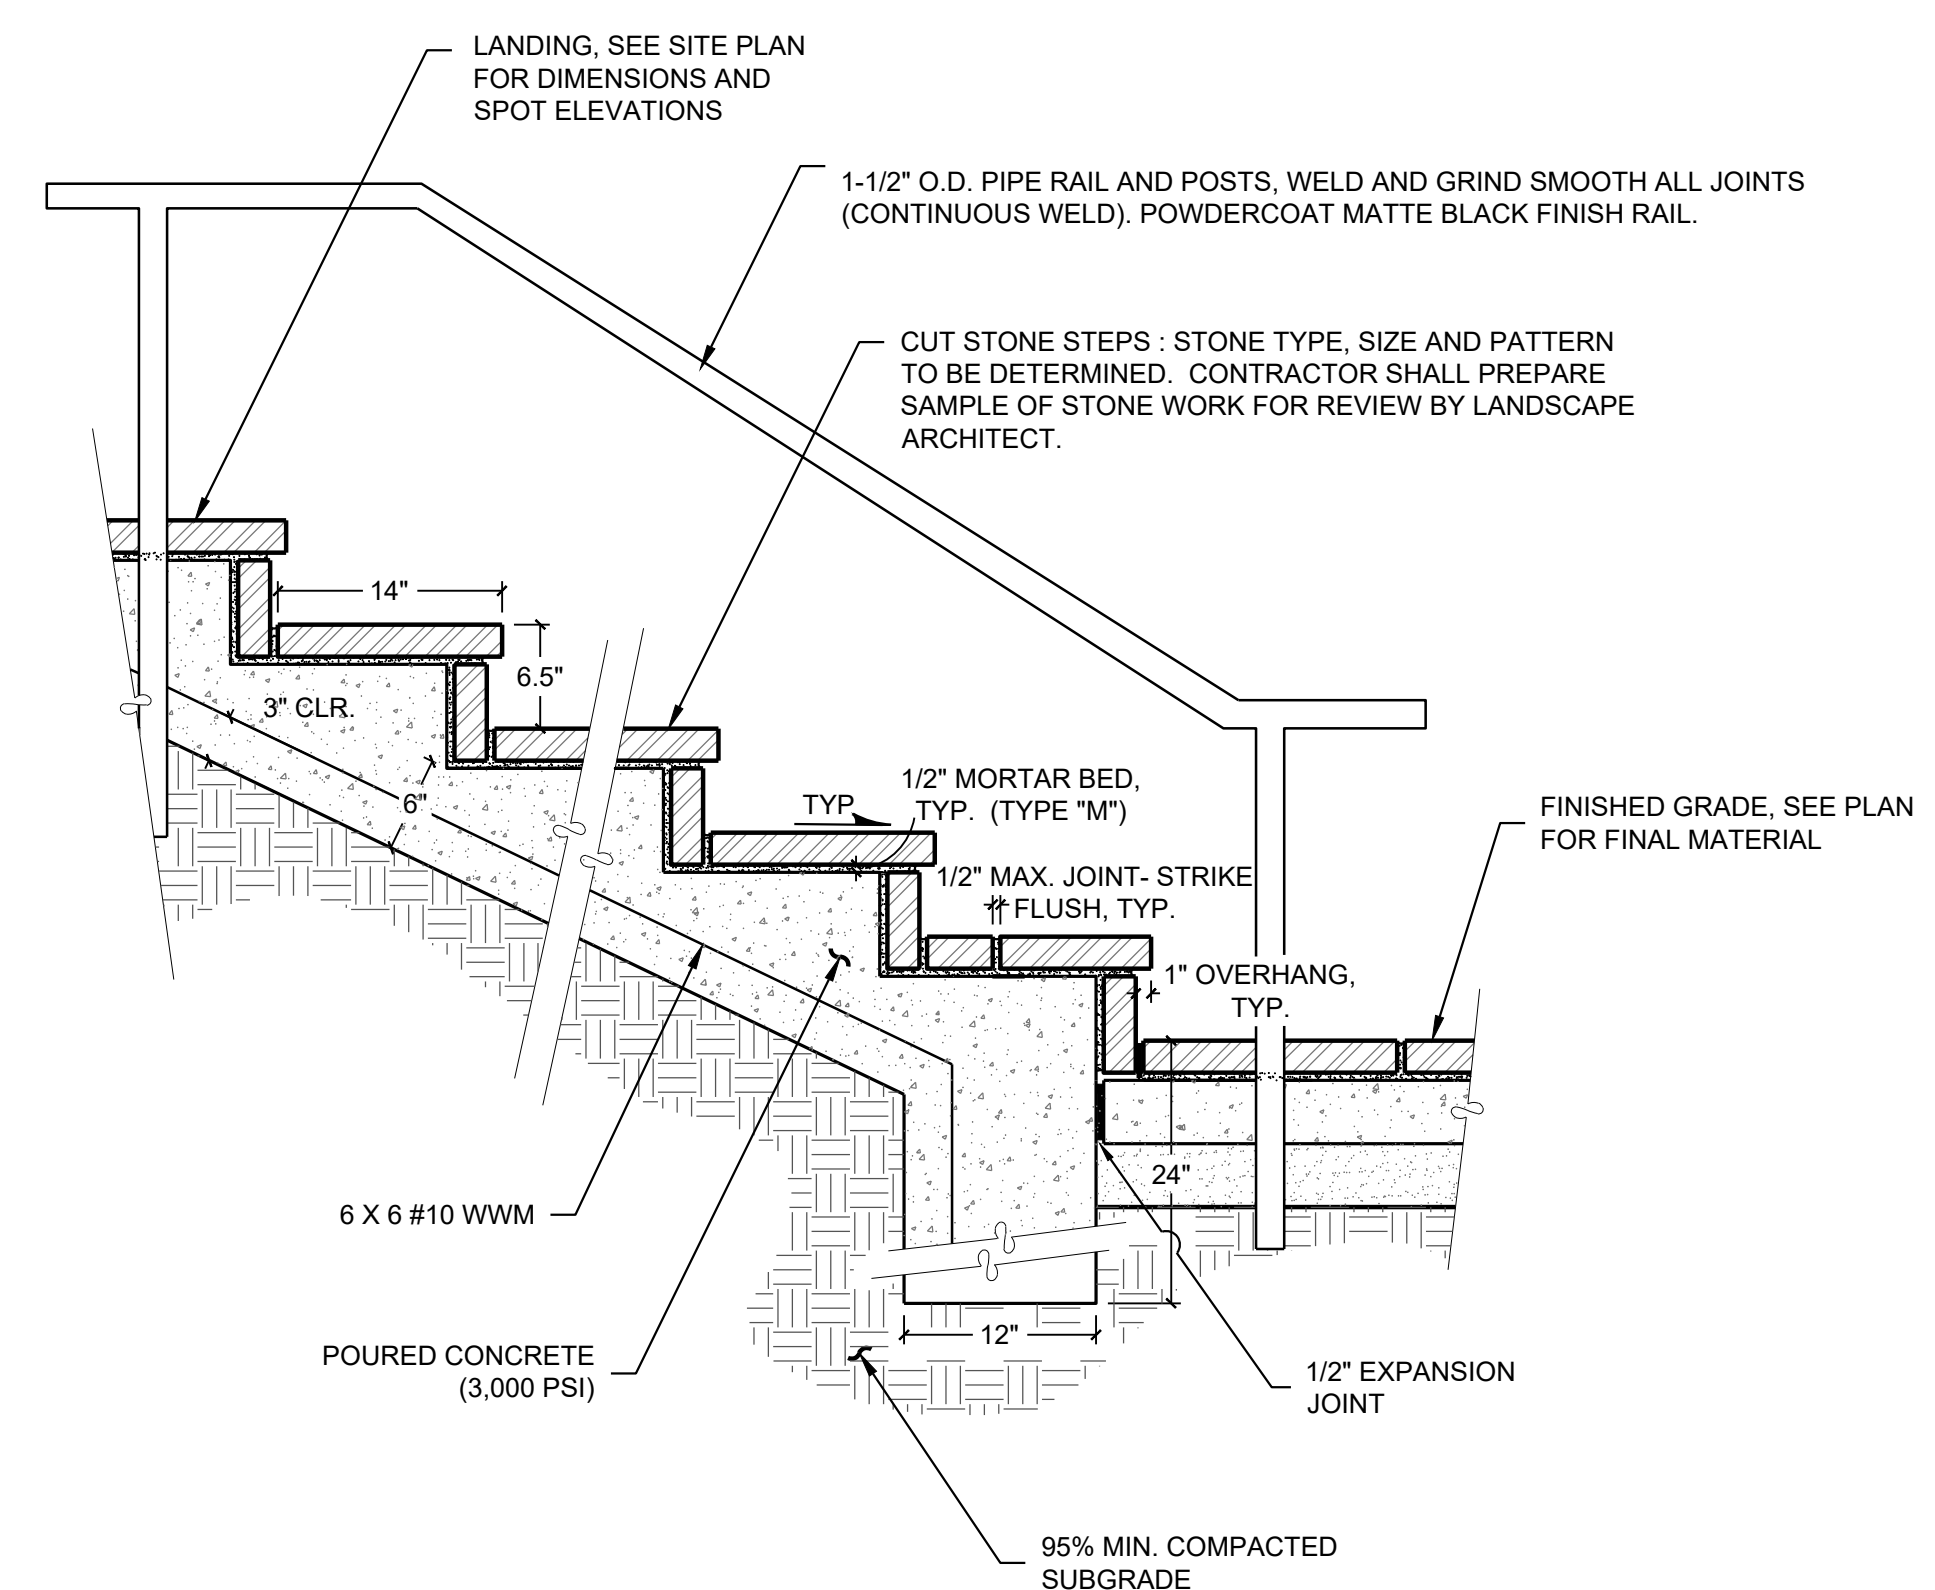
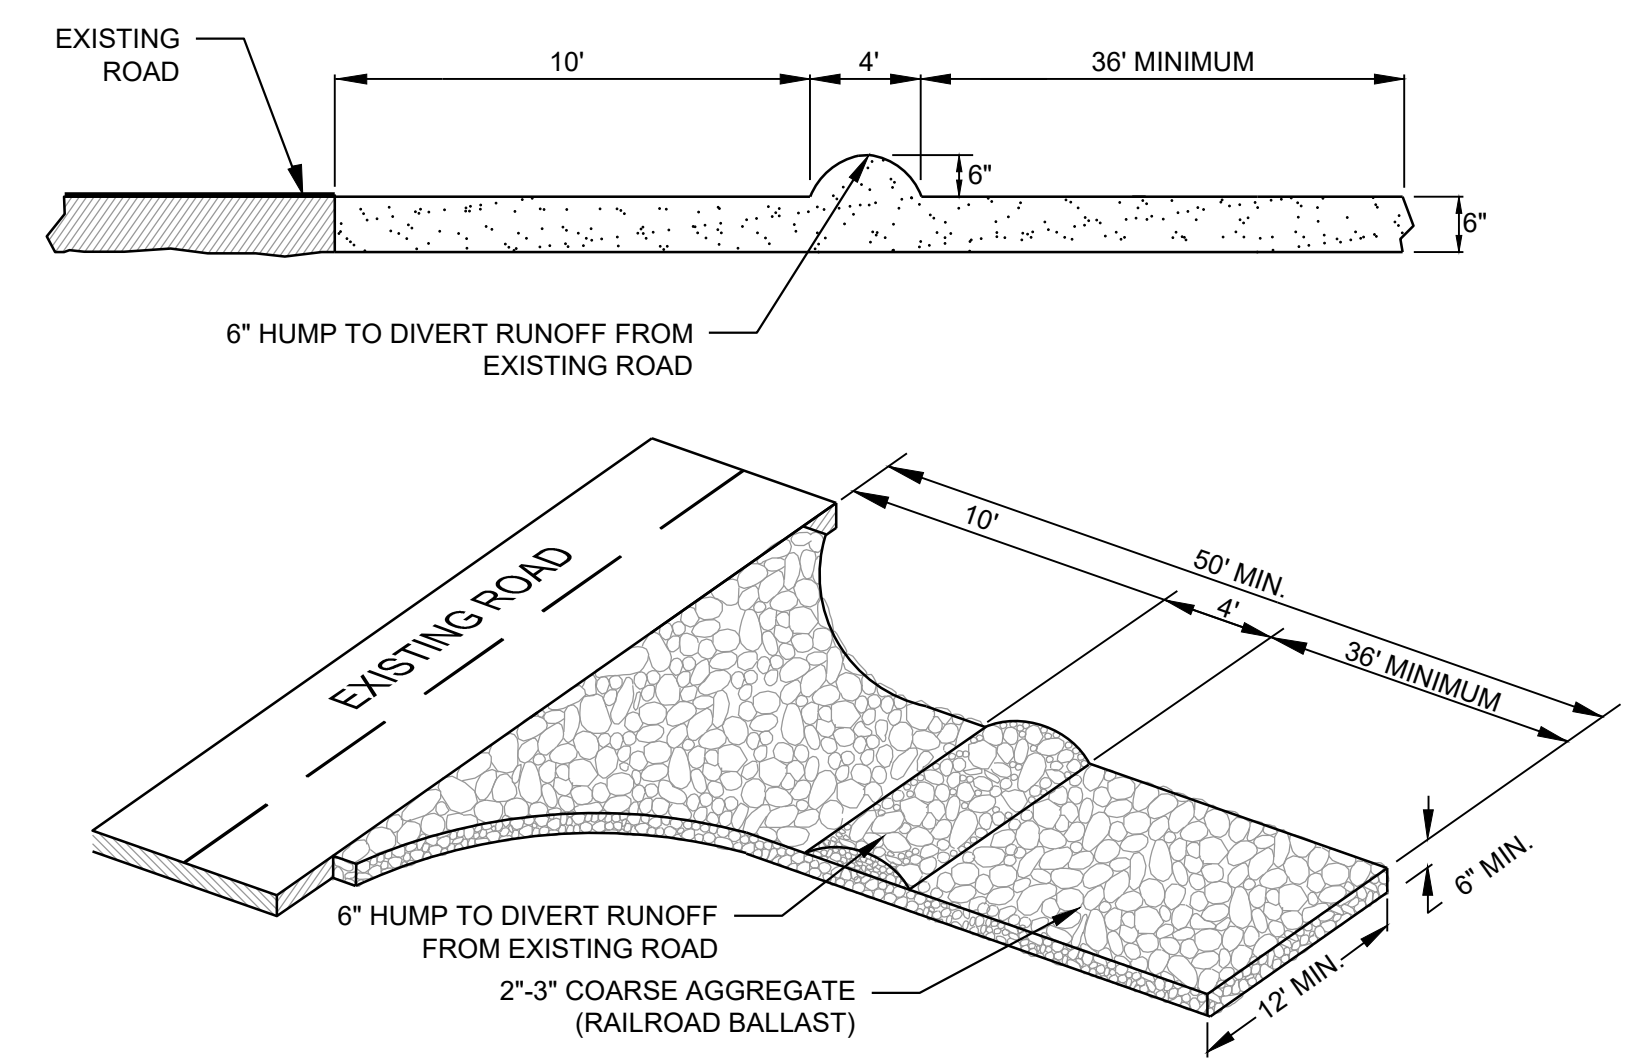
No.	Revision / Issue	Date

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SHEET TITLE:

Site Details





SHEET NO:
L4.01





SLOPE	SLOPE LENGTH (FT)	MAXIMUM AREA (SQ. FT)
<2%	100	10,000
2 TO 5%	75	7,500
5 TO 10%	50	5,000
10 TO 20%	25	2,500
>20%	15	1,500

- NOTES:
- FILTER BARRIERS SHALL BE INSPECTED IMMEDIATELY AFTER EACH RAINFALL AND DAILY DURING PROLONGED RAINFALL. REPAIR SHALL BE MADE AS NECESSARY.
 - FABRIC SHALL BE REPLACED PROMPTLY IF FOUND TO BE IN DISREPAIR.
 - SEDIMENT DEPOSITS SHALL BE REMOVED AFTER EACH STORM EVENT AND WHEN DEPOSITS REACH APPROXIMATELY 1/3 HEIGHT OF BARRIER.
 - REFERENCE NODAQ LAND QUALITY SECTION DESIGN MANUAL: 6.62
 - ALL AREAS WITHIN TROUT BUFFERS SHALL RECEIVE DOUBLE ROW OF SILT FENCE (TYP.)


- NOTES:
- TREE PROTECTION SHALL BE PROVIDED AS SHOWN IN DETAIL. BARRIER SHALL BE ERECTED PRIOR TO ANY CONSTRUCTION IN GENERAL AREA OF TREES TO BE PROTECTED.
 - TREES AND CLUSTERS OF TREES SHALL BE MARKED AND PHYSICALLY PROTECTED FROM PARKING, STORAGE, OF MATERIALS AND SECONDARY UTILITY LINE LOCATIONS.
 - EXISTING VEGETATION REMAINING AFTER GRUBBING FOR BUILDING PADS, STRUCTURES, RIGHT-OF-WAY, PARKING AREAS AND SIGNIFICANT GRADE CHANGES SHALL BE PROTECTED DURING THE CONSTRUCTION PROCESS OF THE DEVELOPMENT.
 - BARRIERS TO REMAIN IN PLACE UNTIL ALL PAVING, CONSTRUCTION AND HEAVY EQUIPMENT IS OUT OF AREA.
 - UPRIGHTS - 4 X 4 POST OR WOOD FENCE POST ON 8' MINIMUM CENTERS.
 - HORIZONTALS - 1" X 6" SOUTHERN YELLOW PINE.

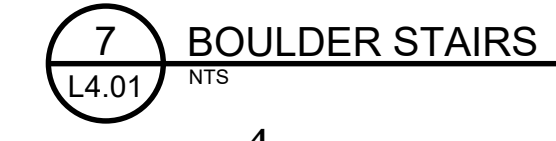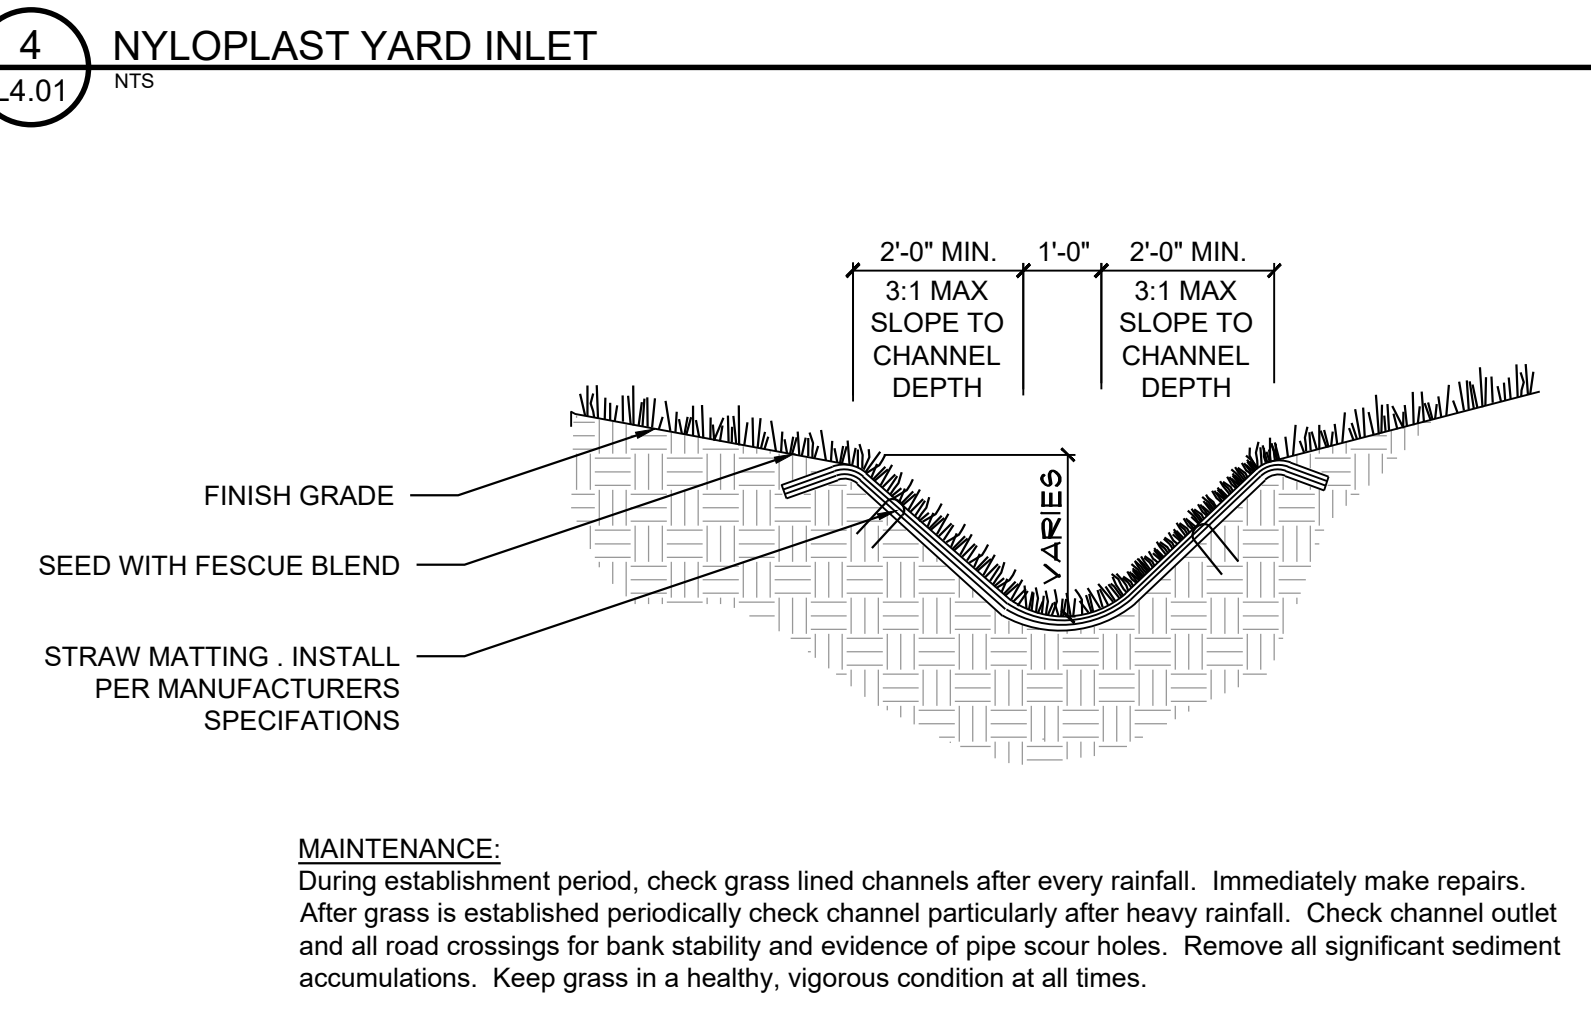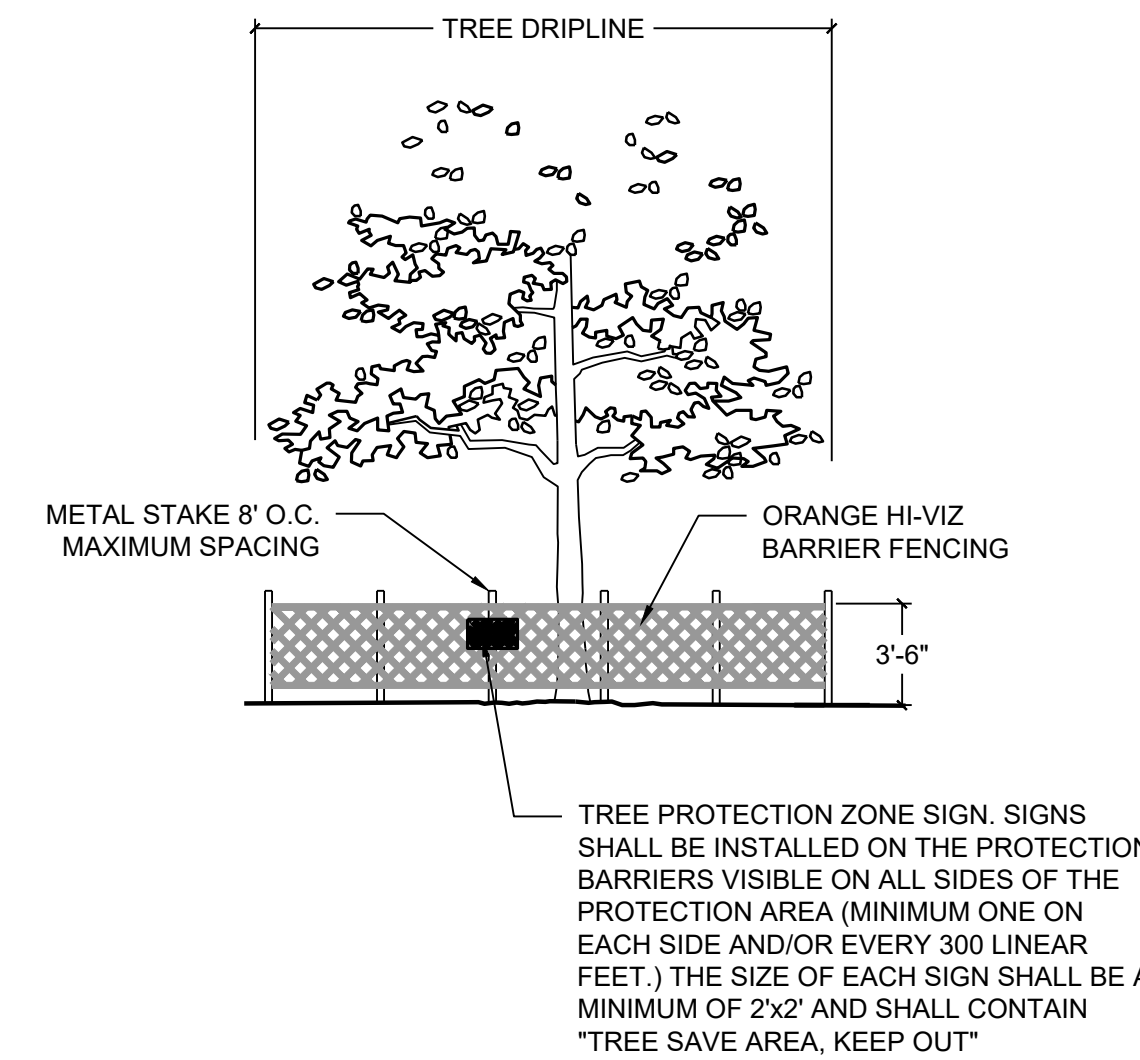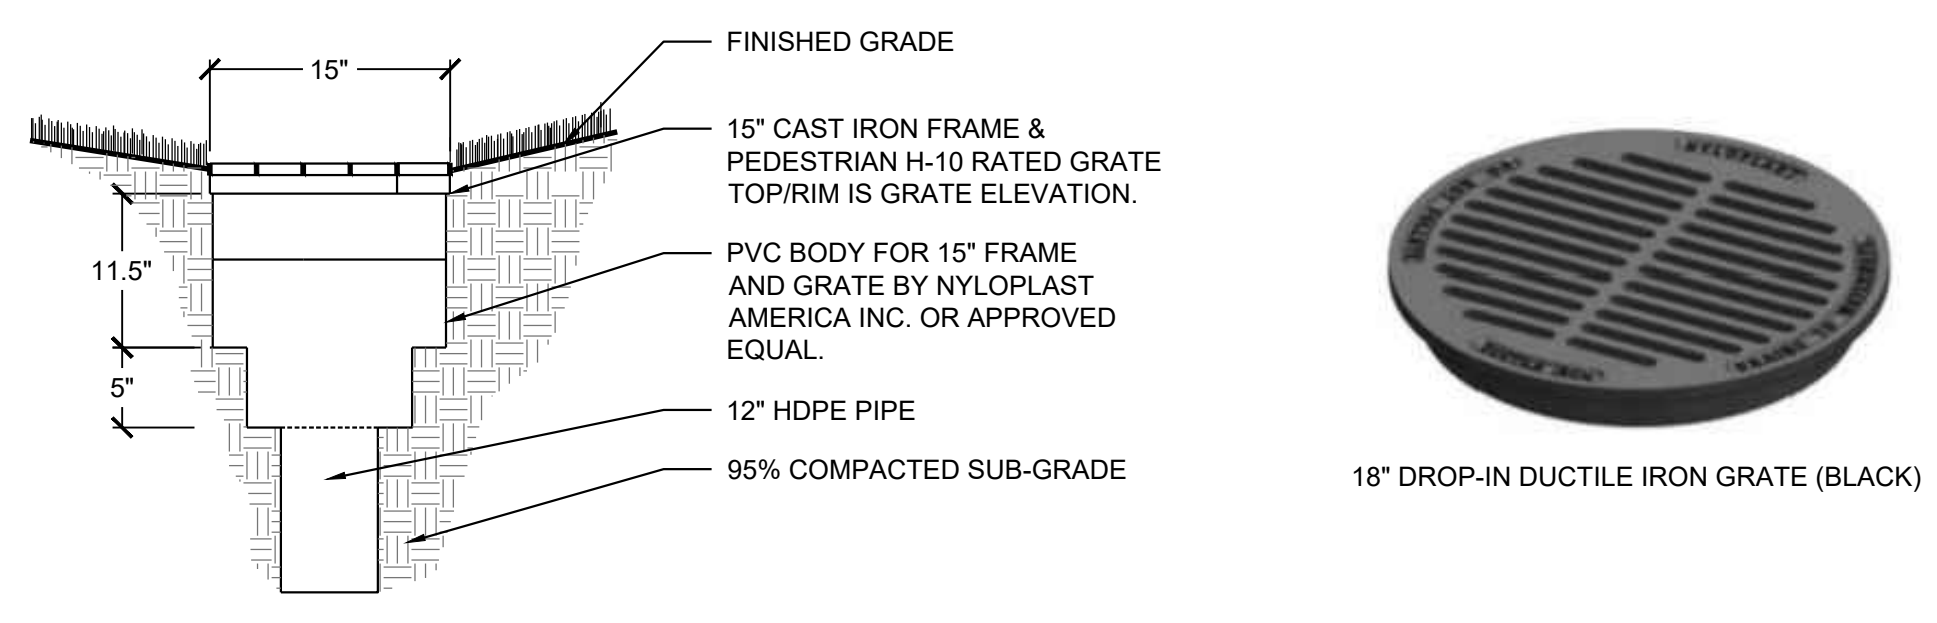


NOTES
 1. CUT OUT & REMOVE UNSUITABLE SUBGRADE AS NECESSARY, REPLACE WITH ACCEPTABLE BACKFILL AND COMPACT TO 95% STANDARD PROCTOR.
 2. CONTRACTOR TO PROVIDE POSITIVE DRAINAGE AWAY FROM ALL STRUCTURES, ALL WALKS TO HAVE A MINIMUM CROSS SLOPE OF 1.0%.
 3. CONTRACTOR TO PROVIDE A 5'x5' MOCK UP FOR APPROVAL BY DESIGN TEAM.

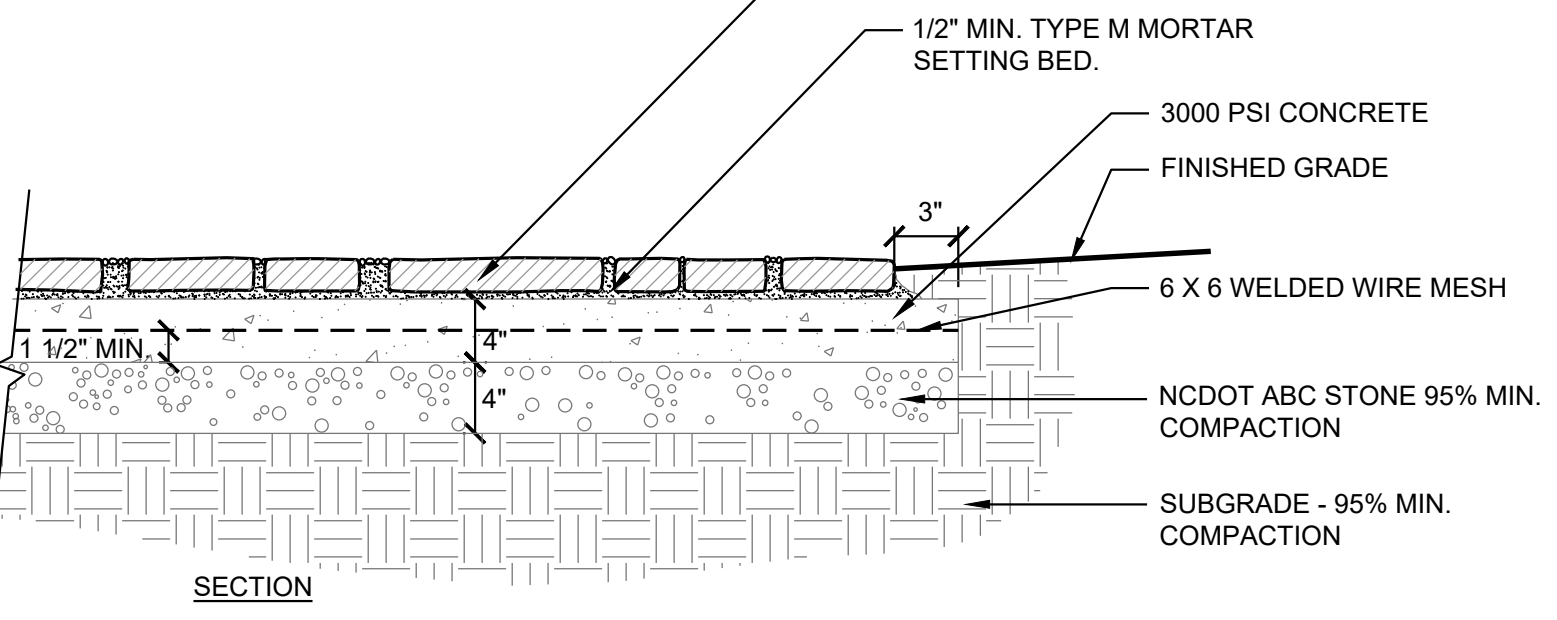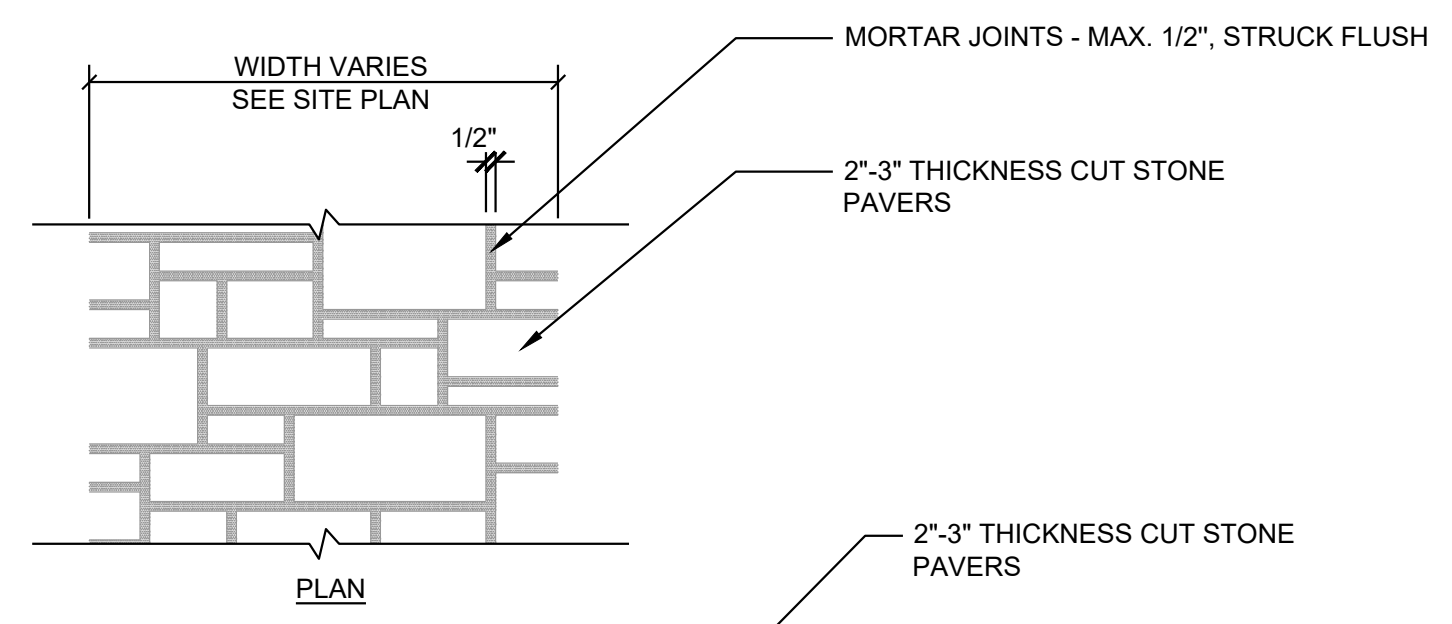

1 CUT STONE PAVING
 L4.02 NTS

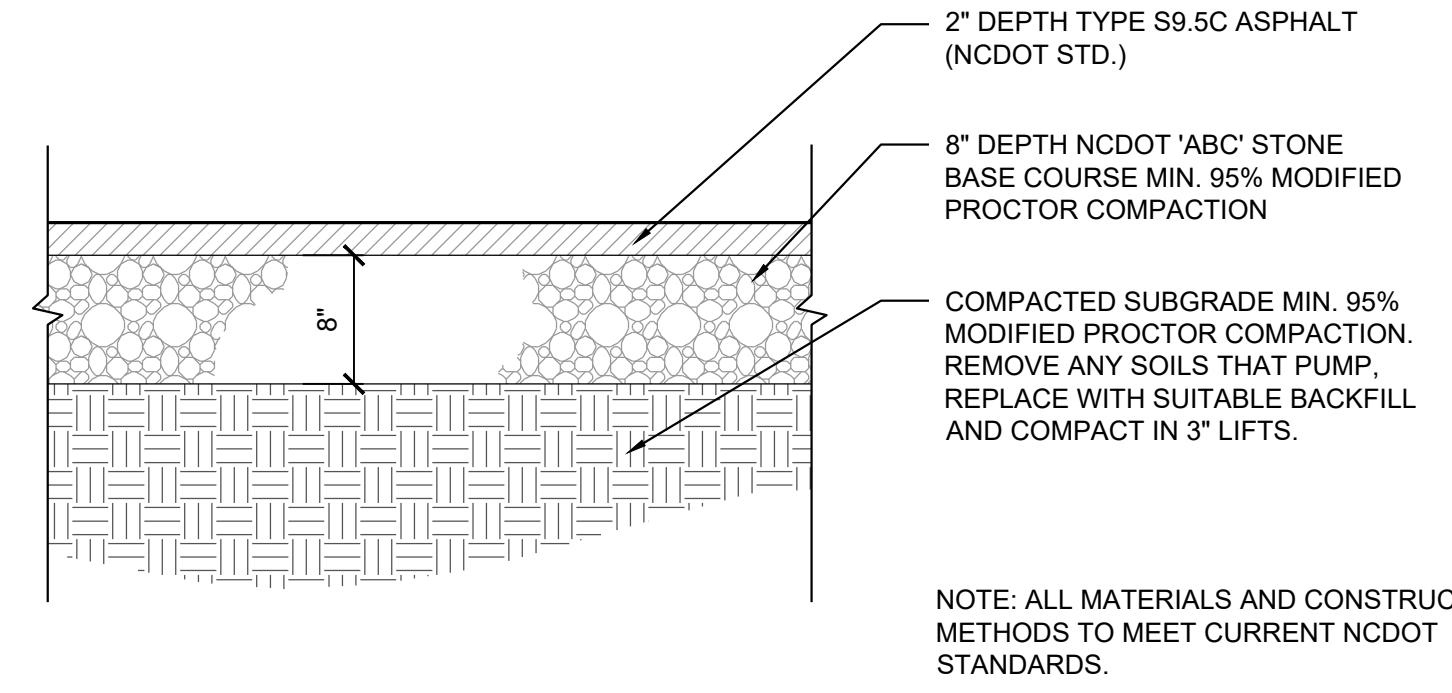


2 ASPHALT PAVING
 L4.02 NTS

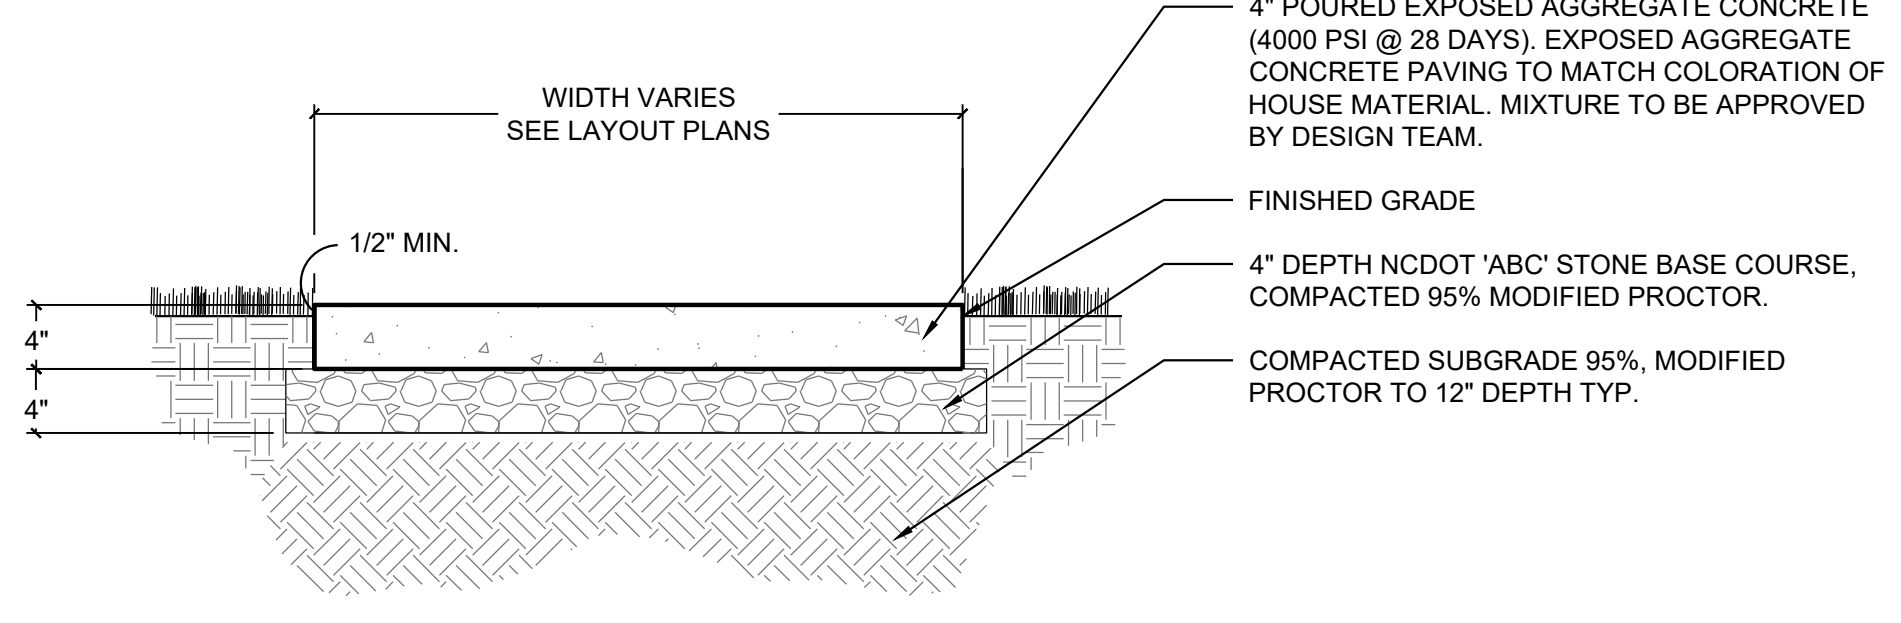


NOTE:
 1. TOOLED CONTRACTION JOINTS, 1" DEPTH, MIN. DISTANCE BETWEEN JOINTS 5'-0" TYP.
 2. EXPANSION JOINTS ARE TO OCCUR A MIN. OF 50' O.C., OTHER JOINTS MAY OCCUR AS CONTRACTION JNTS. FILL 1/2" EXPANSION JOINT WITH FLEXIBLE BOND, BOARD, OR GROUT AS APPROVED BY LANDSCAPE ARCHITECT.
 3. TYPICAL WIDTH OF CONCRETE SIDEWALKS ARE 8".
 4. CONTRACTION JOINTS ARE TO OCCUR AT A MIN. OF 5' O.C.
 5. ALL PAVING TO BE STAKED AND FINAL LAY OUT IN THE FIELD BY LANDSCAPE ARCHITECT.

3 EXPOSED AGGREGATE CONCRETE
 L4.02 NTS

NOTES
 1. CUT OUT & REMOVE UNSUITABLE SUBGRADE AS NECESSARY, REPLACE WITH ACCEPTABLE BACKFILL AND COMPACT TO 95% STANDARD PROCTOR.
 2. CONTRACTOR TO PROVIDE POSITIVE DRAINAGE AWAY FROM ALL STRUCTURES, LOW POINTS THAT HOLD WATER SHALL BE RESET TO PROVIDE ADEQUATE DRAINAGE.
 3. FOR DRIVEWAY THRESHOLDS, INSTALL A SINGLE ROW OF BOULDERS NOT LESS THAN 2' WIDE CURB FACE TO CURB FACE.

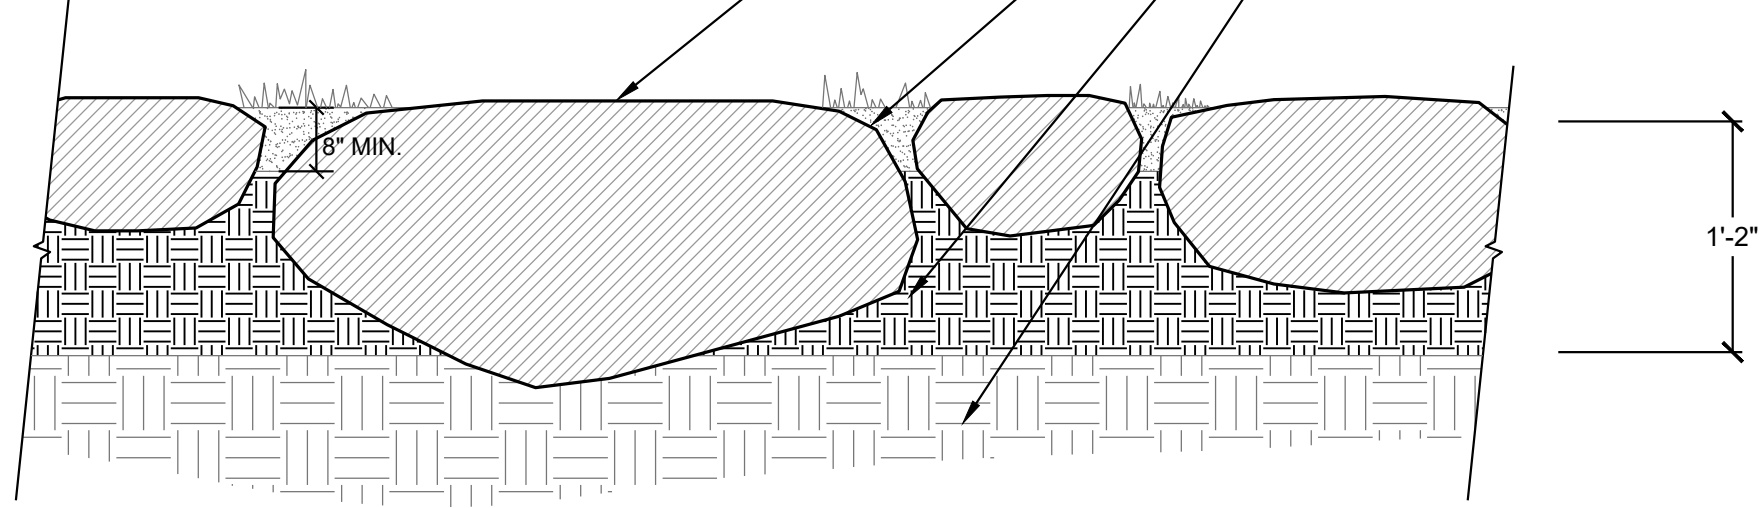


5 BOULDER WALK / PAVING / LANDING / THRESHOLD
 L4.02 NTS

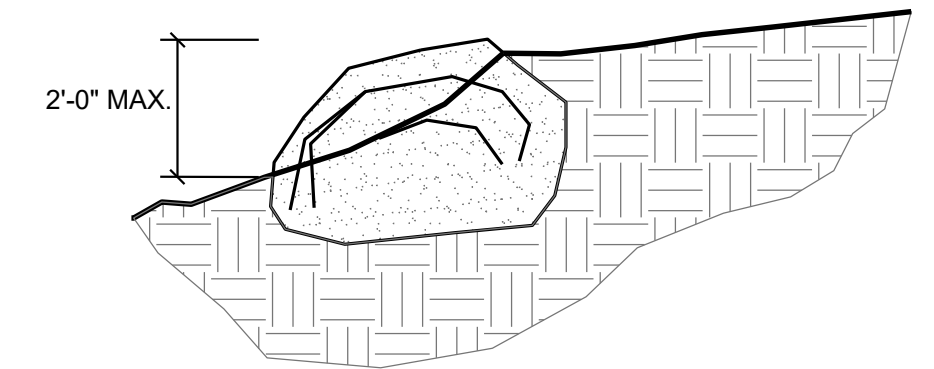


NOTES:
 1. BOULDERS TO BE NATIVE, WEATHERED FIELDSTONE.
 2. RECEIVE LANDSCAPE ARCHITECTS APPROVAL OF BOULDERS PRIOR TO INSTALLATION.
 3. BOULDER PLACEMENT TO BE DIRECTED IN FIELD BY LANDSCAPE ARCHITECT.
 4. MINIMUM BOULDER DIMENSIONS TO BE 30"-48" X 24"-36"
 5. COUNTERSINK BOULDER INTO GROUND 1/2 - 2/3 OF BOULDER HEIGHT.
 6. ADJACENT BOULDERS TO BE PLACED TO MINIMIZE GAPS.
 7. BOULDERS TO EMULATE ROCK OUTCROPS

6 BOULDER GRADE CHANGE
 L4.02 NTS

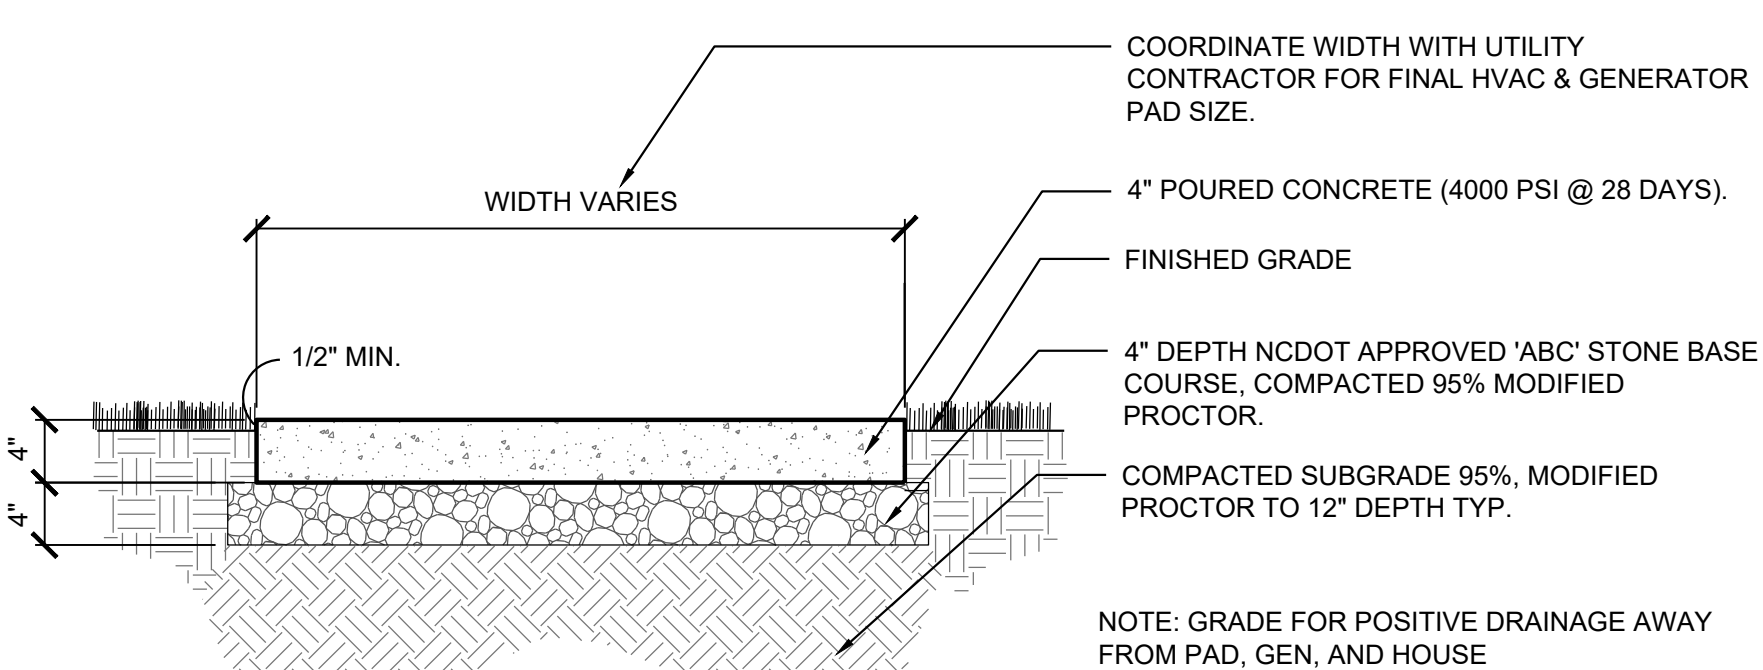


7 HVAC / GENERATOR / HEAT PUMP PAD
 L4.02 NTS

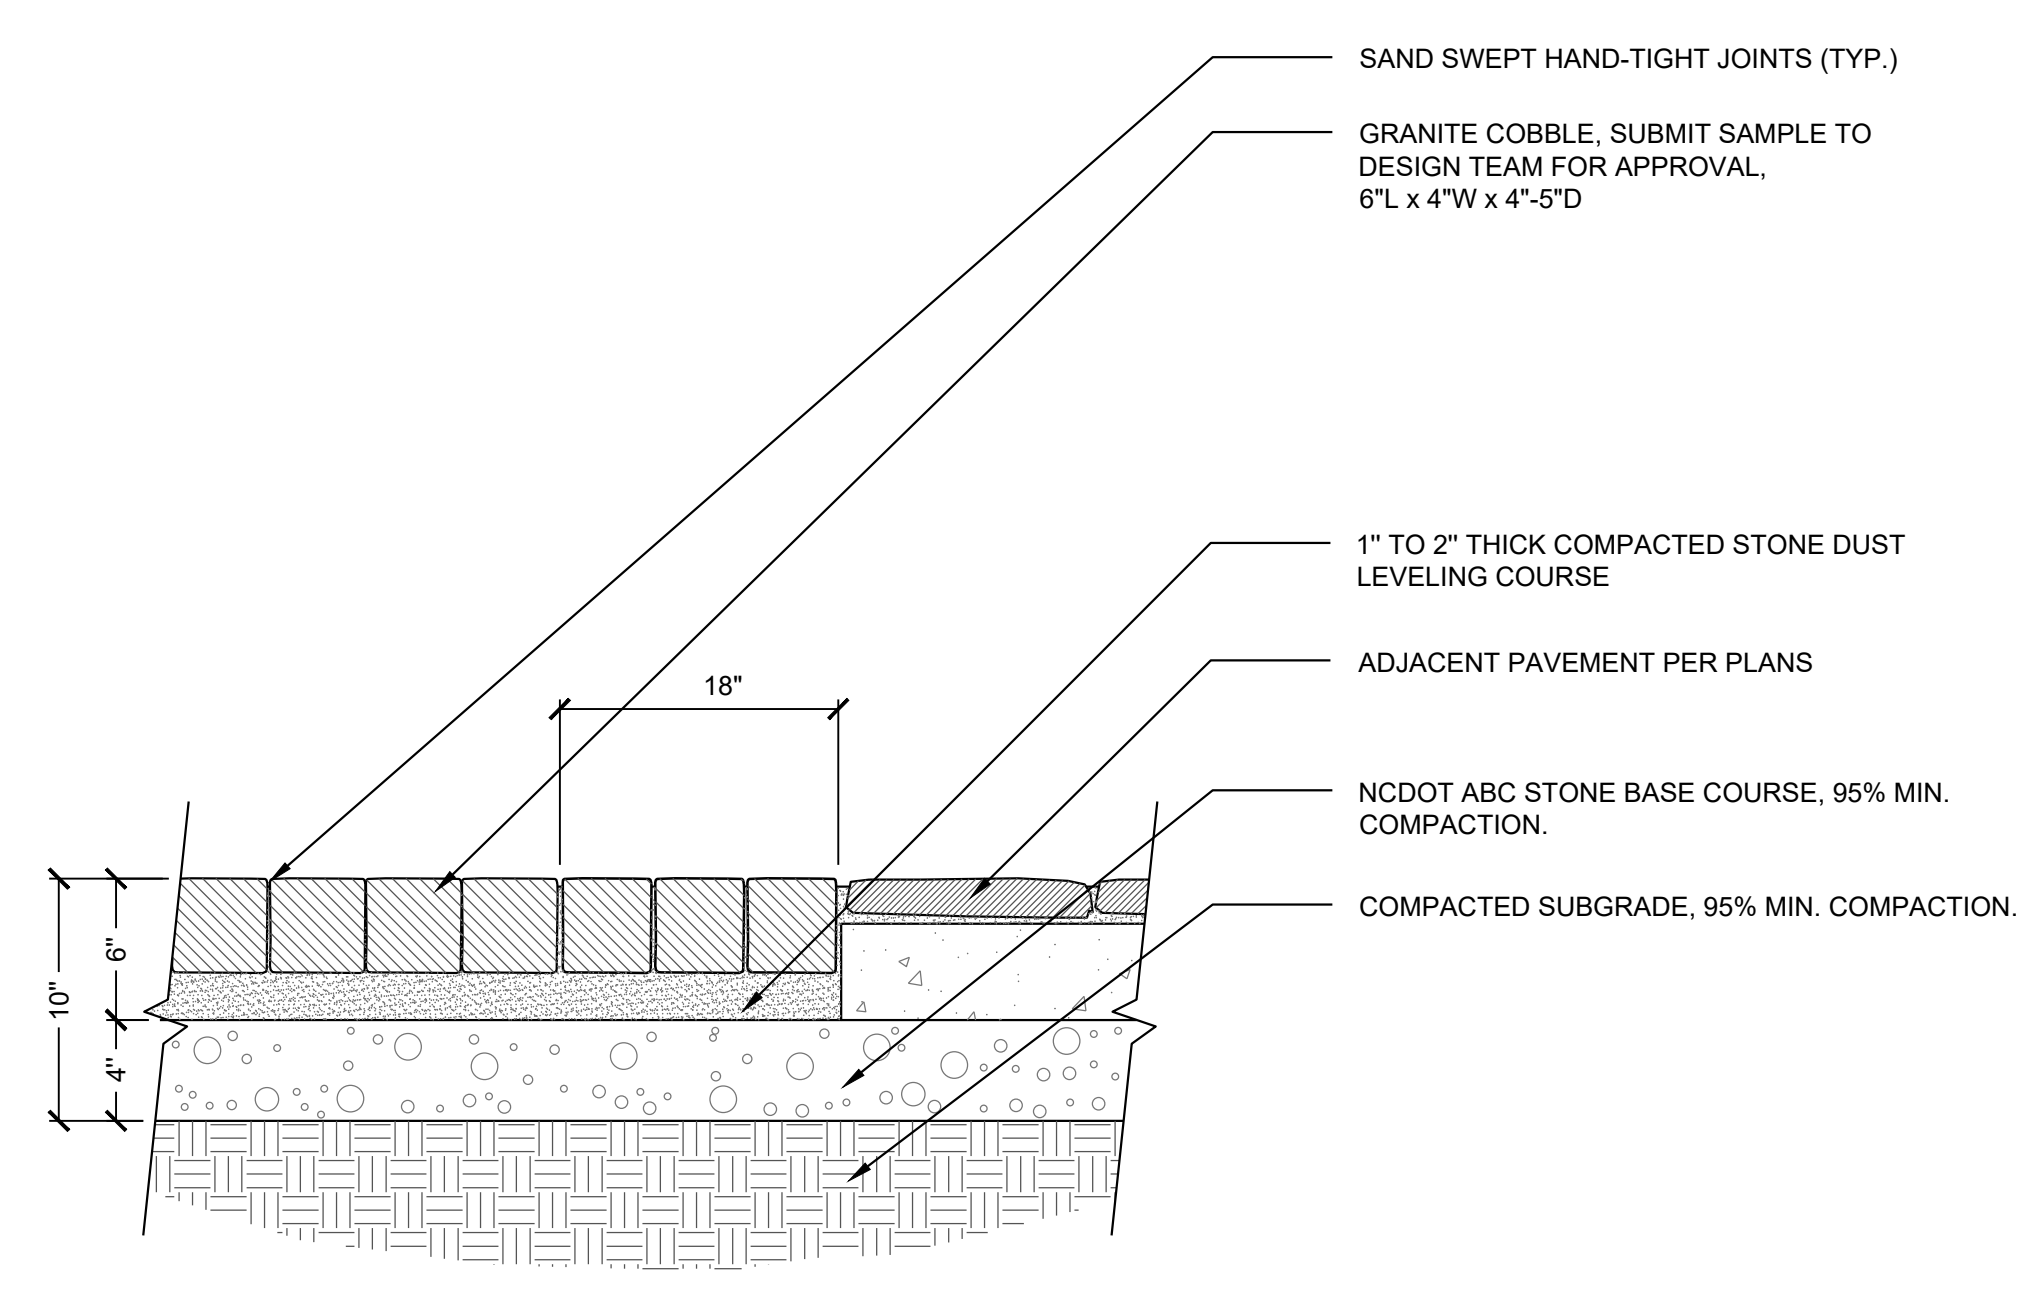

4 GRANITE COBBLE PAVING
 L4.02 NTS

IMPORTANT: THE GAS LINE AND RELATED EQUIPMENT FOR STARTING WOOD FIRES WILL BE SUBJECT TO HIGH TEMPERATURES AND OPEN FLAMES. THIS EQUIPMENT SHALL BE SPECIFIED AND INSTALLED BY QUALIFIED PERSONNEL TO ASSURE THE SAFETY OF OPERATORS AND THE GENERAL PUBLIC.

NOTES:
 1) CONTRACTOR TO PROVIDE A MINIMUM 1.0% SLOPE TO INLET.
 2) GAS LINE AND RELATED EQUIPMENT TO BE INSTALLED PER ALL APPLICABLE CODES.
 3) CONTROL VALVE(S) FOR THE GAS LINE ARE TO BE LOCATED REMOTELY FROM THE FIRE PIT WITHIN A SECURE LOCKABLE BOX.

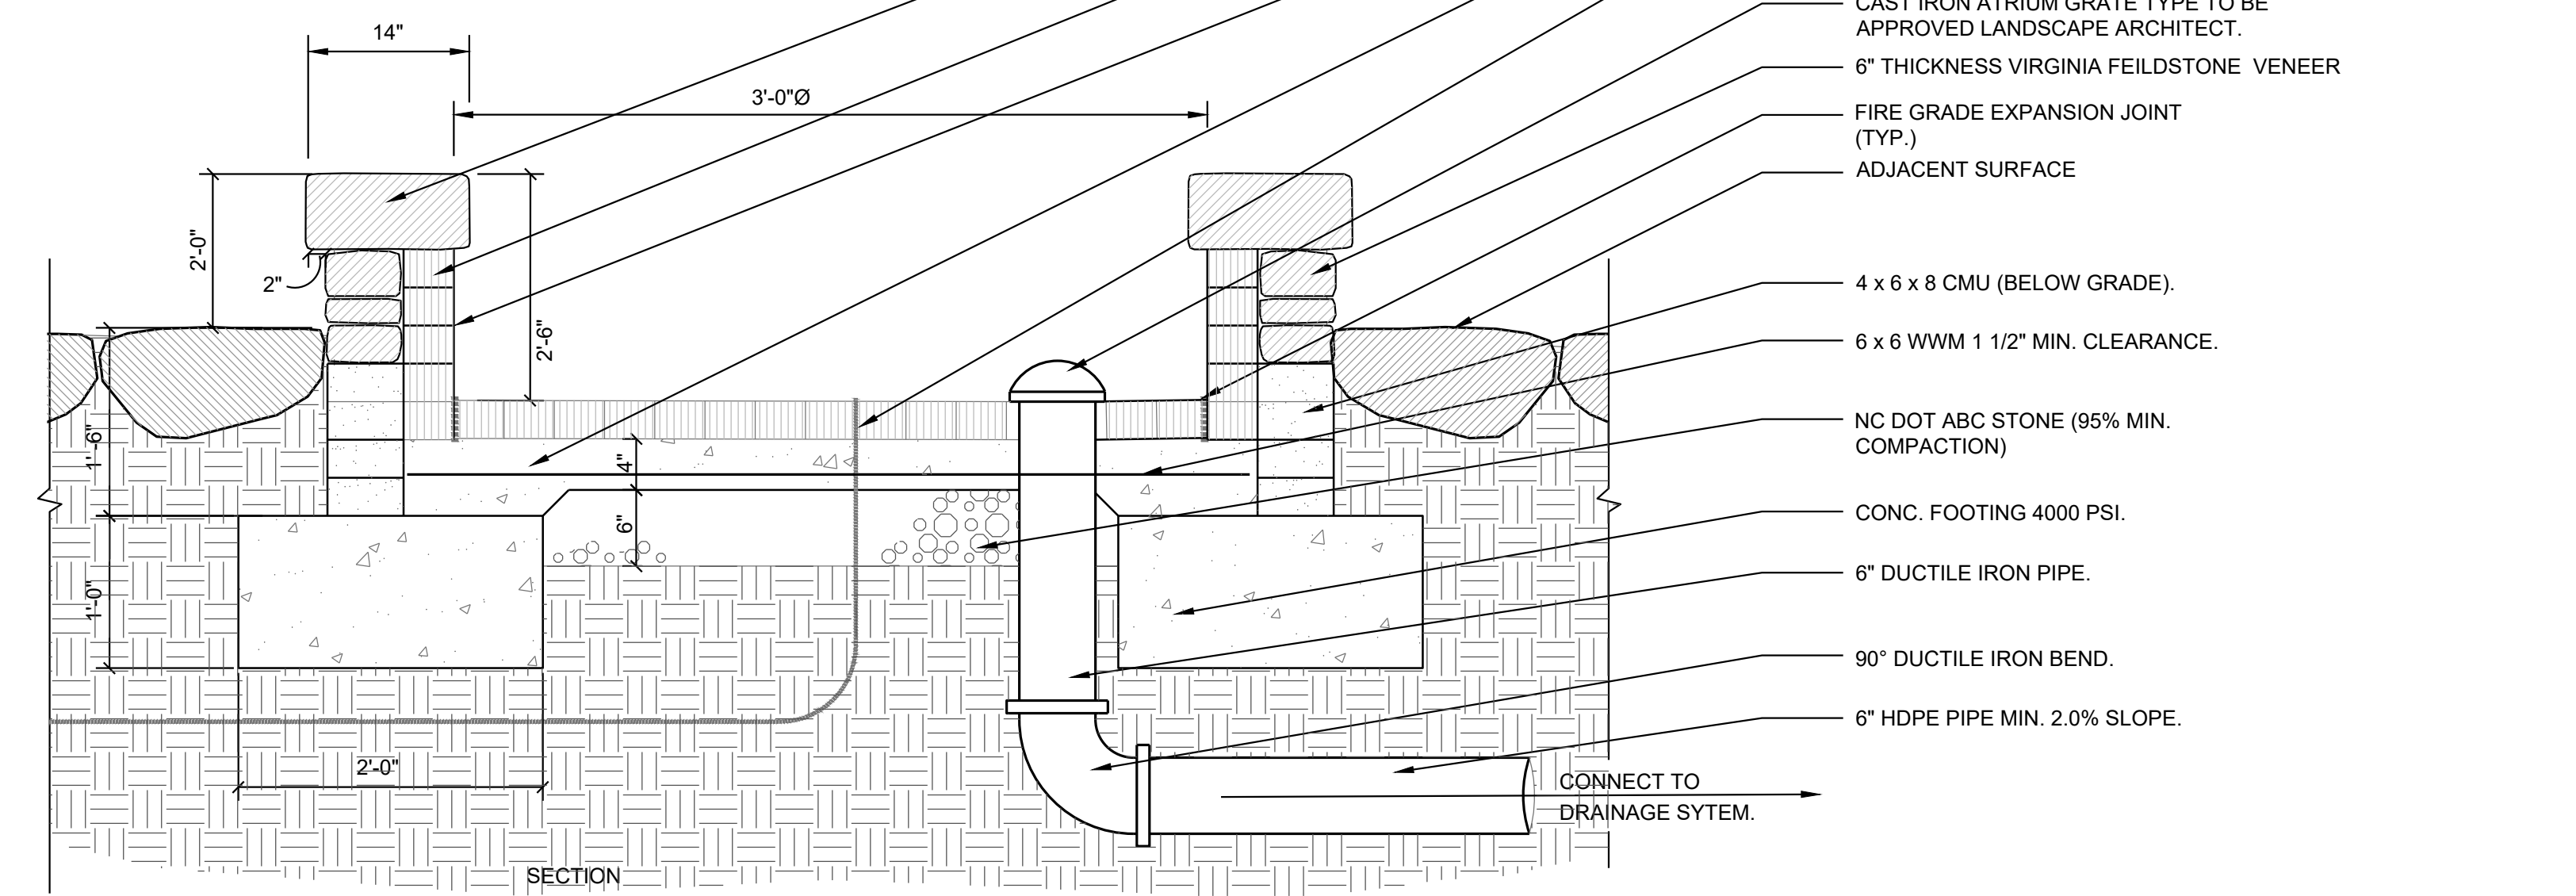

8 STONE FIRE PIT
 L4.02 NTS


SEAL:
 NORTH CAROLINA PROFESSIONAL LANDSCAPE ARCHITECT
 #C-473
 NORTH CAROLINA PROFESSIONAL LANDSCAPE ARCHITECT
 #1261

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WEILBAECHER RESIDENCE
 414 VANDERBILT ROAD, BILTMORE FOREST, NC 28803 - BUNCOMBE COUNTY
FUSCO LAND PLANNING & DESIGN, PLLC
 LANDSCAPE ARCHITECTURE | CONSERVATION PLANNING | LOW IMPACT DEVELOPMENT
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15 TREES TO BE REMOVED:

PROTECTED TREES	UNPROTECTED TREES	REQUIRED REPLACEMENTS
267 36" OAK	374 42" OAK - DAMAGED	33 TREES REQUIRED
272 20" CEDAR	390 20" PIN - DAMAGED	54 TREES PROVIDED
464 28" OAK	406 14" HEMLOCK - ADELGID	
567 24" POPLAR	407 28" PINE - DAMAGED	
	459 08" CEDAR - ONE SIDE DAMAGED	
	460 24" PINE - DAMAGED	
	470 12" HEMLOCK - ADELGID	
	471 06" HEMLOCK - ADELGID	
	473 12" PINE - DAMAGED	
	568 08" PINE - DAMAGED	
	476 12" PINE - DAMAGED	

SEAL:

DRAWN BY: NAT
CHECKED BY: MJF

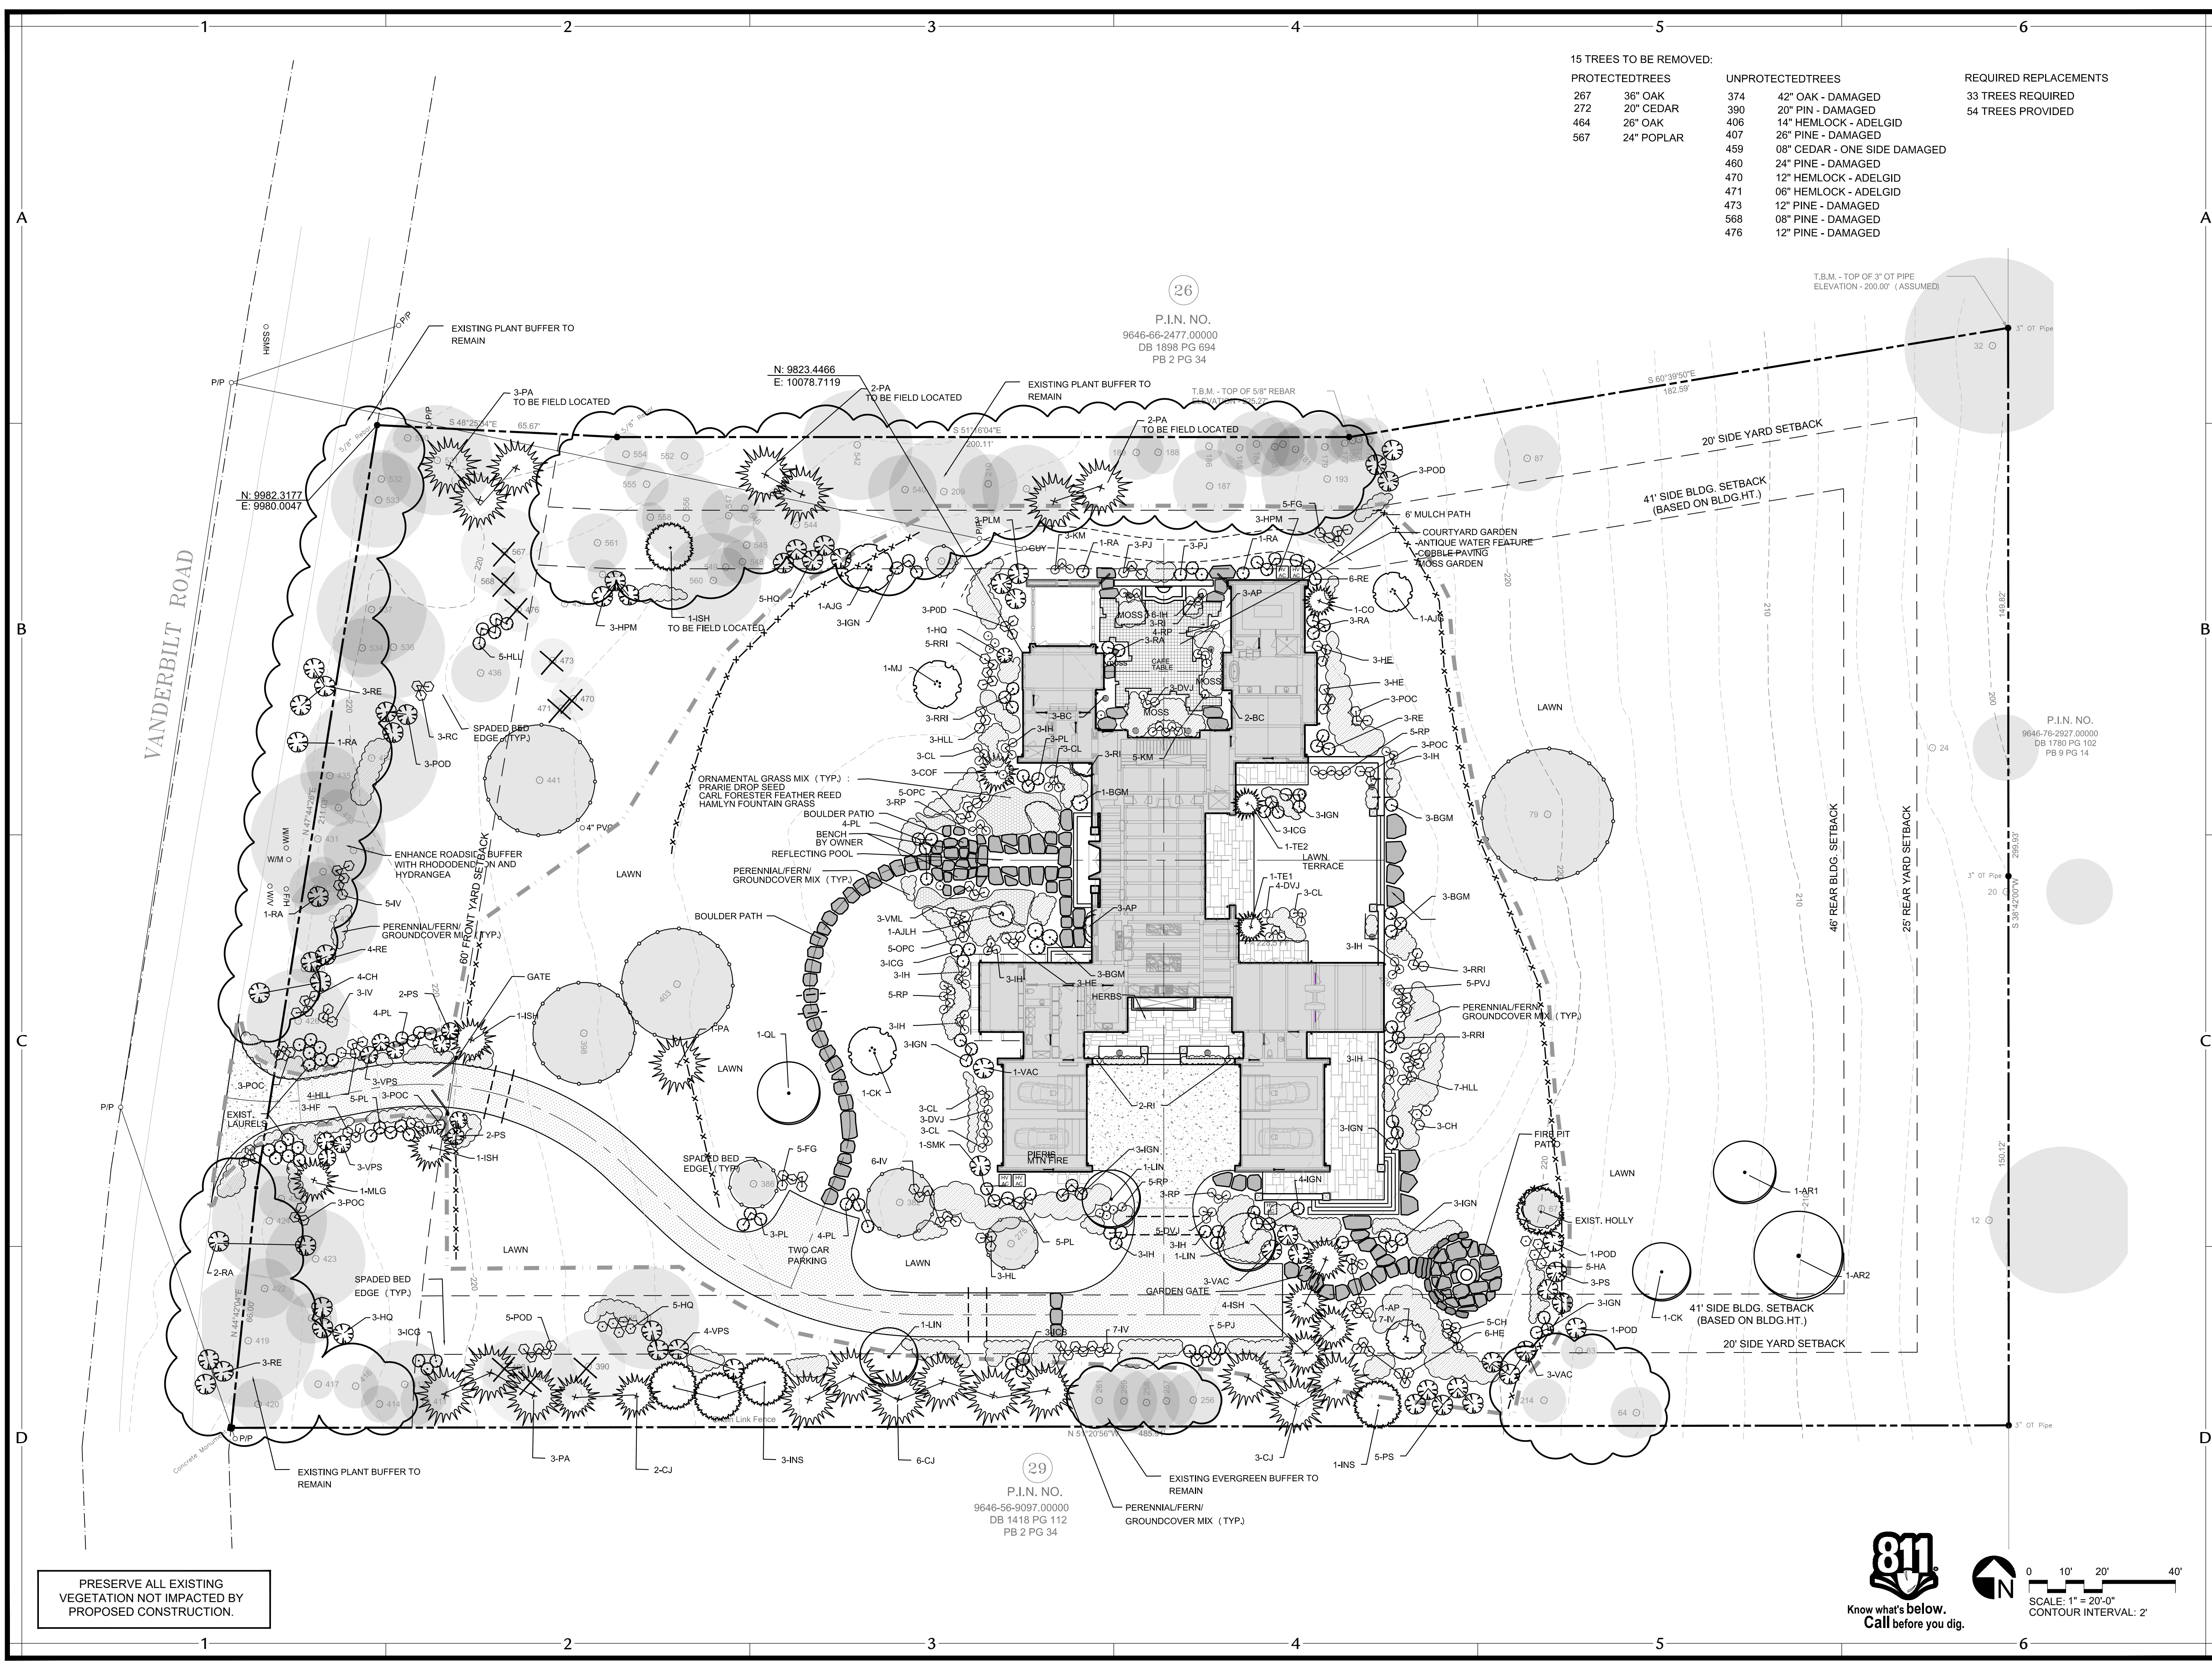WEILBAECHER RESIDENCE
414 VANDERBILT ROAD, BILTMORE FOREST, NC 28803 - BUNCOMBE COUNTY

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SHEET TITLE:
Landscape Plan

SHEET NO:
L5.01

PRESERVE ALL EXISTING VEGETATION NOT IMPACTED BY PROPOSED CONSTRUCTION.

SCALE: 1" = 20'-0"
CONTOUR INTERVAL: 2'

PLANT LIST

SYM.	BOTANICAL NAME	COMMON NAME	QTY.	SPECIFICATIONS
CANOPY TREES				
AR1	Acer rubrum 'Red Sunset'	Red Sunset Maple	1	3.5" Cal. - B&B - Single, straight leader - Dense, full plant
AR2	Acer rubrum 'Red Sunset'	Red Sunset Maple	1	2.5" Cal. - B&B - Single, straight leader - Dense, full plant
QL	Quercus lyrata	Overcup Oak	1	3.5" Cal. - B&B - Single, straight leader - Dense, full plant
EVERGREEN TREES				
CO	Chamaecyparis obtusa	Hinoki Cypress	2	6' - 8'
CJ	Cryptomeria japonica	Japanese Cryptomeria	11	10' - 12' ht. - B&B - Dense, full plant
INS	Ilex x 'Nellie Stevens Holly'	Nellie Stevens Holly	4	8' - 10' ht. - B&B - Dense, full plant
ISH	Ilex x 'Saty' 'Hill Holly'	'Saty' Hill' Holly	8	6' - 8' ht. - B&B - Dense, full plant
PA	Picea 'abies'	Norway Spruce	11	8' - 10' ht. - B&B - Dense, full plant
MLG	Magnolia x 'Little Gem'	Little Gem Magnolia	1	5'-6" ht. - B&B - Dense, full plant
TE1	Thuja x 'Emerald'	Emerald Arborvitae	1	8' - 10' ht. - B&B - Dense, full plant
TE2	Thuja x 'Emerald'	Emerald Arborvitae	1	10'-12' ht. - B&B - Dense, full plant
SMALL FLOWERING TREES				
AP	Aesculus pavia	Red Buckeye	1	4' - 5' Hgt. multi stemmed (3 min.) - Specimen
AUG	Acer japonica 'Green Leaf'	Green Leaf Japanese maple	2	8' - 10' Hgt. multi stemmed (3 min.) - Specimen
AJLH	Acer japonica 'Lions Head'	Lions Head Japanese maple	1	4' - 5' Hgt. multi stemmed (3 min.) - Specimen
CK	Cornus kousa	Kousa Dogwood	3	7' - 8' ht. - B&B - Multi-stemmed - 3 Leaders min. - Full plant
MJ	Magnolia x 'Jane'	Jane Saucer magnolia	2	6' - 8' Ht - Multi-stemmed - Dense, Full plant
LIN	Lagerstroemia indica 'Natchez'	Natchez Crepe Myrtle	3	10' - 12' Ht - B&B - Multi stemmed (3 min.) - Specimen
EVERGREEN SHRUBS				
BGM	Buxus 'Green Mountain'	Green Mountain Boxwood	8	7 Gal. Cont. - Dense, full plant
DVJ	Distylium 'Vintage Jade'	Vintage Jade Distylium	19	3 Gal. Cont. - Dense, full plant
IGN	Ilex glabra 'Nigra'	Dwf. Inkberry Holly	18	3 Gal. Cont. - Dense, full plant
ICG	Ilex x 'China Girl'	China Girl Holly (one China Bay)	15	3 Gal. Cont. - Dense, full plant
IH	Ilex x 'Hoogendorn'	Hoogendorn Holly	18	3 Gal. Cont. - Cont. - Dense, full plant
KM	Kalmia latifolia 'Minuet'	Minuet Mountain Laurel	9	3 Gal. Cont. - Cont. - Dense, full plant
PL	Prunus laurocerasus 'Otto Luyken'	Otto Luyken Cherry Laurel	31	5 Gal. Cont. - Cont. - Dense, full plant
PS	Prunus laurocerasus 'Schlipkaensis'	Schip Cherry Laurel	12	5 Gal. Cont. - Cont. - Dense, full plant
PJ	Pieris japonica	Japanese pieris	11	5 gal. Cont. Dense, full plant.
RE	Rhododendron catawbiense 'English Roseum'	English Roseum Rhododendron	16	24" - 30" ht. - Dense, full plant
RN	Rhododendron catawbiense 'Anna Krushke'	Anna Krushke Rhododendron	13	24" - 30" ht. - Dense, full plant
RP	Rosa x 'Pink Drift'	Pink Drift Rose	25	3 Gal cont. - Dense, full plant
RRI	Rosa x 'Ringo'	Ringo Rose	16	3 Gal cont. - Dense, full plant
DECIDUOUS SHRUBS AND VINES				
CL	Caryopteris clandonensis 'Dark Knight'	False Spirea	15	3 gal. Cont. - Dense, full plant
CH	Clethra alnifolia 'Hummingbird'	Hummingbird Clethra	12	3 Gal. Cont. - Dense, full plant
FG	Fothergilla gardenii	Dwarf Fothergilla	13	3 Gal. Cont. - Dense, full plant
HF	Hydrangea paniculata 'Firelight'	Firelight Hydrangea	10	3 Gal. Cont. - Dense, full plant
HLL	Hydrangea paniculata 'Little Lime'	Little Lime Hydrangea	35	3 Gal. Cont. - Dense, full plant
HPM	Hydrangea x 'Penny Mac'	Penny Mac Hydrangea	3	5 gal. Cont. - Dense, full plant
HE	Hydrangea 'endless Summer'	Endless Summer Hydrangea	12	3 gal Cont. - dense, full plant.
HQ	Hydrangea quercifolia 'Ruby Slippers'	Oak Leaf Hydrangea	14	3 Gal. Cont. - Dense, full plant
IV	Itea virginica 'Henry's Garnet'	Virginia Sweetspire	22	3 Gal. Cont. - Dense, full plant
VC	Vitex agnus-castus	Chaste Tree	7	5 gal. Cont. - Dense, full plant
VP	Viburnum plicatum 'Shasta'	Shasta Viburnum	10	5 gal. Cont. - Dense, full plant
HLK	Hibiscus x 'Little Kim'	Dwf. Rose of Sharon	18	3 Gal. Cont. - Dense, full plant
POC	Physocarpus opulus 'Coppertina'	Coppertina Ninebark	28	3 Gal. Cont. - Dense, full plant
POD	Physocarpus opulus 'Diablo'	Diablo Ninebark	13	5 Gal. Cont. - Dense, full plant
POD	Physocarpus opulus 'Diablo'	Diablo Ninebark	13	5 Gal. Cont. - Dense, full plant
AP	Anomala petriola	Climbing Hydrangea	11	1 Gal Cont. - Dense, full plant
RI	Rosa x 'Iceburg'	Iceburg Climbing Rose	8	1 Gal Cont. - Dense, full plant
PERENNIALS AND FERNS				
AM	Allium 'Mellenium'	Wild Onion	23	1 Gallon cont. - Dense, full plant
AA	Aster x 'Winston Churchill'	Winston Churchill Aster	22	1 Gallon cont. - Dense, full plant
AN	Aster novae-angliae	New England Aster	15	1 Gallon cont. - Dense, full plant
CZ	Chrysanthemum x superbum	Shasta Daisy	35	1 Gallon cont. - Dense, full plant
CS	Coreopsis verticillata 'Zagreb'	Threadleaf Coreopsis	60	1 Gallon cont. - Dense, full plant
DG	Dianthus gratianopolitanus	Cheddar Pinks 'Bath's Pink'	45	1 Gallon cont. - Dense, full plant
DP	Demastodia punctiloba	Hay-Scented Fern	75	1 Gallon cont. - Dense, full plant
DE	Dryopteris erythrosora	Autumn Fern	30	1 gallon cont. - Dense full plant
EP	Echinacea purpurea	Purple Coneflower	12	1 Gallon cont. - Dense, full plant
HL	Hermercallis liliaceae	Daylily	12	1 Gallon cont. - Dense, full plant
IS	Iberis sempervirens 'Purity'	Candytuft	25	1 Gallon cont. - Dense, full plant
ICB	Iris siberica 'Caesars Brother'	Siberian Iris	15	1 Gallon cont. - Dense, full plant
IIC	Iris siberica 'Ice Castles'	Siberian Iris	15	1 Gallon cont. - Dense, full plant
LS	Liatris spicata 'Kabold'	Spike Gayfeather	12	1 Gallon cont. - Dense, full plant
PAC	Polystichum acrostichoides	Christmas Fern	25	1 Gallon cont. - Dense, full plant
CK	Calamagrostis x actiflora 'Stricta'	Karl Forester Reed Grass	15	1 Gallon cont. - Dense, full plant
PSB	Phlox subulata	Moss Phlox 'Blue'	22	1 Gallon cont. - Dense, full plant
RF	Rudekia fulsida 'Goldstrum'	Blackeyed Susan	34	1 Gallon cont. - Dense, full plant
SF	Solidago x 'Fireworks'	Fireworks Golden Rod	22	1 Gallon cont. - Dense, full plant
TH	Thymus	Creeeping Thyme	25	1 Gallon cont. - Dense, full plant
VS	Veronica x 'Blue Skywalker'	Speedwell	25	1 Gallon cont. - Dense, full plant
GROUND COVER				
PT	Pachysandra Terminalis	Jap. Pachysandra	65	1 Qt cont. - Dense, full plant
VM	Vinca Minor	Perriwinkle	25	1 Qt cont. - Dense, full plant

LANDSCAPE NOTES



- ALL AREAS SHOWN ON THE PLAN TO BE MULCHED SHALL RECEIVE 3" DEPTH OF AGED FINE SHREDDED PINE BARK. SAMPLE TO BE APPROVED BY LANDSCAPE ARCHITECT.
- CONTRACTOR SHALL VERIFY QUANTITIES ON THE PLAN AND IS RESPONSIBLE FOR ALL PLANTS AS SHOWN ON THE PLANT LIST. REPORT ANY DISCREPANCIES TO LANDSCAPE ARCHITECT. SEE PLANT LIST SHEET L-4.
- CONTRACTOR SHALL GUARANTEE ALL PLANTINGS FOR ONE YEAR FROM COMPLETION OF WORK. REPLACEMENT PLANTS AND LABOR SHALL BE PROVIDED AT CONTRACTORS' EXPENSE.
- PRUNE ONLY AS DIRECTED BY LANDSCAPE ARCHITECT. PLANTS SHALL NOT HAVE A SHEARED APPEARANCE.
- ALL PLANT MATERIAL IS TO CONFORM TO THE LATEST EDITION OF AMERICAN STANDARDS FOR NURSERY STOCK.
- LANDSCAPE ARCHITECT RESERVES THE RIGHT TO REJECT ANY PLANT MATERIAL.
- CONTRACTOR IS RESPONSIBLE FOR THE LOCATION AND IDENTIFICATION OF ALL UTILITIES. ANY UTILITIES DAMAGED BY THE CONTRACTOR SHALL BE REPAIRED AT THE CONTRACTOR'S COST.
- ALL DEMOLISHED MATERIALS AND TRASH ARE TO BE REMOVED FROM THE SITE AND DISPOSED OF PROPERLY. HARDSCAPE AREAS ARE TO BE PRESSURE WASHED TO ACHIEVE A CLEAN FINISHED APPEARANCE.
- ALL PLANTING BEDS ARE TO BE CLEANED OF ROCKS AND DEBRIS >1", TILLED TO 12" DEPTH AND AMENDED WITH 3" OF NATURES HELPER (OR APPROVED EQUAL), THEN THOROUGHLY TILLED TOGETHER.
- ANY REMAINING DISTURBED AREAS, NON-PLANTING OR MEADOW, ARE TO BE FINE GRADED AND SEEDED WITH FESCUE BLEND (SEE SCHEDULE, THIS PAGE).
- PRIOR TO INSTALLATION, CONTRACTOR SHALL REVIEW PLANT AND LIGHT LOCATIONS WITH LANDSCAPE ARCHITECT TO ELIMINATE CONFLICTS. ON SHEET L1.
- ALL EXISTING AND PROPOSED TREES NOT CONTAINED WITHIN A MULCHED BED ARE TO RECEIVE A 5' DIAMETER CIRCLE OF MULCH.
- LANDSCAPE ARCHITECT WILL FIELD PLACE ALL PLANT MATERIALS.
- REPORT ANY POORLY DRAINED SOILS OR ANY DRAINAGE PROBLEMS TO LANDSCAPE ARCHITECT IMMEDIATELY. FAILURE TO REPORT SUCH CONDITIONS WILL RESULT IN THE CONTRACTOR BEING RESPONSIBLE FOR CORRECTING THE PROBLEM AND REPLACING DAMAGED OR LOST PLANTS.
- LAWN AREAS TO BE SEEDED SHALL BE TILLED TO A MIN. 4" DEPTH (EXCEPT WITHIN THE DRIPLINE OF EXISTING TREES TO REMAIN.) SEE SEEDING SCHEDULES, THIS PAGE, FOR SEEDING AND FERTILIZATION RATES.

TREE PROTECTION NOTES

- ALL TREES, UNDERSTORY AND OTHER VEGETATION TO REMAIN SHALL BE PROTECTED FROM INJURY DURING ANY LAND CLEARING AND CONSTRUCTION PROCESS.
- THE CONTRACTOR SHALL NOT PARK VEHICLES, STORE MATERIALS OR TRENCH WITHIN THE DRIPLINE OF TREES TO REMAIN, OR WITHIN BARRIERS PROTECTING ANY VEGETATION TO REMAIN.
- THE CONTRACTOR SHALL NOT CAUSE OR ALLOW THE CLEANING OF EQUIPMENT, STORAGE OR DISPOSAL OF MATERIALS SUCH AS PAINTS, SOLVENTS, ASPHALT, CONCRETE, OR ANY MATERIAL THAT CAN DAMAGE THE HEALTH OF VEGETATION WITHIN THE DRIPLINE OF PROTECTED VEGETATION.
- NO ATTACHMENT OF WIRES (EXCLUSIVE OF PROTECTIVE GUIDE WIRES) SIGNS, OR PERMITS SHALL BE FASTENED TO PROTECTED VEGETATION.
- A TEMPORARY BARRIER SHALL BE INSTALLED PER PLAN OR AS DIRECTED BY THE LANDSCAPE ARCHITECT. THE BARRIERS SHALL REMAIN THROUGHOUT THE ENTIRE CONSTRUCTION PROCESS.
- ALL CLEARING AND GRUBBING WITHIN AREAS OF VEGETATION TO REMAIN SHALL BE DONE WITH HAND TOOLS ONLY AND UNDER THE DIRECTION OF THE LANDSCAPE ARCHITECT.



Westmore Design, PA

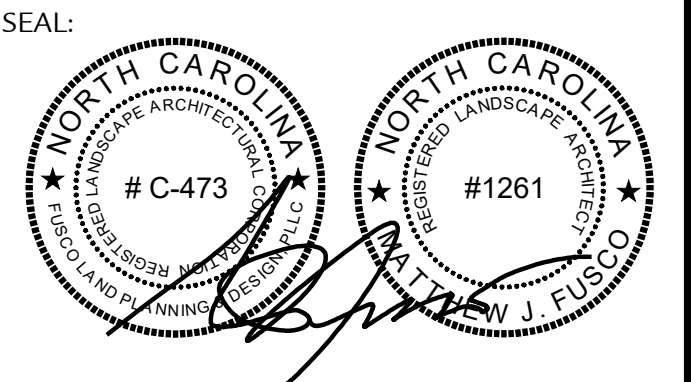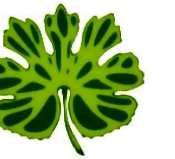

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CHECKED BY: MJF

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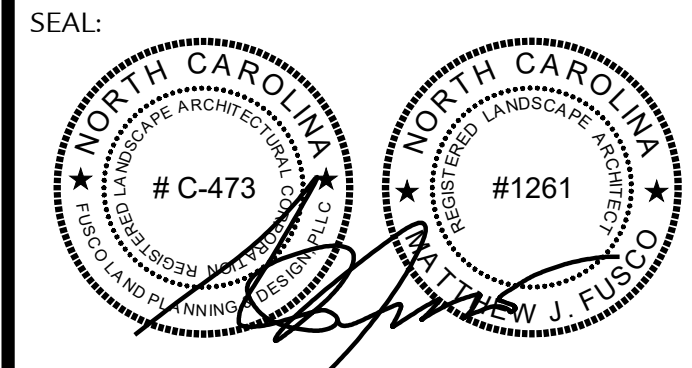
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SHEET TITLE:

Landscape Schedule, Notes, Specs & Details

SHEET NO:

L6.01



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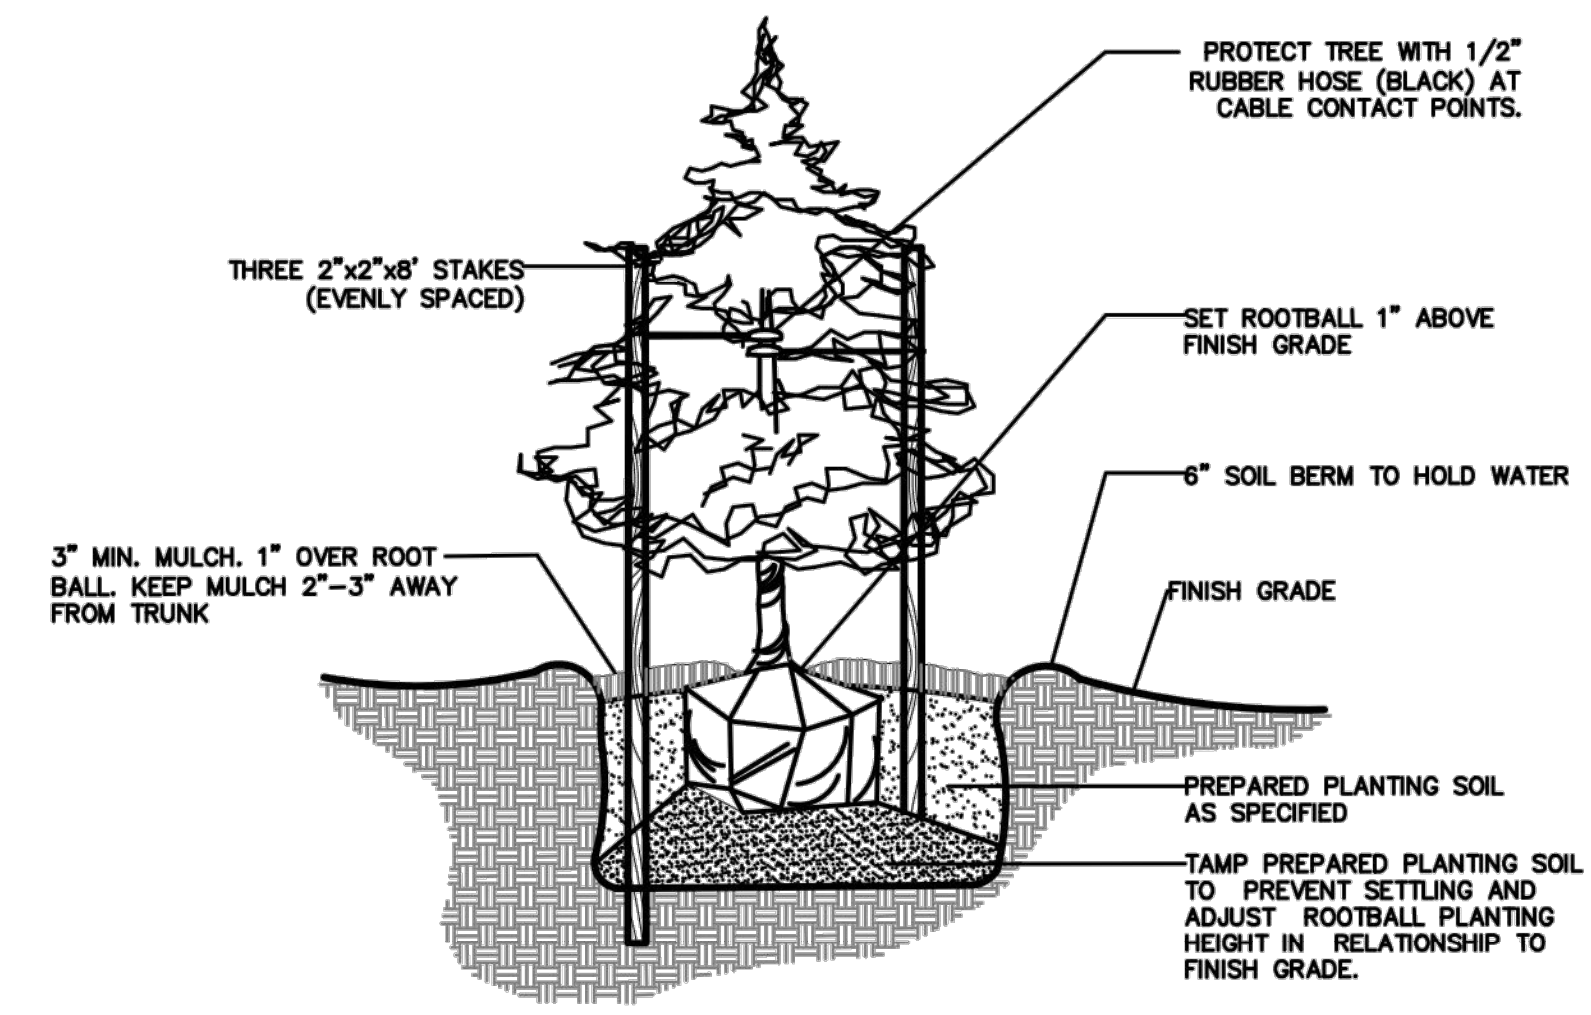
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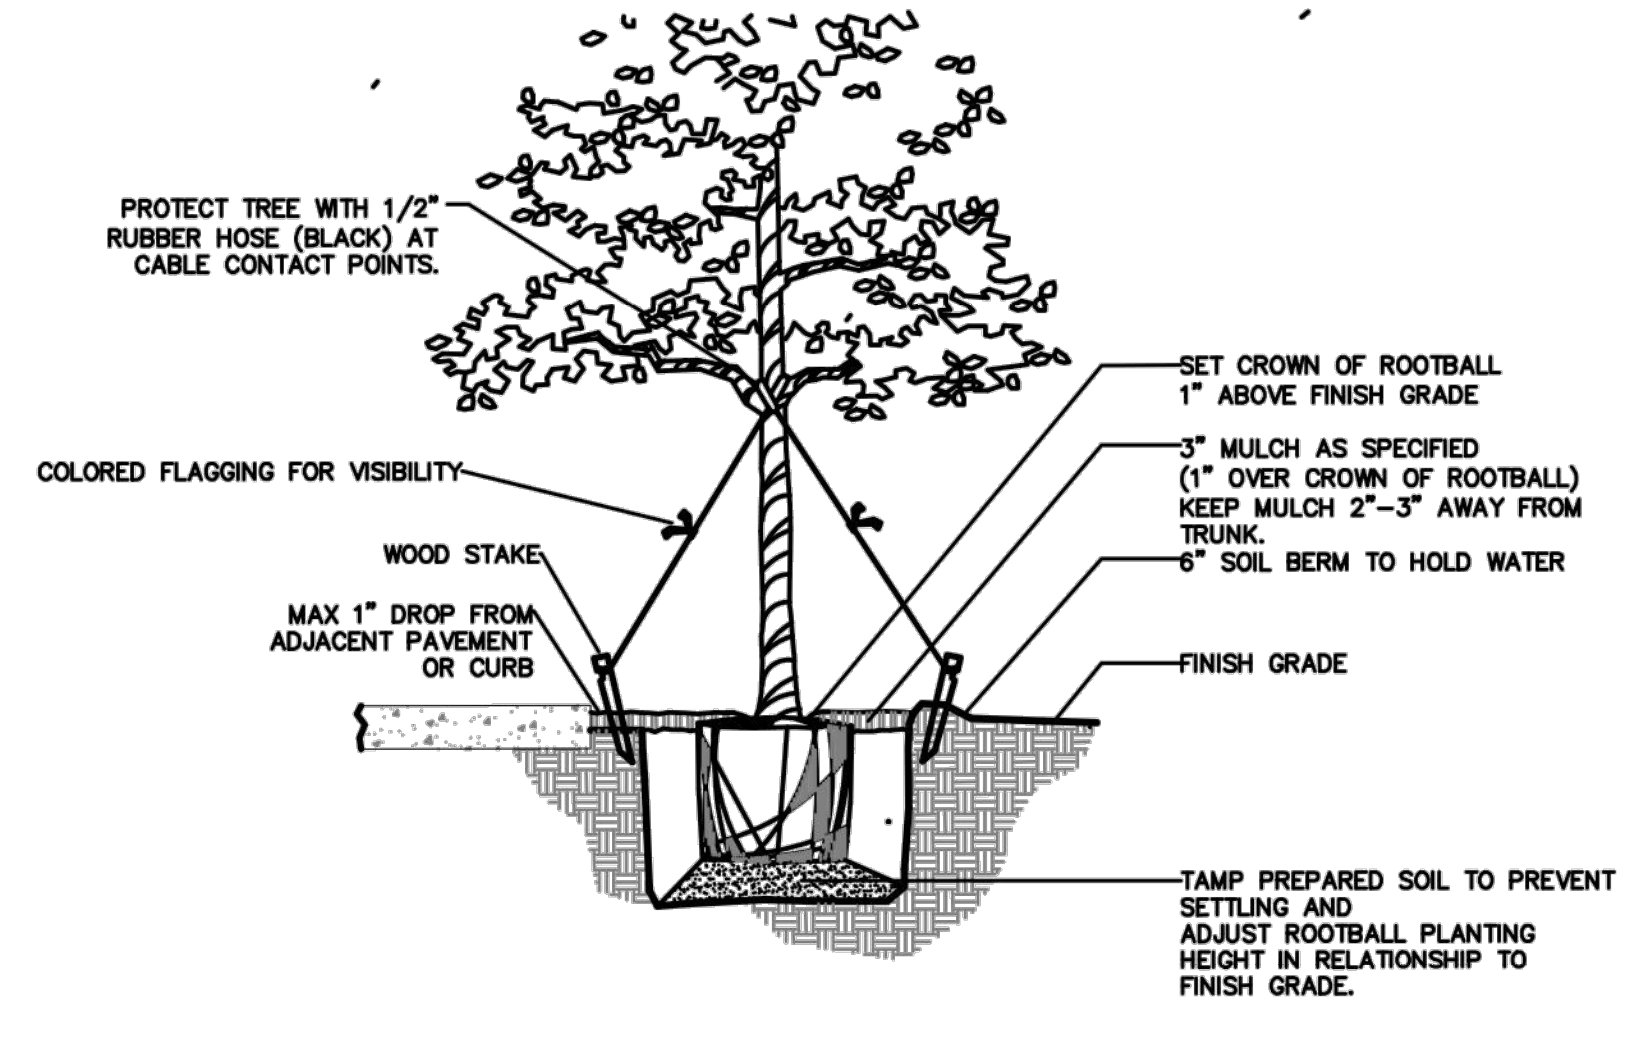
SHEET TITLE:
**Landscape Schedule,
Notes, Specs &
Details**

SHEET NO:
L6.02




NOTES:
1. DO NOT DAMAGE MAIN ROOTS OR DESTROY ROOTBALL WHEN INSTALLING TREE STAKES
2. "D" = ROOTBALL + 24".
3. CONTRACTOR SHALL ASSURE PERCOLATION OF ALL PLANTING BEDS/PITS PRIOR TO INSTALLATION.
4. STAKES TO BE A MINIMUM OF 4' & MAX. OF 8' ABOVE FINISH GRADE DEPENDING UPON HEIGHT OF TREE. CUT TOP OF POSTS CLEAN.

Evergreen Tree Planting Detail
Scale: NTS




NOTES:
1. DO NOT DAMAGE MAIN ROOTS OR DESTROY ROOTBALL WHEN INSTALLING TREE STAKES
2. "D" = ROOTBALL + 24".
3. CONTRACTOR SHALL ASSURE PERCOLATION OF ALL PLANTING BEDS/PITS PRIOR TO INSTALLATION.
4. TREE SUPPORT SYSTEM TO BE 3 GALV. STEEL CABLES FASTENED TO WOOD STAKES. PLACE COLORED FLAGGING ON CABLES FOR SAFETY.

Large Tree Planting Detail
Scale: NTS

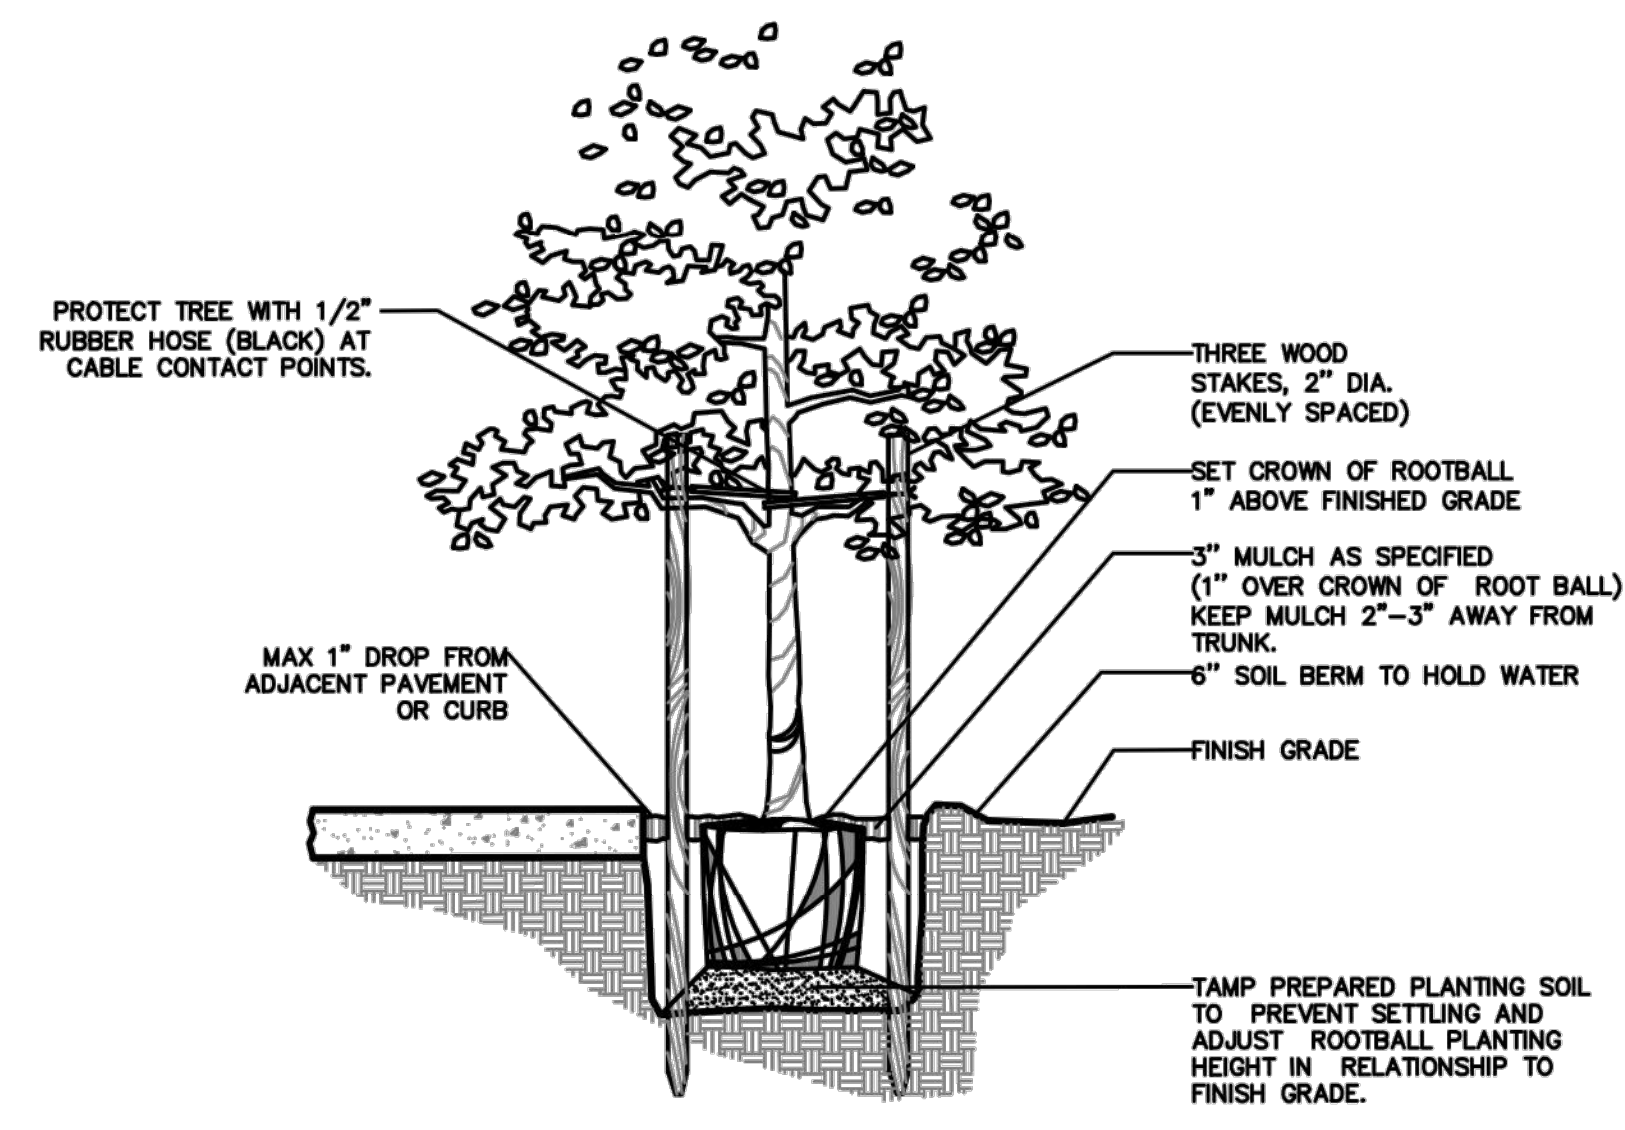


NOTES:
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2. "D" = ROOTBALL + 24".
3. CONTRACTOR SHALL ASSURE PERCOLATION OF ALL PLANTING BEDS/PITS PRIOR TO INSTALLATION.
4. STAKES TO BE A MINIMUM OF 4' & MAX. OF 8' ABOVE FINISH GRADE DEPENDING UPON HEIGHT OF TREE. CUT TOP OF POSTS CLEAN.

Small Tree Planting Detail
Scale: NTS

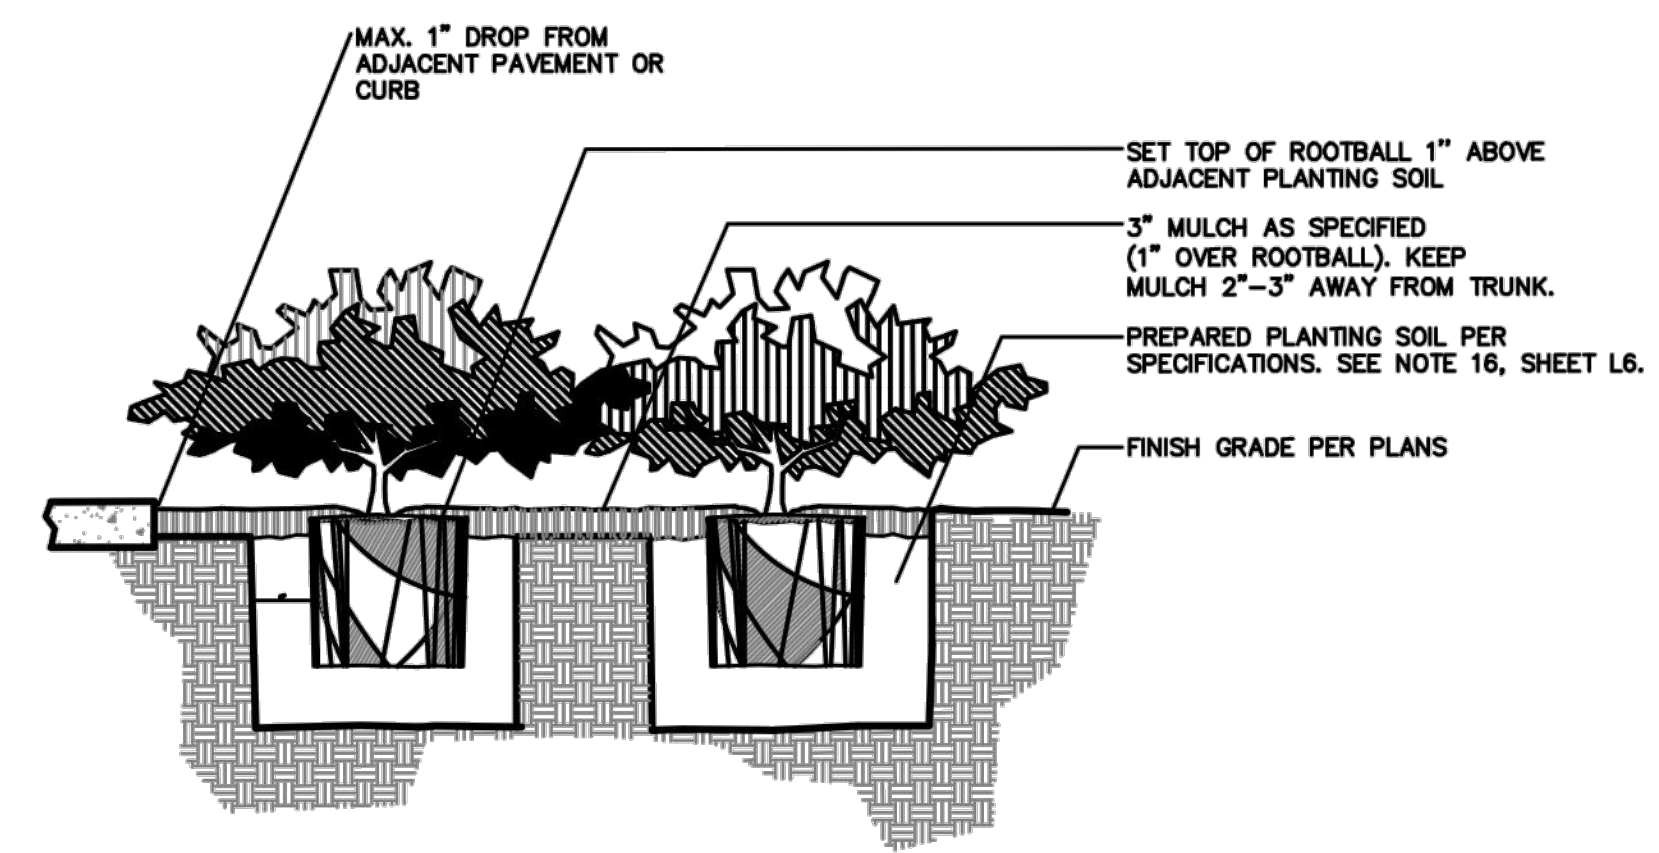

NOTES:
1. ALL AREAS BETWEEN SHRUBS TO RECEIVE 3" MULCH PER SPECS.
2. CONTRACTOR SHALL ASSURE PERCOLATION OF ALL PLANTING BEDS/PITS PRIOR TO INSTALLATION.

Shrub Planting Detail
Scale: NTS

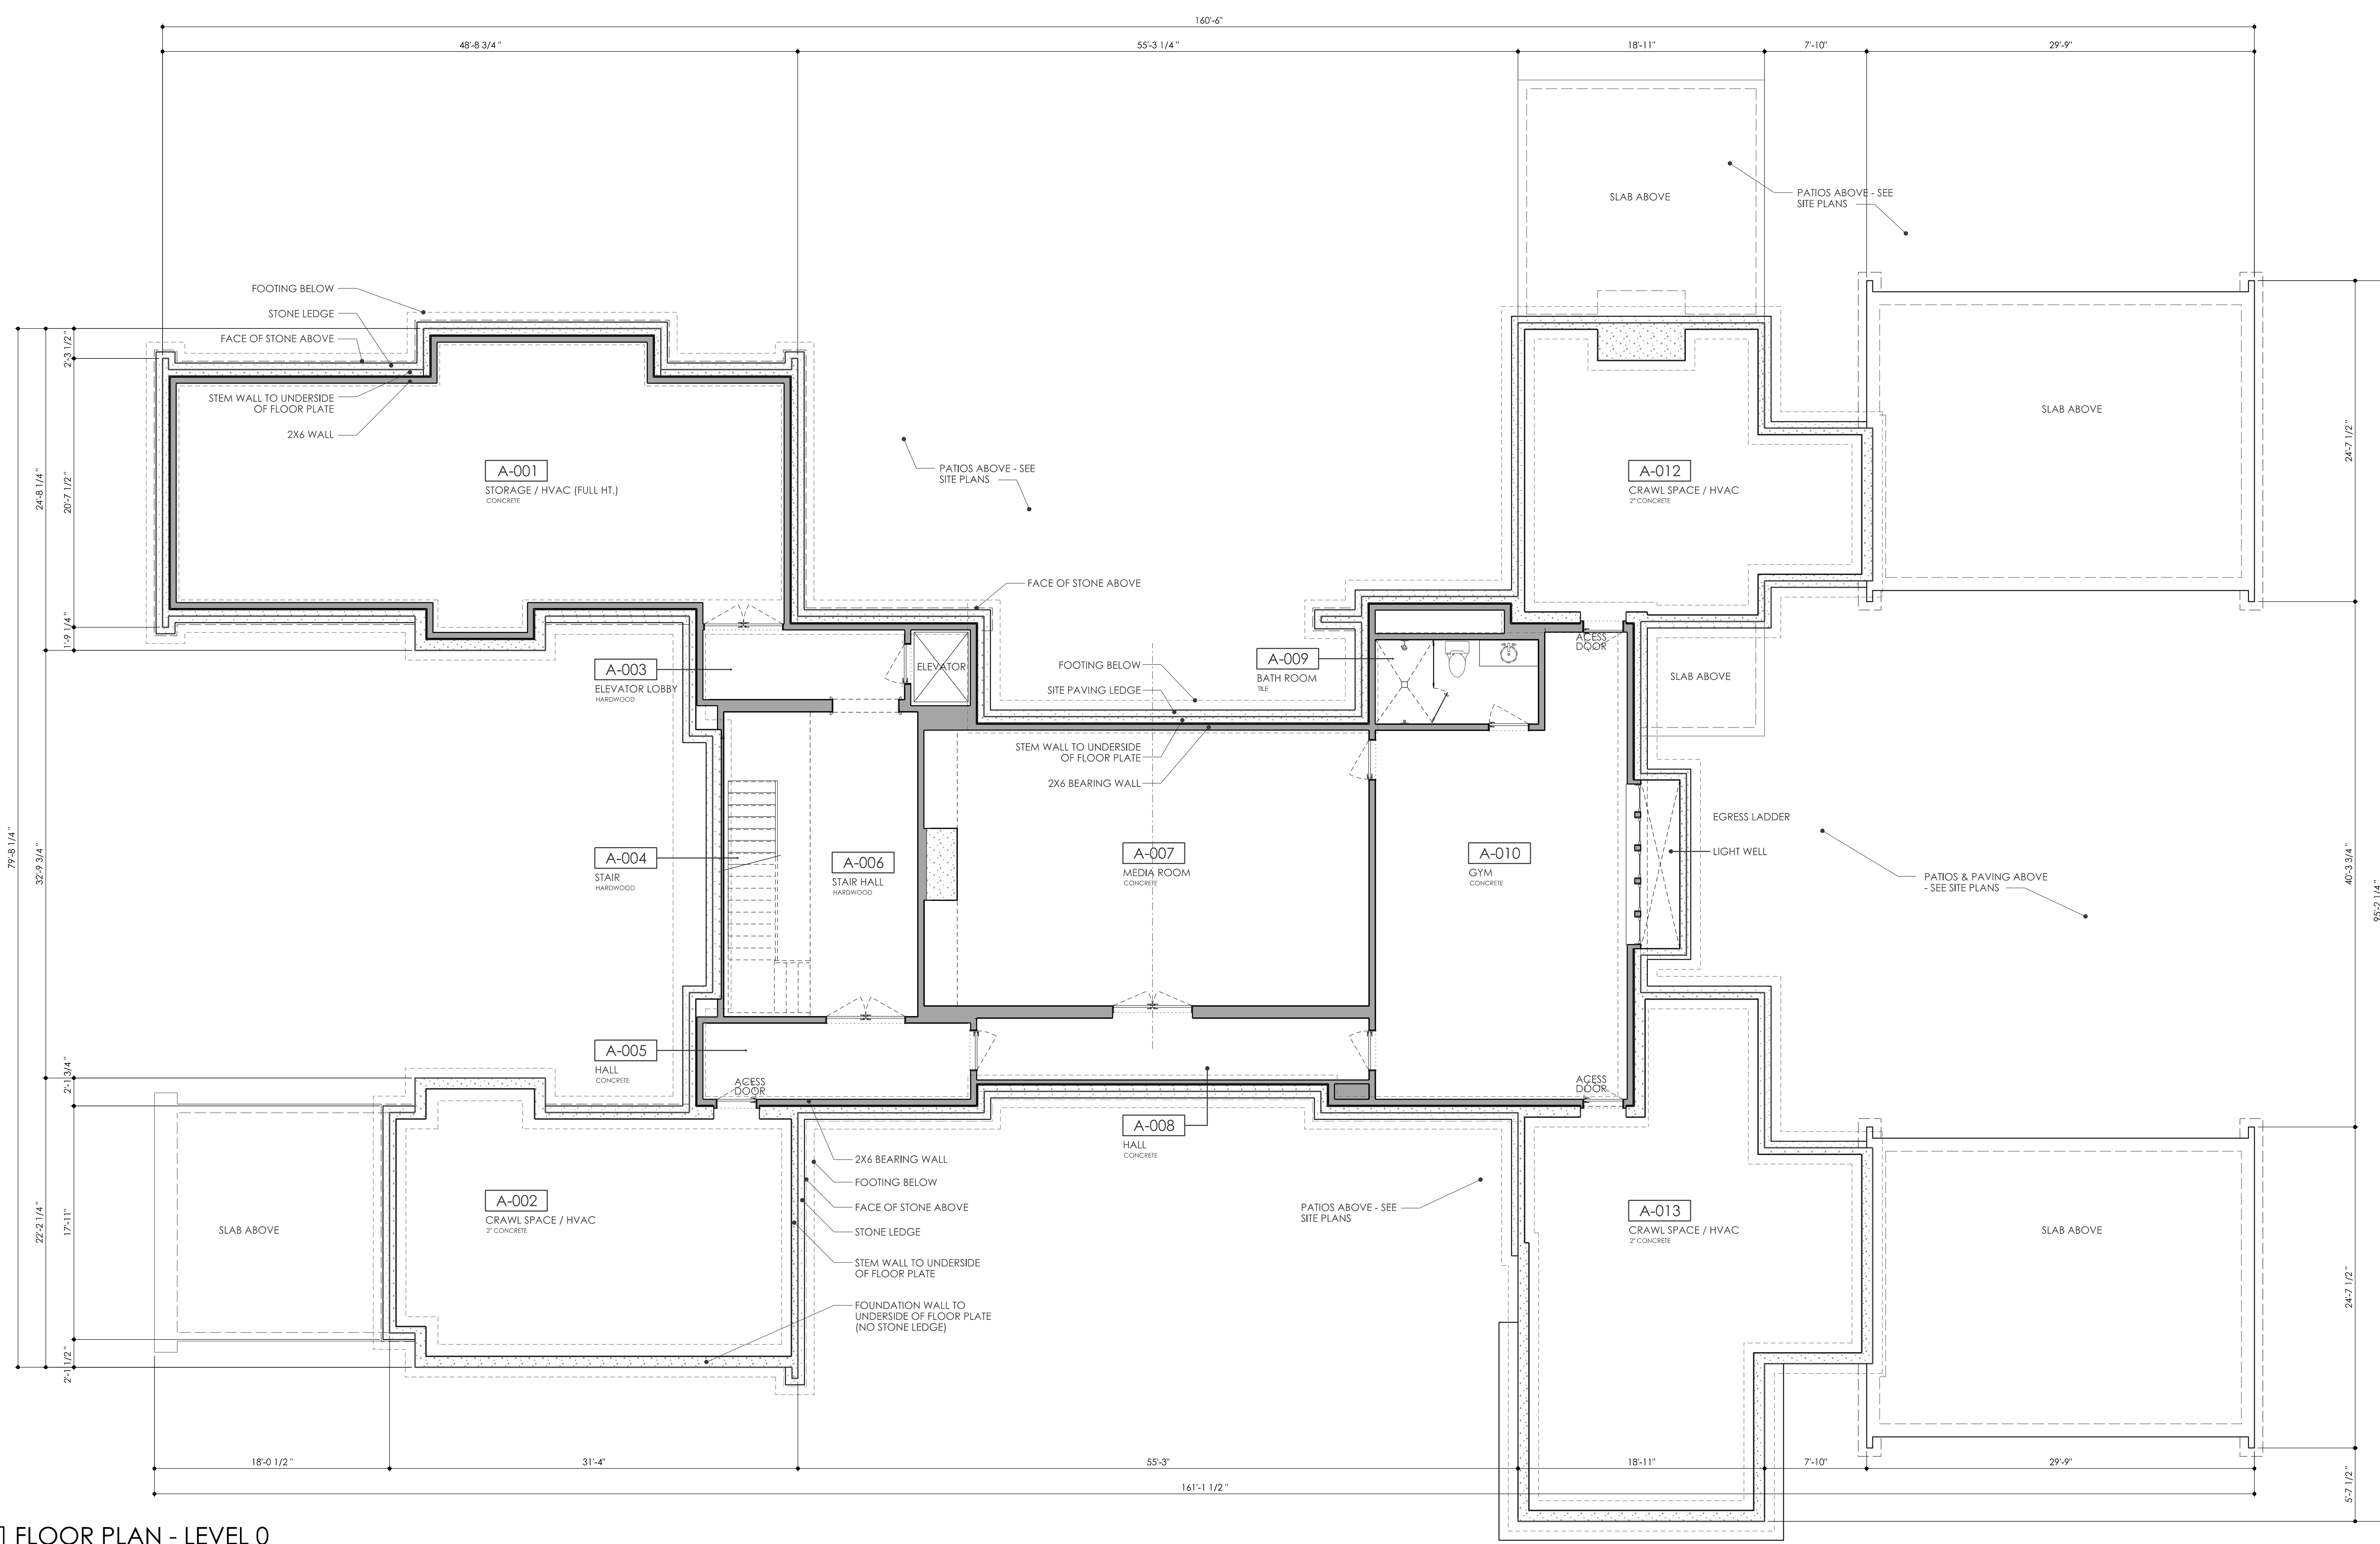

FLOOR PLAN - LEVEL 0
 A1.0 SCALE: 3/16" = 1'-0"

New Construction
Weilbaecher Residence
 414 Vanderbilt Road
 Asheville NC 28803

Prepared for
Derek & Angela Weilbaecher

Designer
JOEL KELLY DESIGN
 448 E. Paces Ferry Rd. NE
 Suite 100
 Atlanta, Georgia 30305
 404-221-0422
 www.joelkelly.com

No.	Issue Description	Date
1	Client Review	05-04-2021
2	Interiors	05-05-2021
3	Structural RFP	05-21-2021
4	Client Review	05-28-2021
5	Client Review	06-16-2021
7	Client Review - Millwork	06-30-2021
9	Structural Review	08-04-2021
9.1	Window Pricing	08-05-2021
10	Structural Export	08-18-2021
11	Cabinet Coordination	08-26-2021
12	ZONING APPLICATION	08-30-2021

SHEET NAME
**FLOOR PLAN
 LEVEL 0 - ALTERNATE**

SHEET NUMBER
A1.0

COMMENTS
 NOT ISSUED FOR CONSTRUCTION

New Construction
Weilbaecher Residence
 414 Vanderbilt Road
 Asheville NC 28803

Prepared for
Derek & Angela Weilbaecher

Designer
JOEL KELLY DESIGN


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No.	Issue Description	Date
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3	Structural RFP	05-21-2021
4	Client Review	05-28-2021
5	Client Review	06-16-2021
5.1	Interior Designer Copy	06-21-2021
7	Client Review - Millwork	06-30-2021
8	Client Review	07-26-2021
9	Structural Review	08-04-2021
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10	Structural Export	08-18-2021
11	Cabinet Coordination	08-26-2021
12	ZONING APPLICATION	08-30-2021

SHEET NAME
**FLOOR PLAN
 LEVEL 1**

SHEET NUMBER
A1.1

COMMENTS
NOT ISSUED FOR CONSTRUCTION

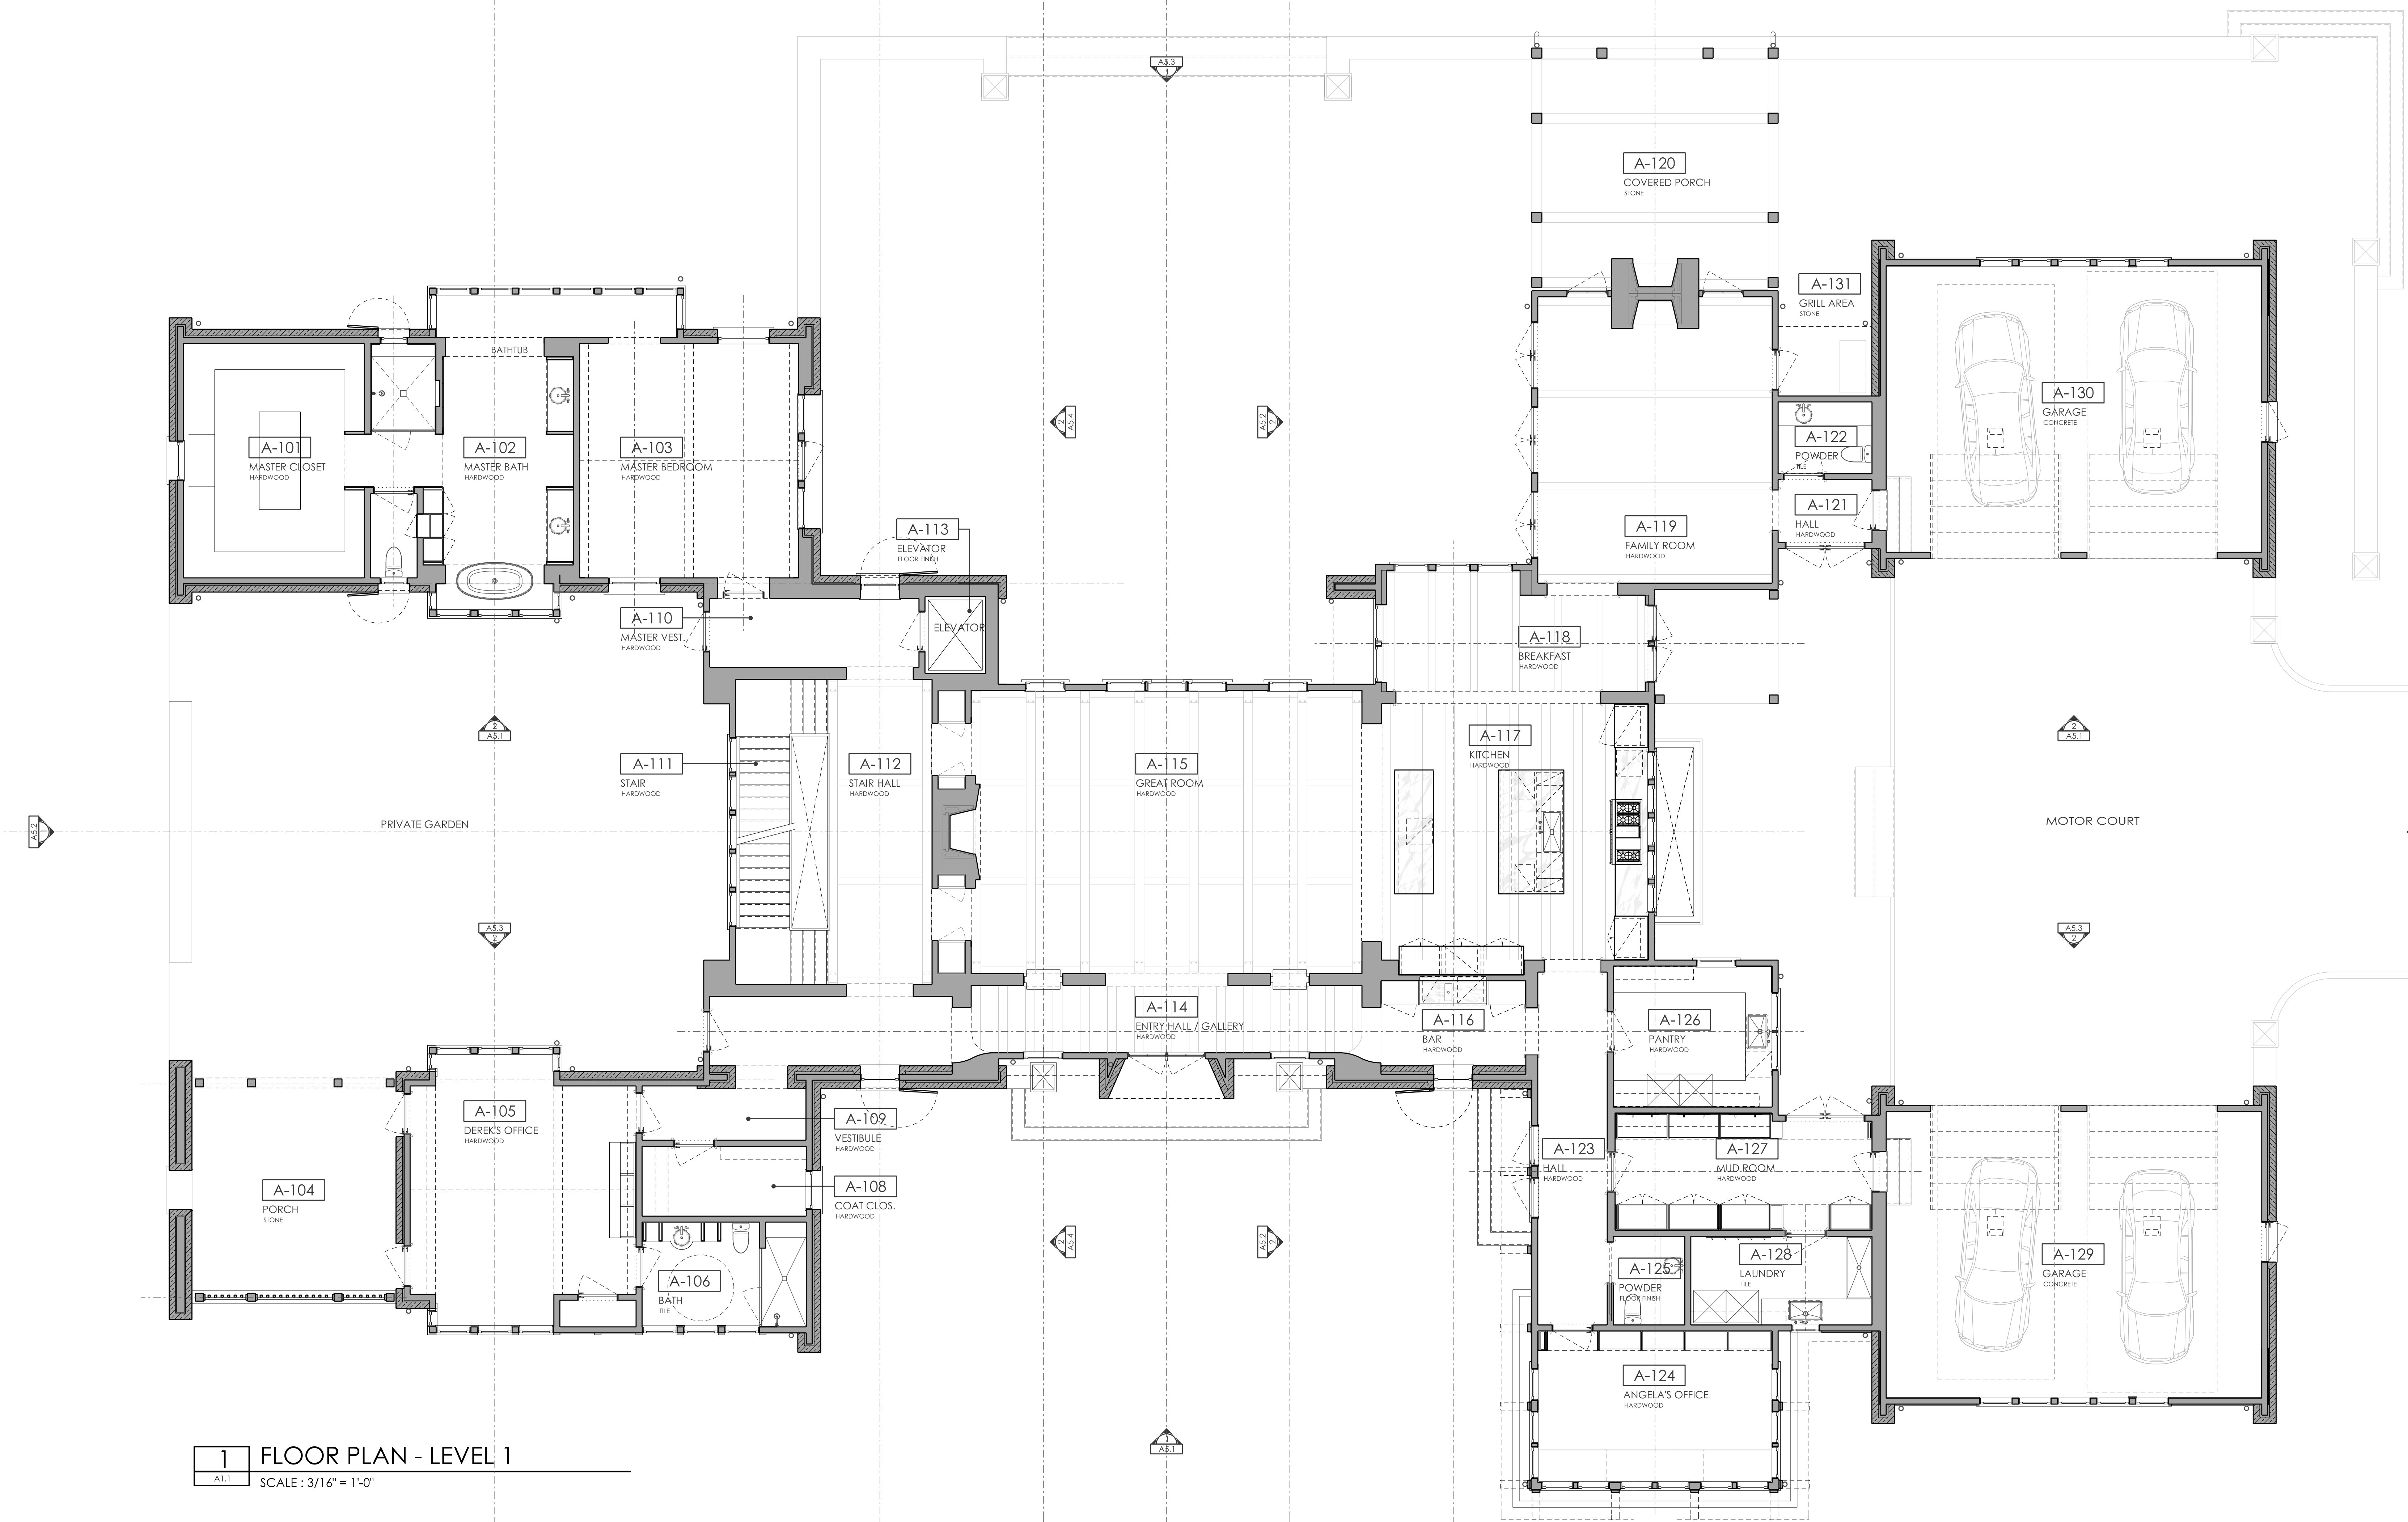

1 FLOOR PLAN - LEVEL 1
 SCALE: 3/16" = 1'-0"

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Weilbaecher Residence
 414 Vanderbilt Road
 Asheville NC 28803

Prepared for
Derek & Angela Weilbaecher

Designer
JOEL KELLY DESIGN


448 E. Paces Ferry Rd. NE
 Suite 100
 Atlanta, Georgia 30305
 404-221-0422
 www.joelkelly.com

No.	Issue Description	Date
1	Client Review	05-04-2021
3	Structural RFP	05-21-2021
4	Client Review	05-28-2021
5	Client Review	06-16-2021
5.1	Interior Designer Copy	06-21-2021
7	Client Review - Millwork	06-30-2021
8	Client Review	07-26-2021
9	Structural Review	08-04-2021
9.1	Window Pricing	08-05-2021
10	Structural Export	08-18-2021
11	Cabinet Coordination	08-26-2021
12	ZONING APPLICATION	08-30-2021

SHEET NAME
**FLOOR PLAN
 LEVEL 2**

SHEET NUMBER
A1.2

COMMENTS
 NOT ISSUED FOR CONSTRUCTION

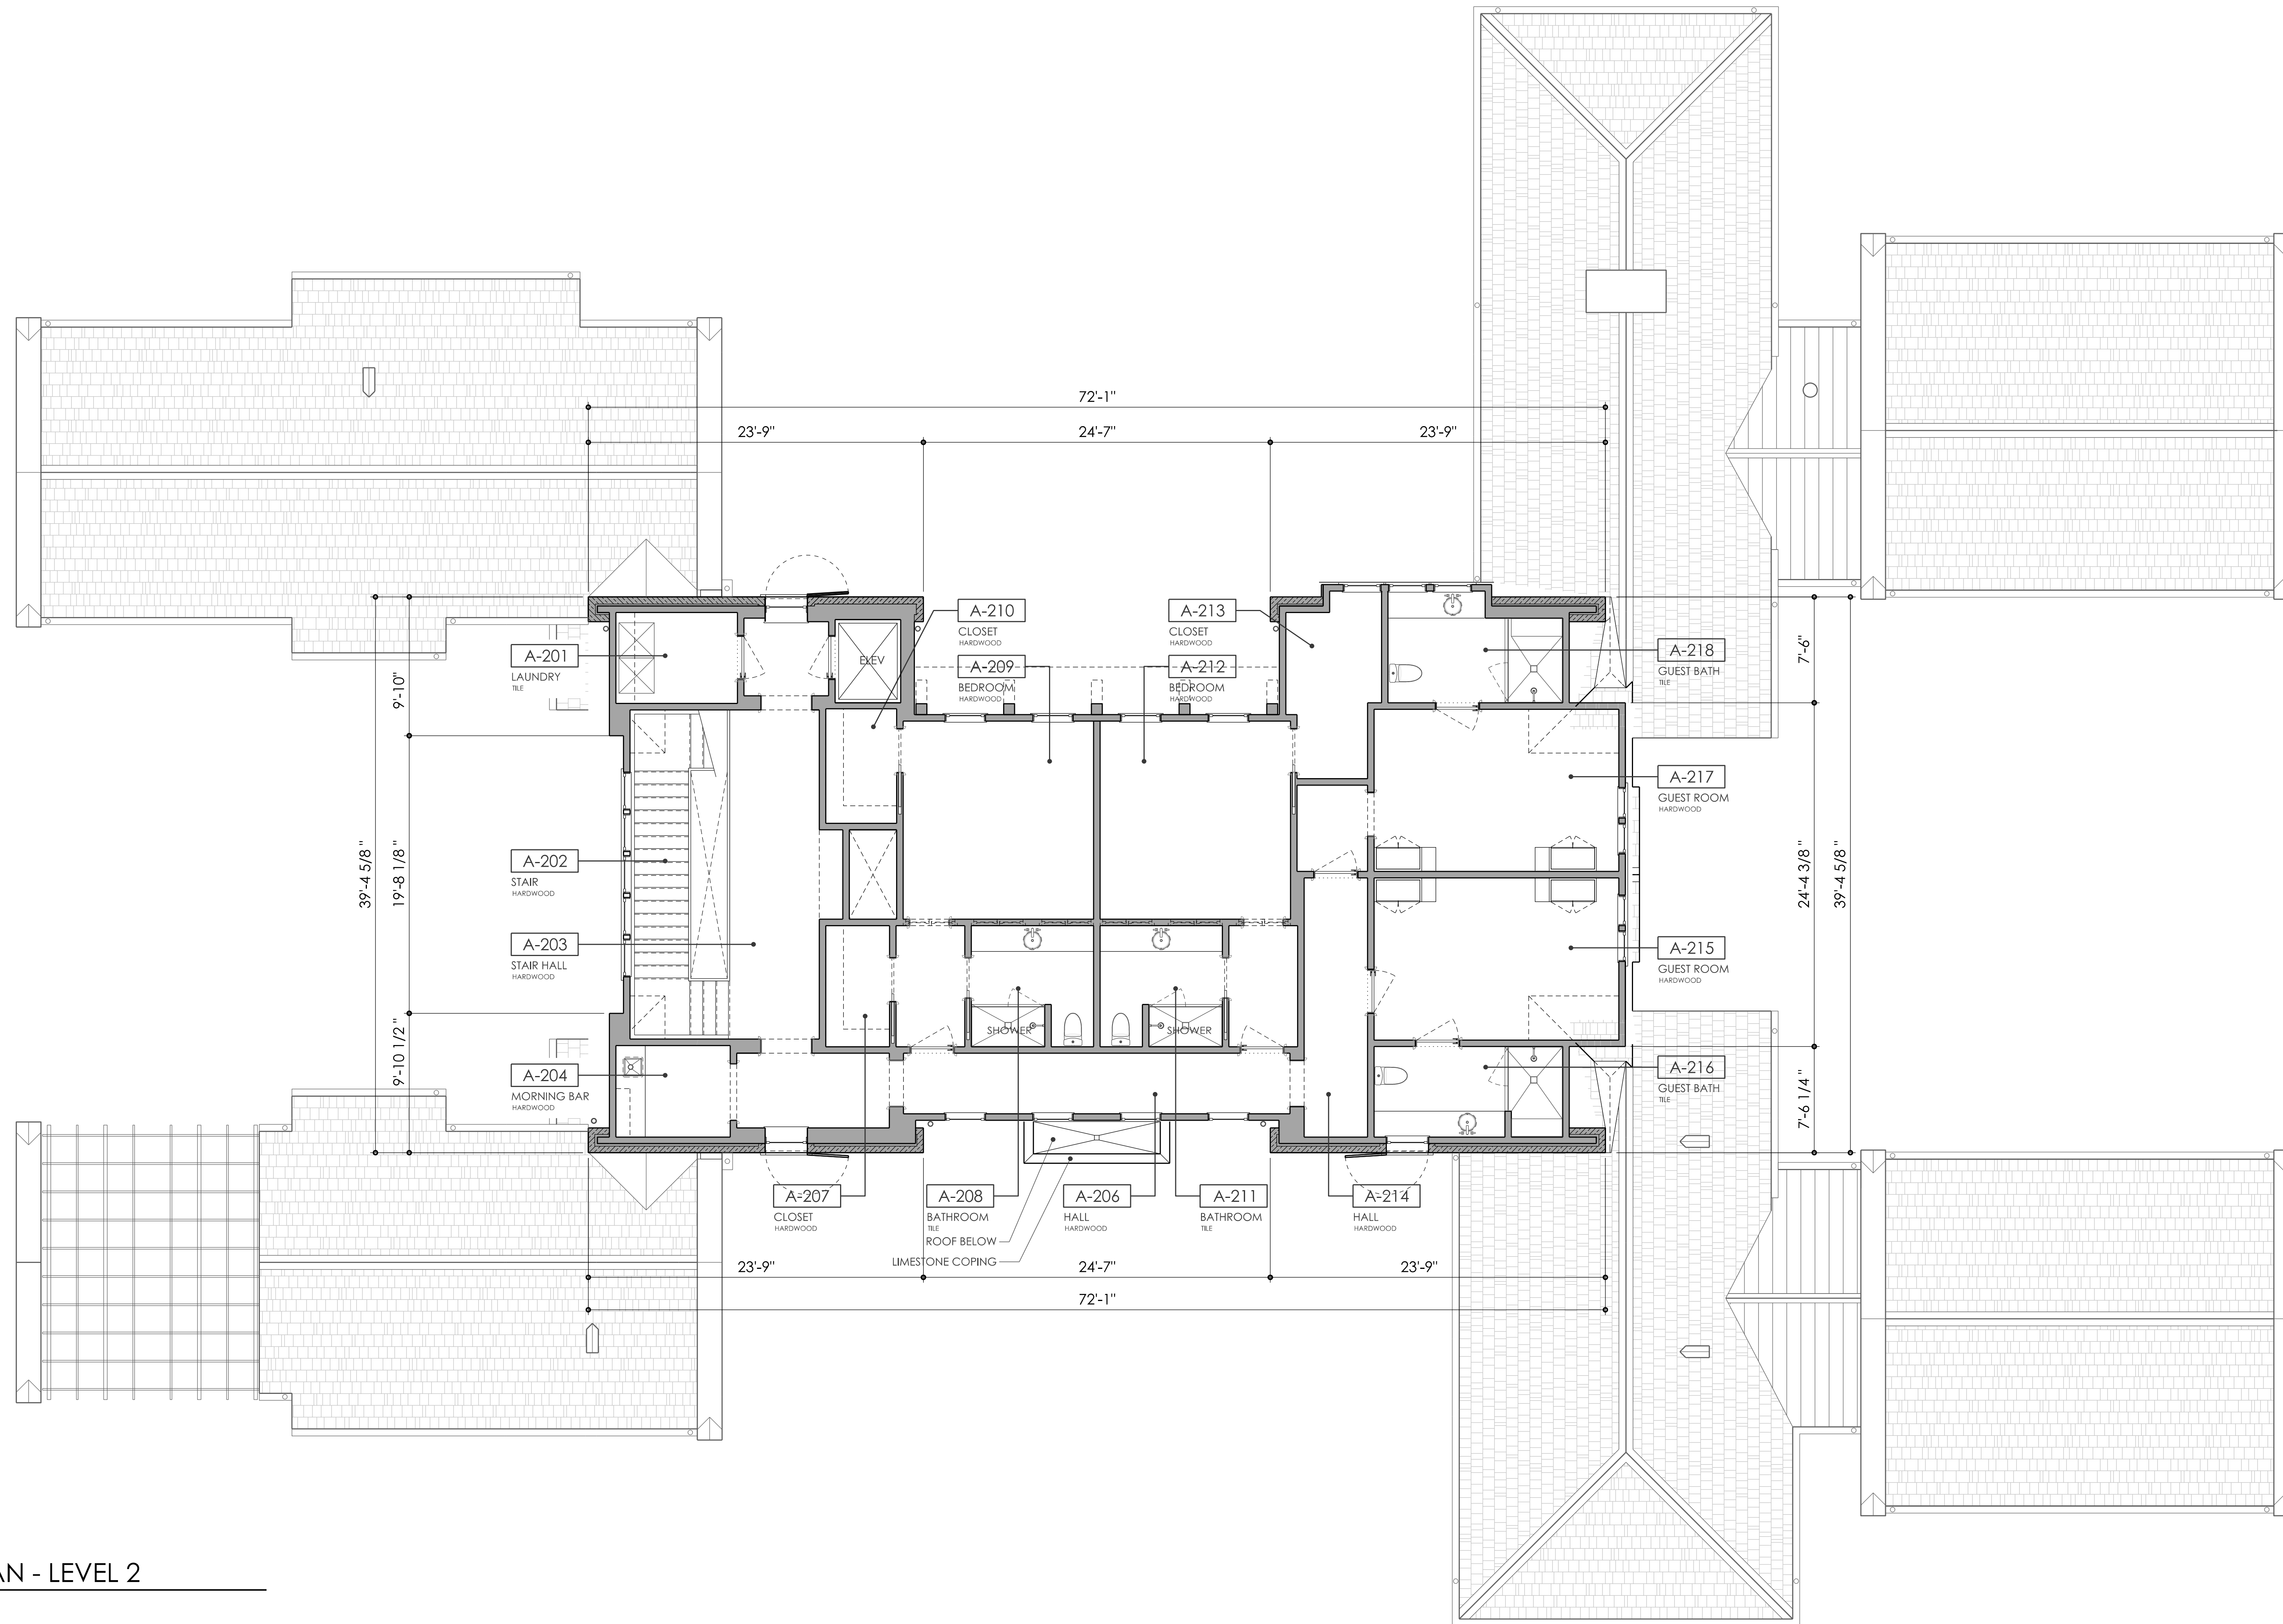

1 FLOOR PLAN - LEVEL 2
 A1.2 SCALE: 3/16" = 1'-0"

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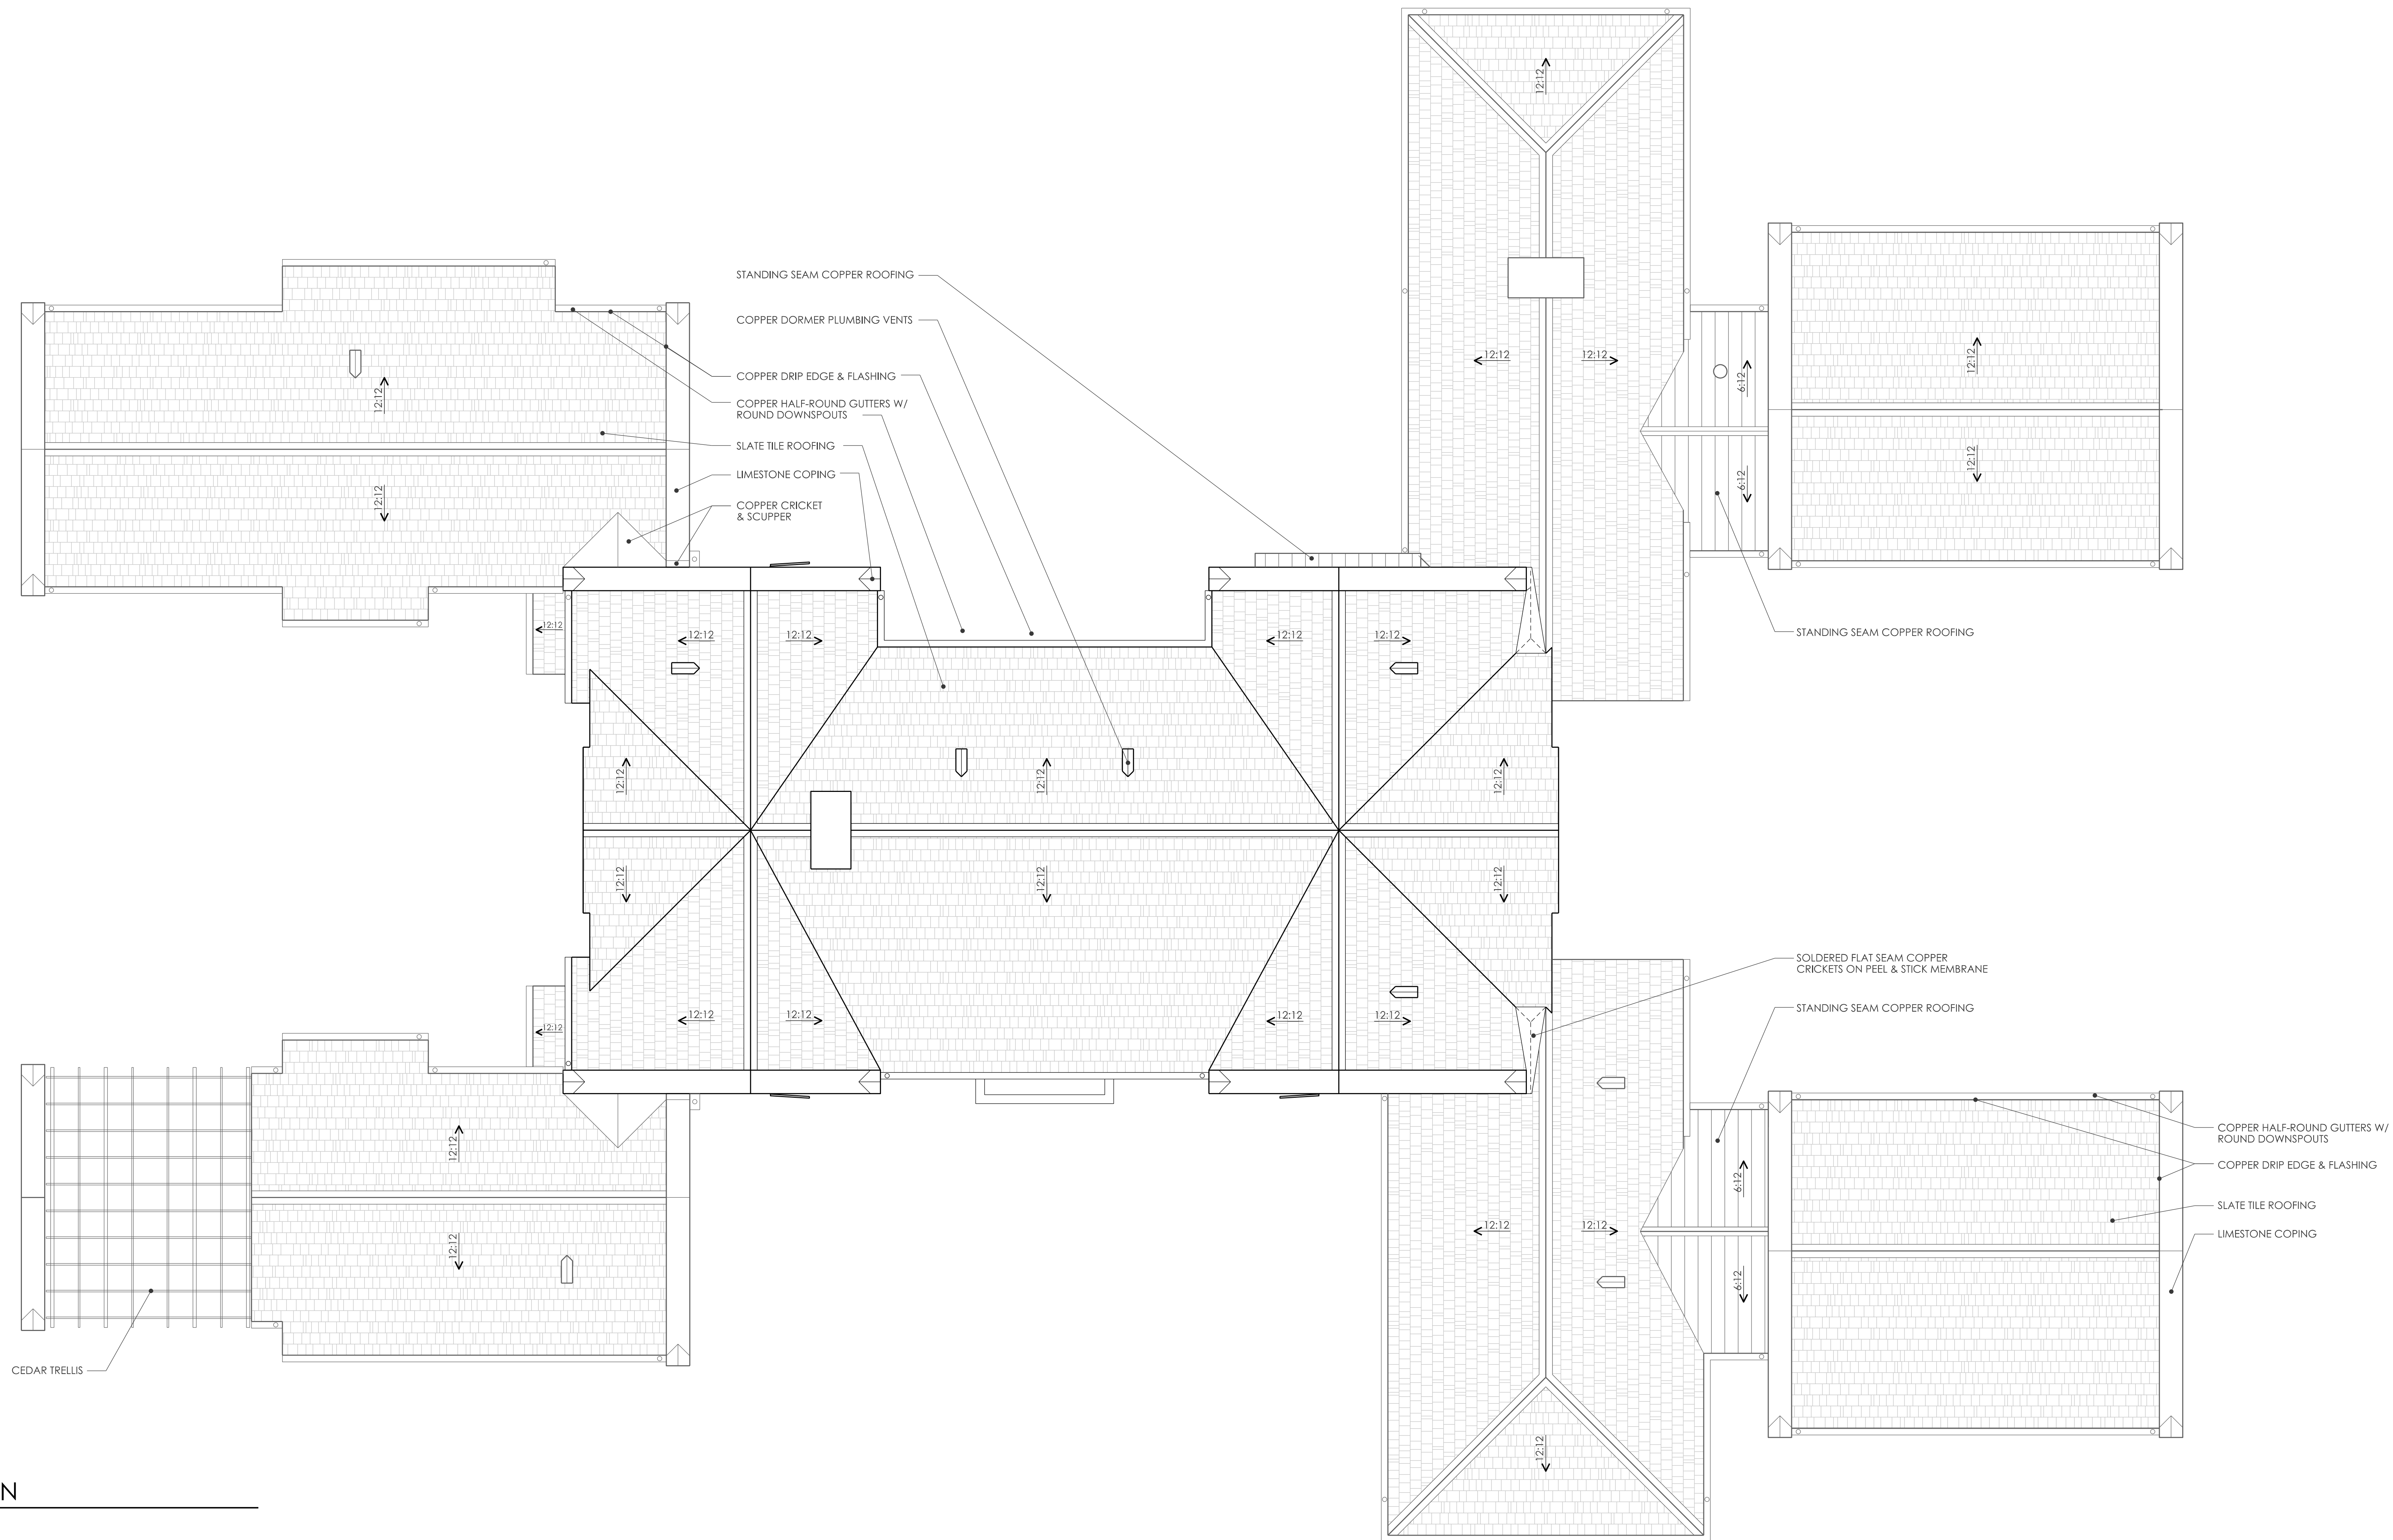
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12	ZONING APPLICATION	08-30-2021


SHEET NAME
ROOF PLAN

SHEET NUMBER
A1.3


COMMENTS
 NOT ISSUED FOR CONSTRUCTION



1 ROOF PLAN
 A1.3 SCALE: 3/16" = 1'-0"

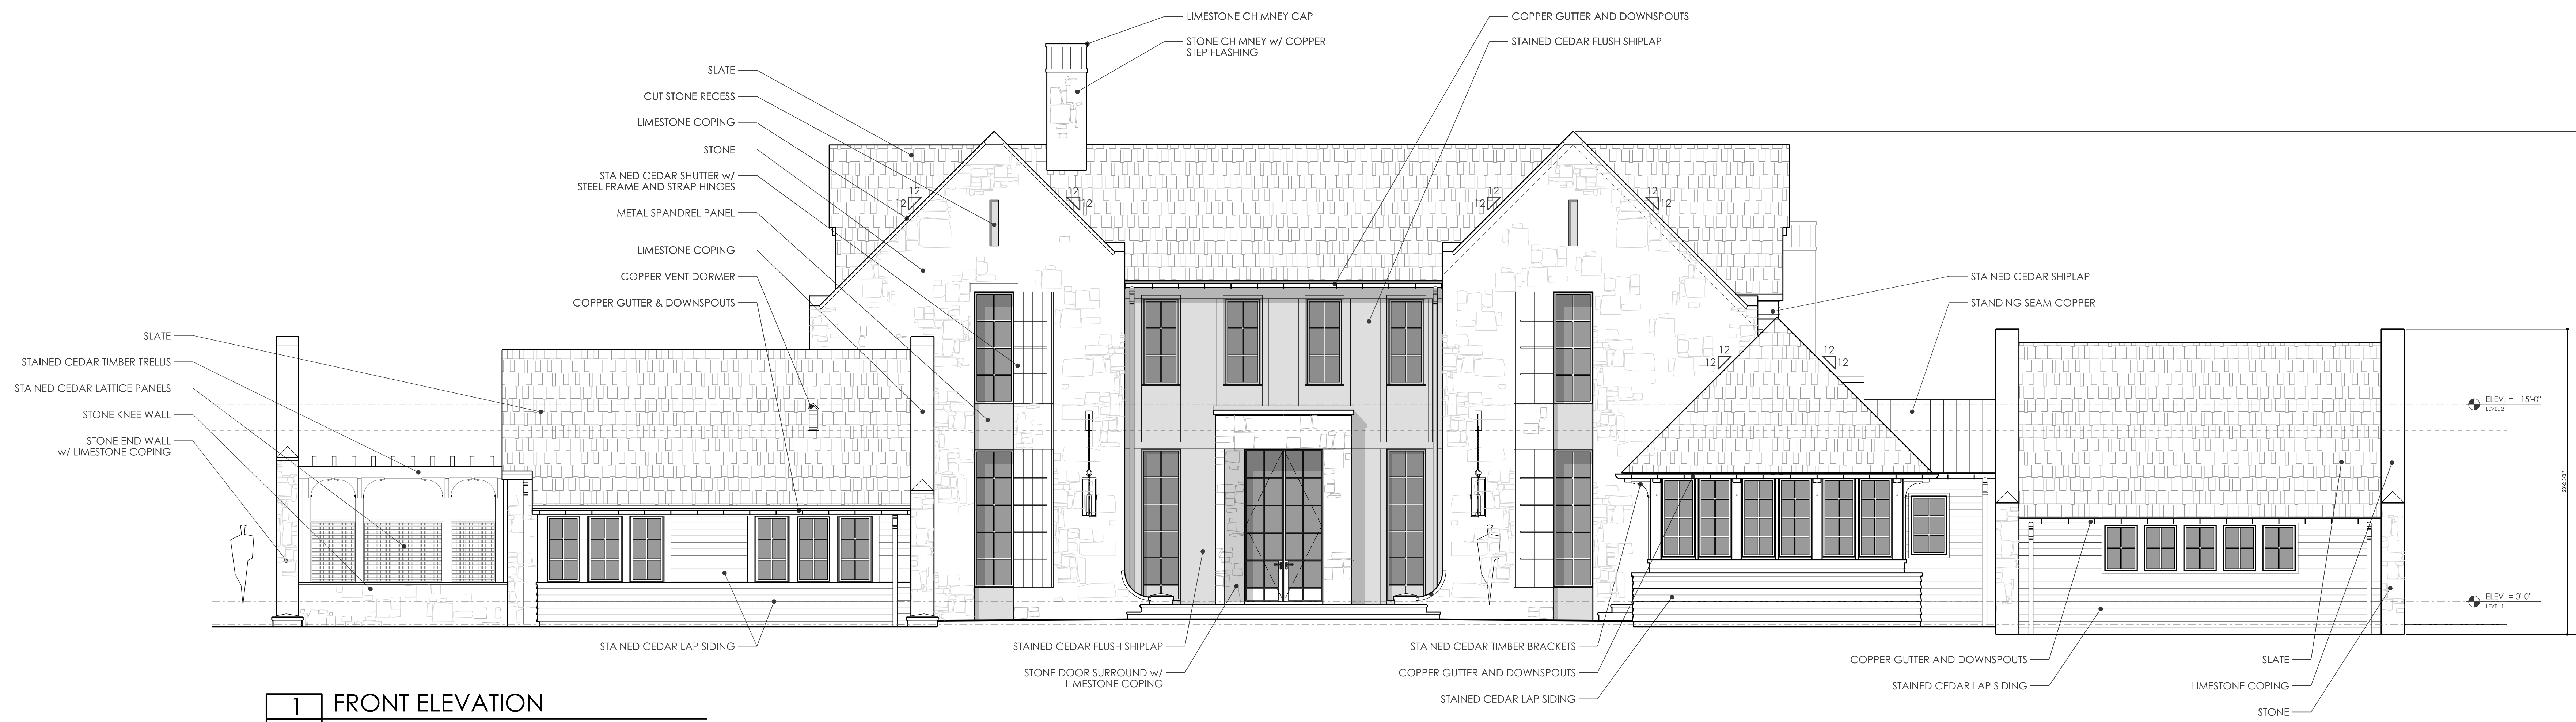

1 FRONT ELEVATION
A5.1 SCALE : 3/16" = 1'-0"

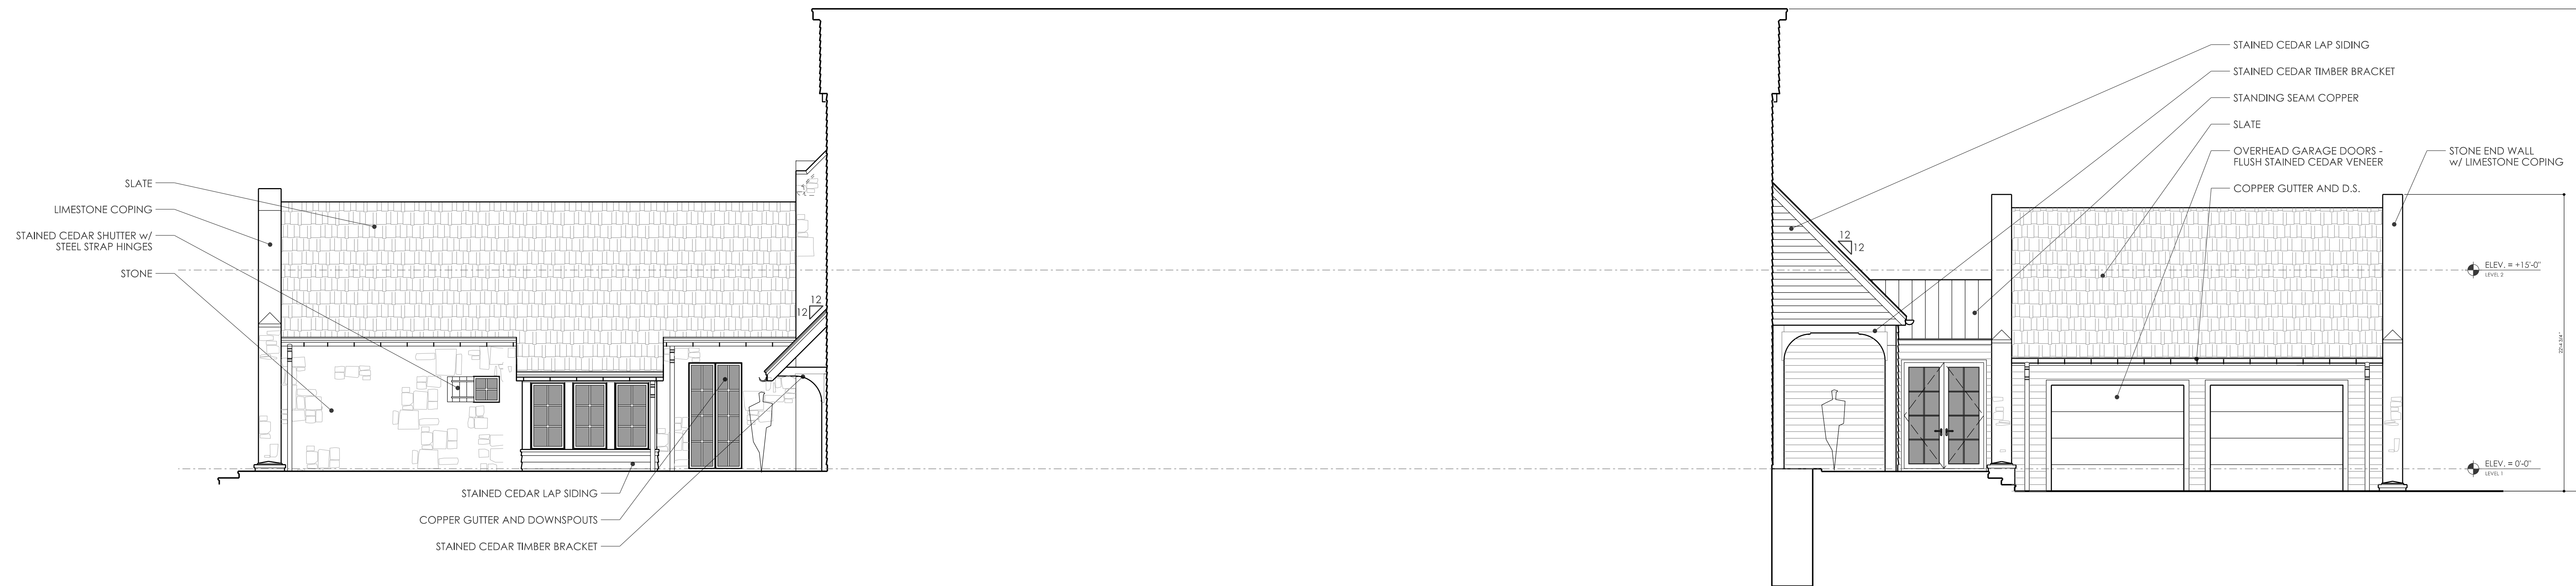

2 COURTYARD ELEVATION (FACING REAR)
A5.1 SCALE : 3/16" = 1'-0"

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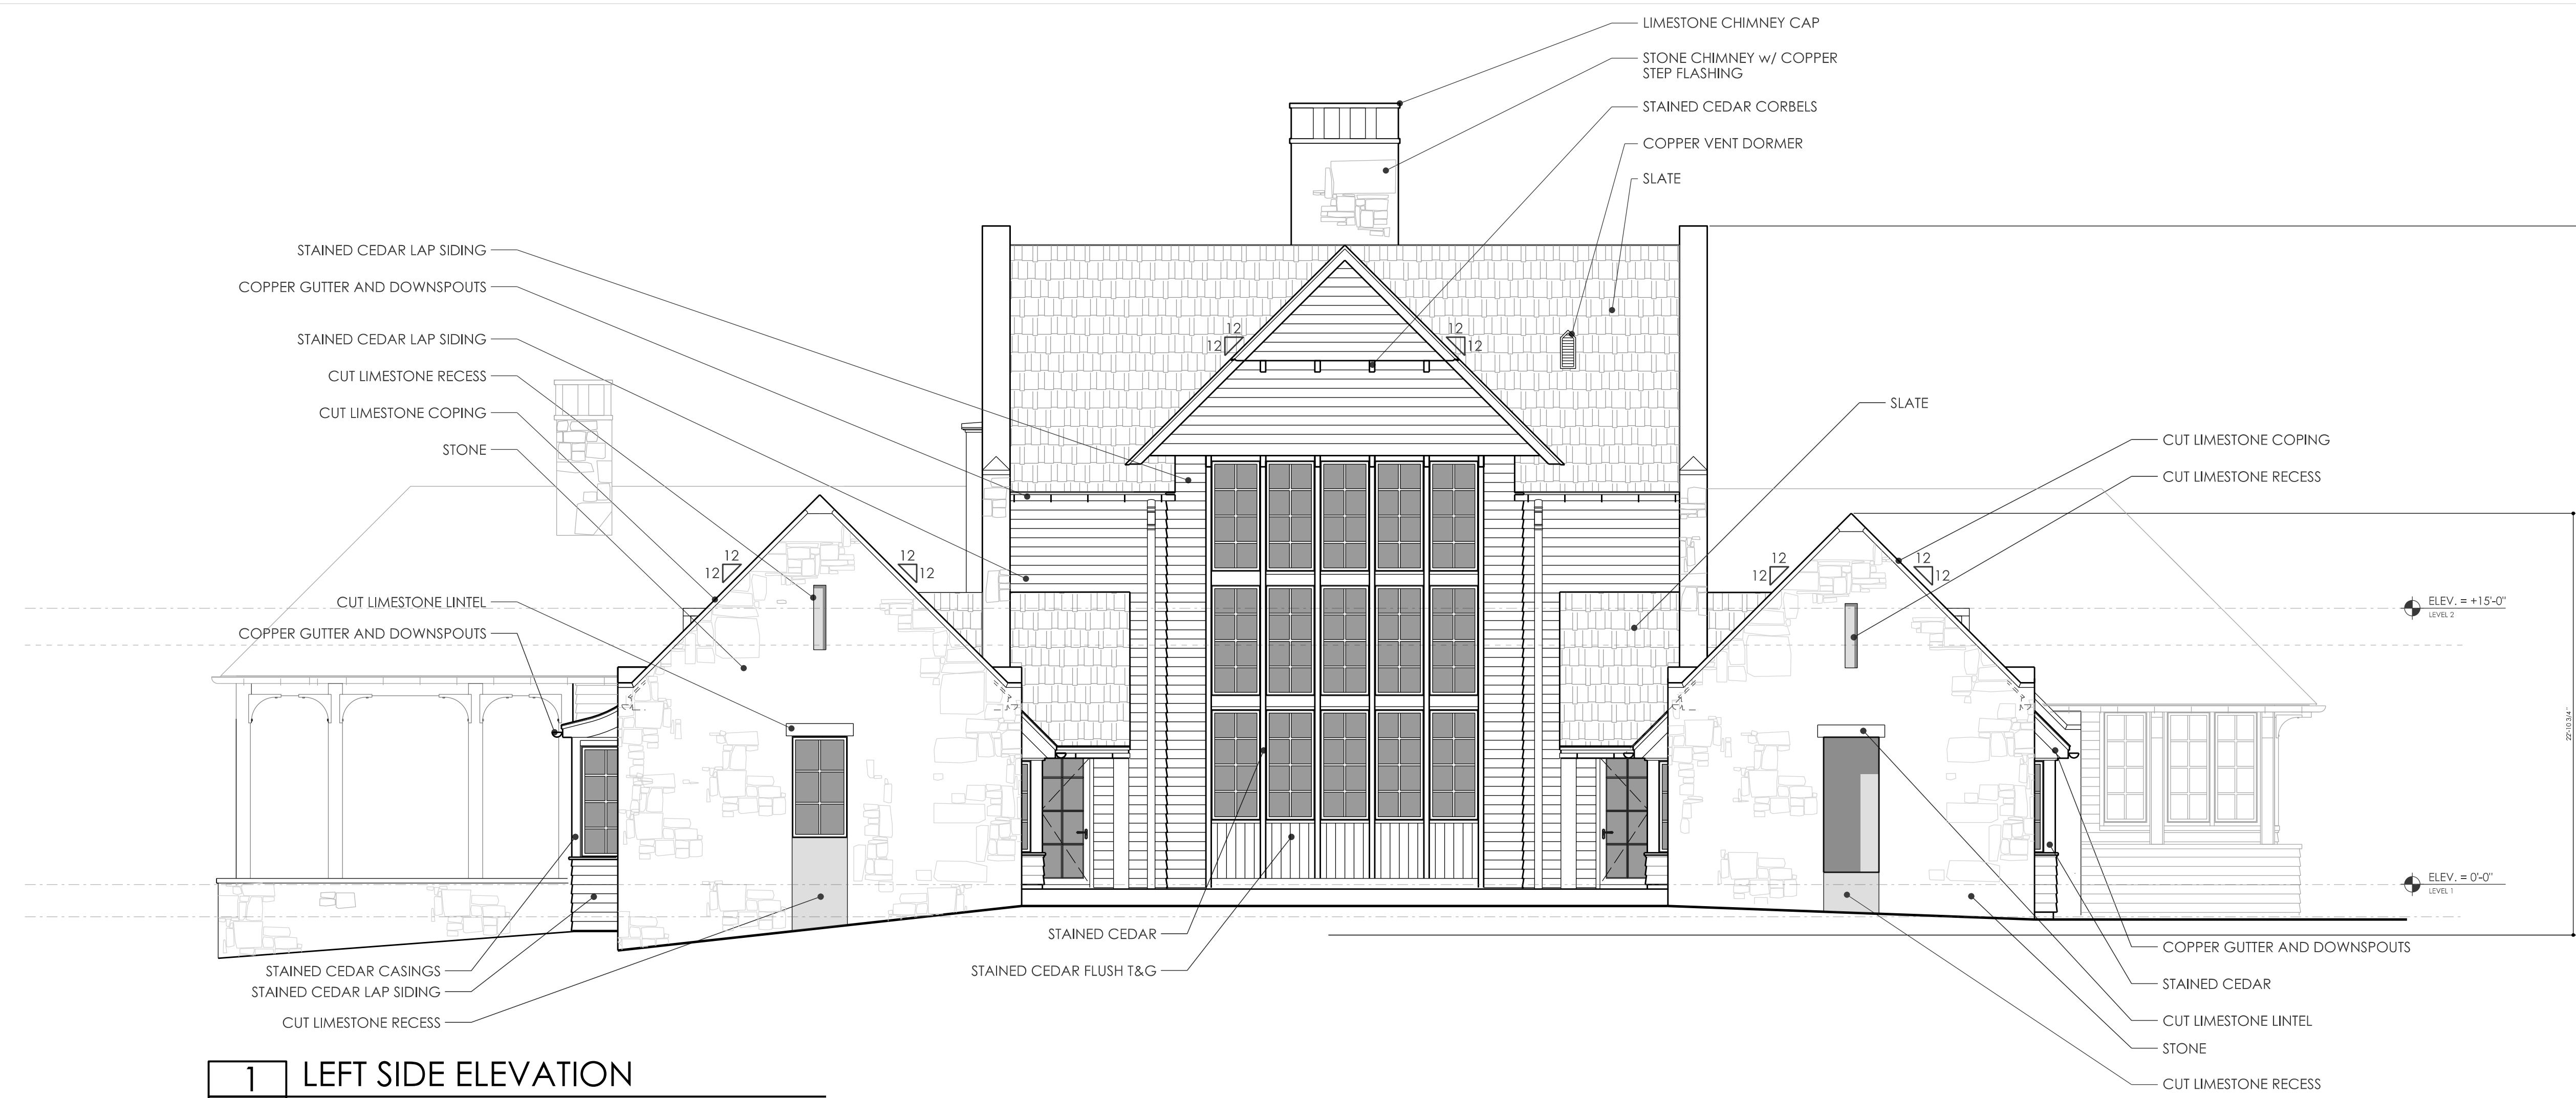
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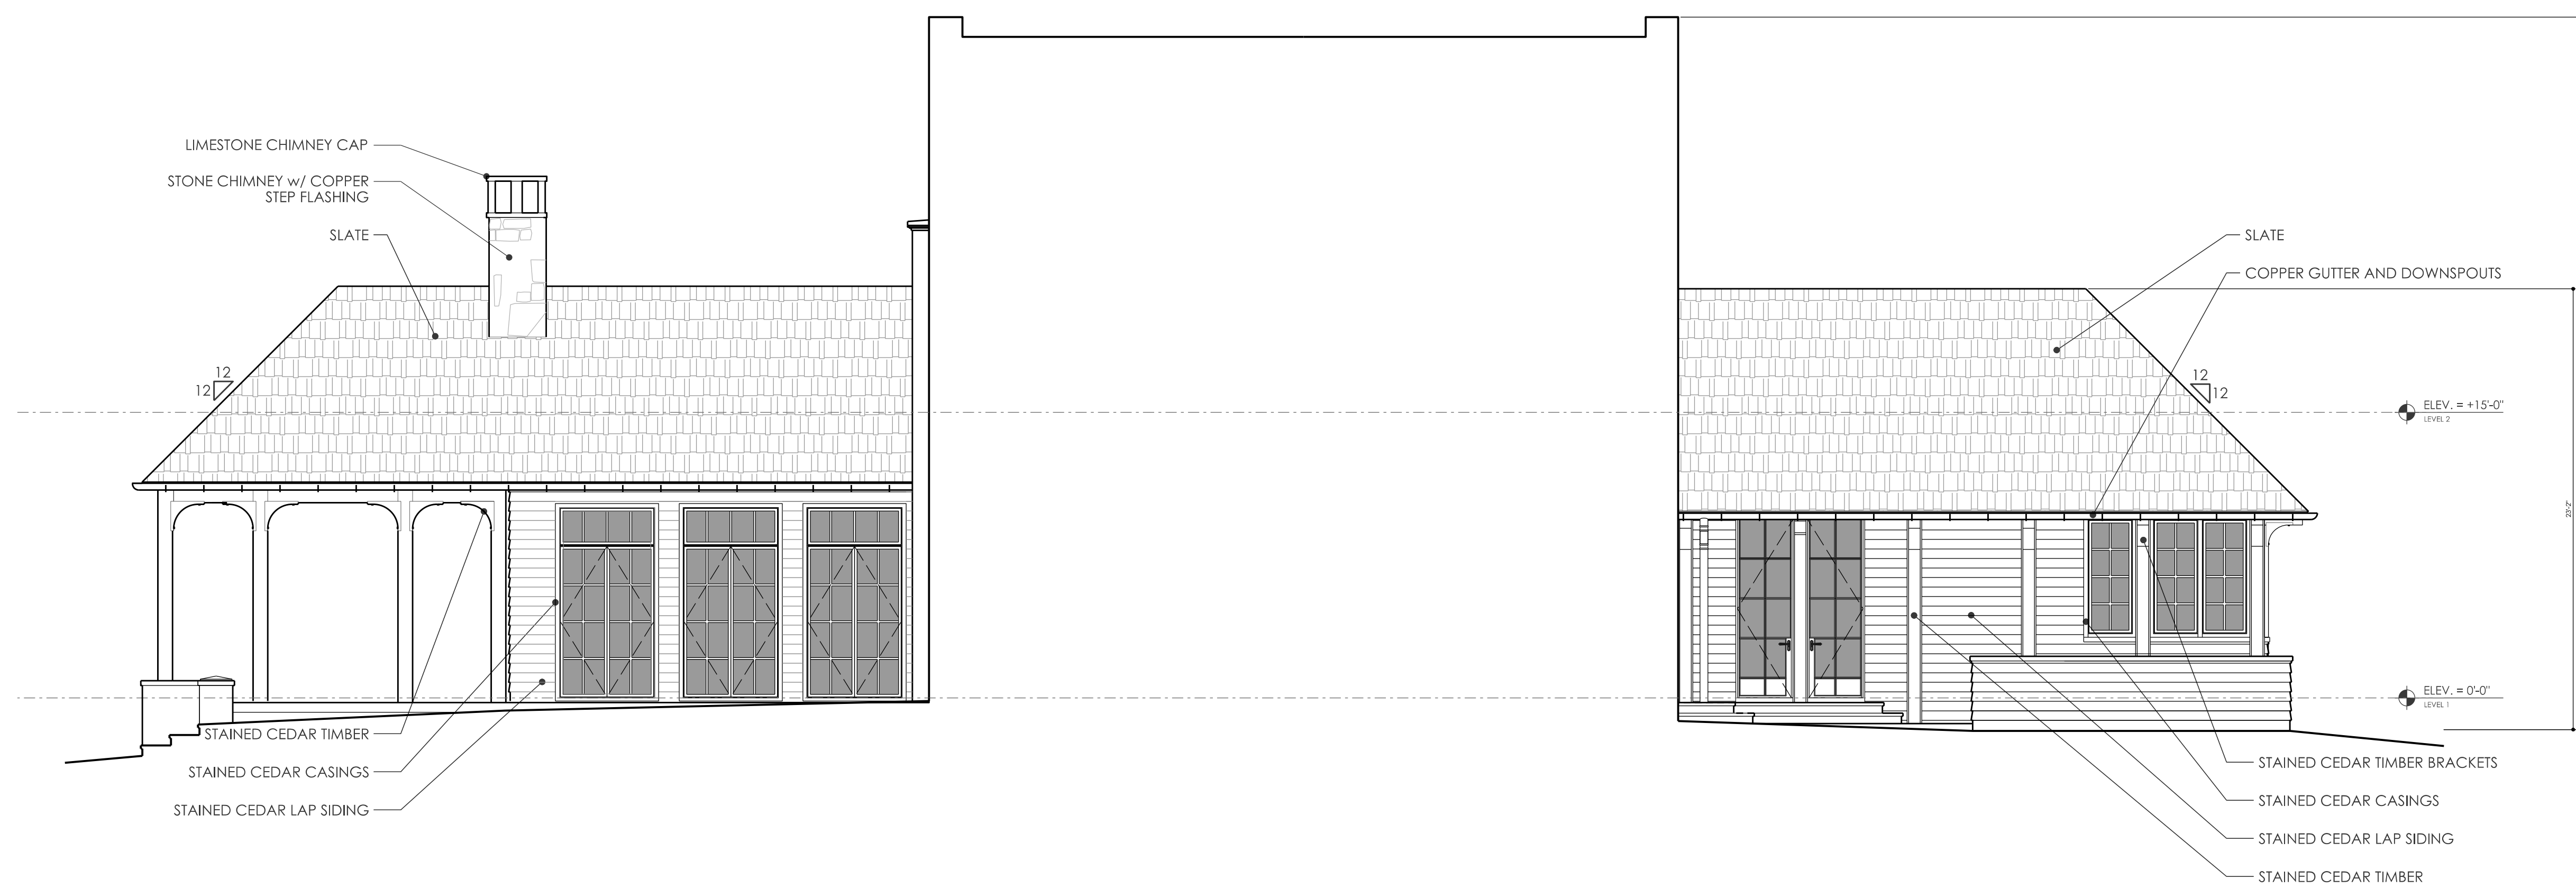
No.	Issue Description	Date
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		05-06-2021
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SHEET NAME
EXTERIOR ELEVATIONS

SHEET NUMBER
A5.1
 COMMENTS
 NOT ISSUED FOR CONSTRUCTION



1 LEFT SIDE ELEVATION
 AS.2 SCALE : 3/16" = 1'-0"



2 COURTYARD ELEVATION (FACING RIGHT)
 AS.2 SCALE : 3/16" = 1'-0"

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9.1	Window Pricing	08-05-2021
10	Structural Export	08-18-2021
12	ZONING APPLICATION	08-30-2021


SHEET NAME
EXTERIOR ELEVATIONS

SHEET NUMBER
A5.2

COMMENTS
 NOT ISSUED FOR CONSTRUCTION



1 REAR ELEVATION
AS.3 SCALE : 3/16" = 1'-0"

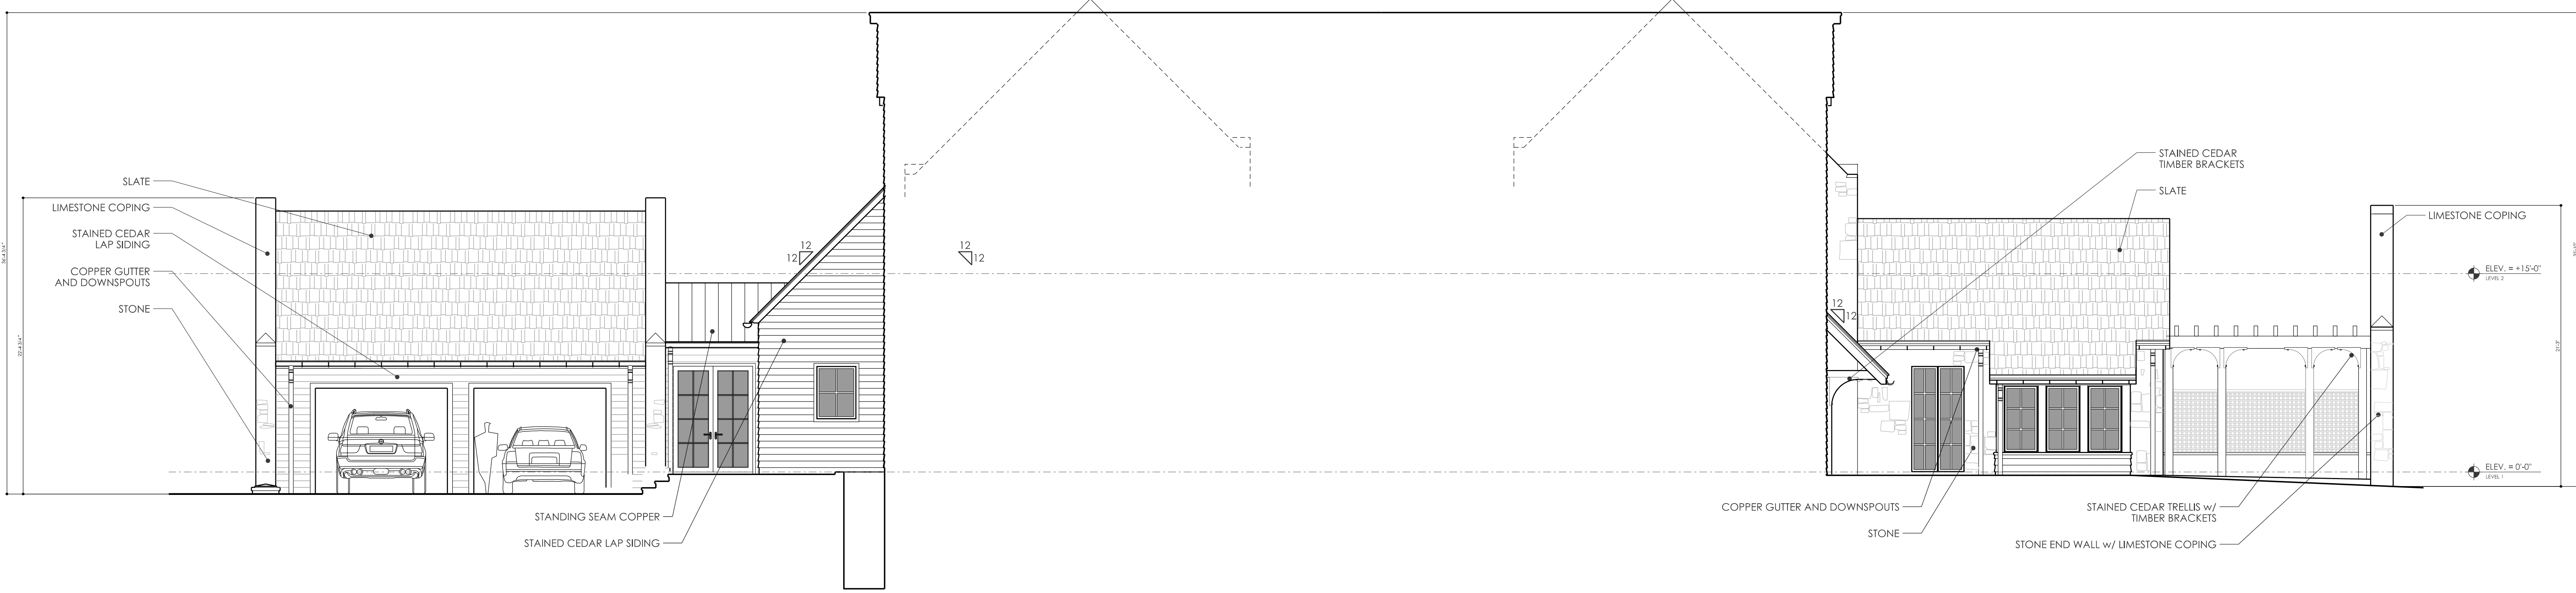

2 COURTYARD ELEVATION (FACING FRONT)
AS.3 SCALE : 3/16" = 1'-0"

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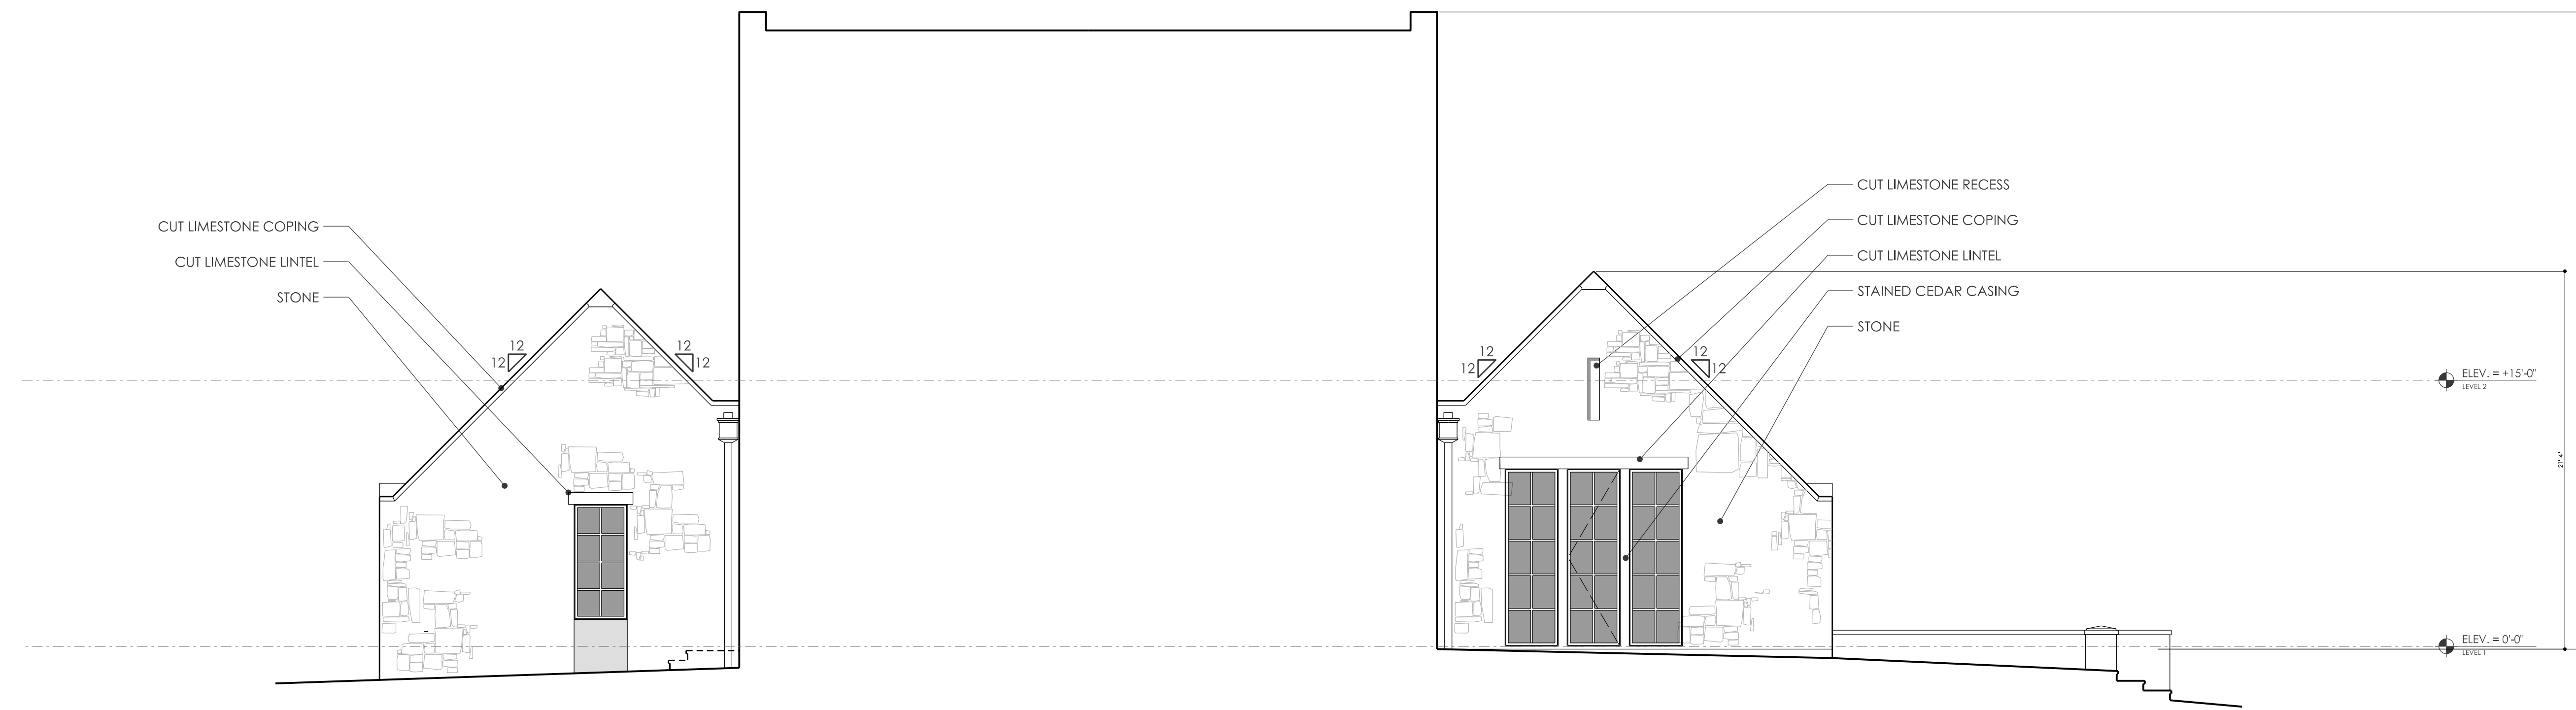
SHEET NAME
EXTERIOR ELEVATIONS

SHEET NUMBER
A5.3

COMMENTS
 NOT ISSUED FOR CONSTRUCTION



1 RIGHT SIDE ELEVATION
A5.4 SCALE: 3/16" = 1'-0"



2 COURTYARD ELEVATION (FACING LEFT)
A5.4 SCALE: 3/16" = 1'-0"

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SHEET NAME
EXTERIOR ELEVATIONS

SHEET NUMBER
A5.4
COMMENTS
NOT ISSUED FOR CONSTRUCTION



JOEL KELLY DESIGN

Proposed Exterior Materials for Weilbaecher Residence

414 Vanderbilt Rd.
Biltmore Forest, NC

Example of exterior stone, limestone coping:



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Example of wood siding:

(Image also shows copper standing seam, cedar shingle roofing alternate):



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Example of slate roofing:



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